


BURSILL STREET

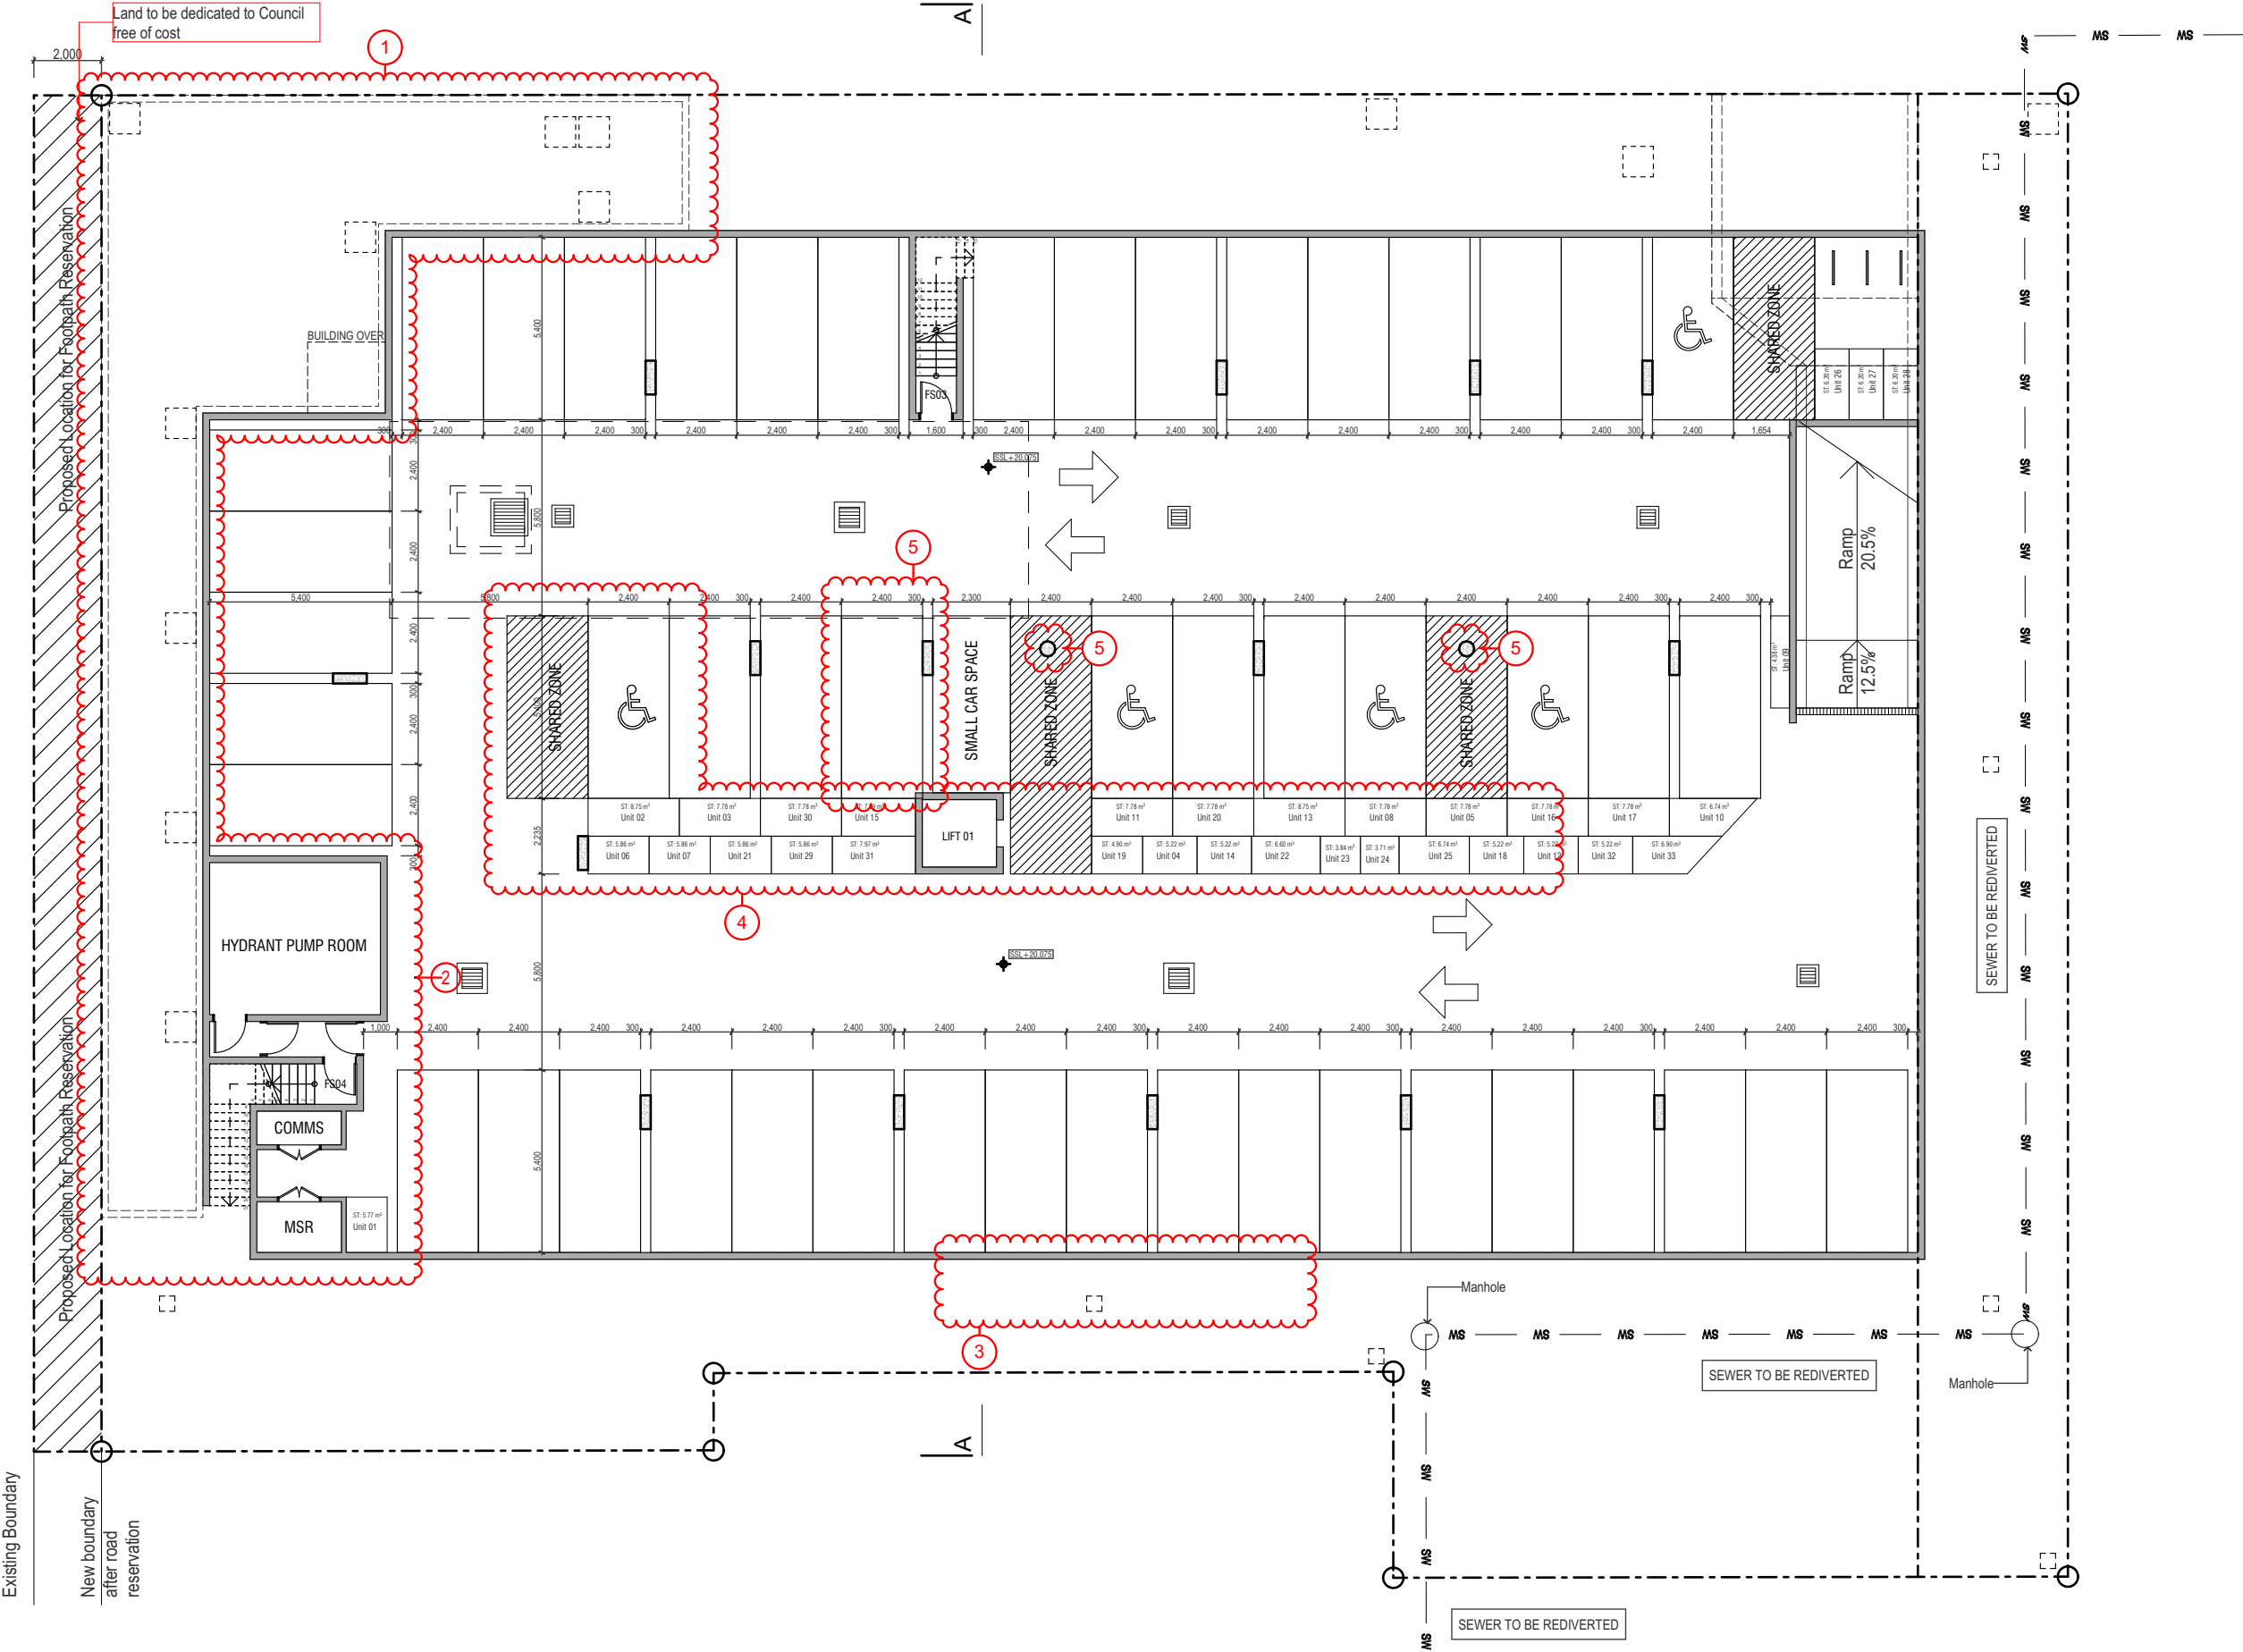

- AMENDMENTS:**
- BASEMENT:**
1. - STORMWATER O.S.D. CONCEPT AMENDED;
 2. - SERVICE ROOMS IN S.W. CORNER ADDED;
 3. - SOUTH FIRE STAIR REMOVED;
 4. - STORAGE, LIFT + CIRCULATION AMENDED; BASEMENT NOW ONE LEVEL;
 5. - SMALL CAR SPACE REPLACED WITH STANDARD DIMENSION CAR SPACE; STRUCTURAL COLUMNS IN SHARED ZONES NOW CYLINDRICAL TO ALLOW ACCESS UNLOADING;



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info@mackenziearchitects.com.au

File Path: P:\Cad Files\Bursill St 78, 80 & 84, Guildford\05 Model
PROJECTED: 2018/11/29, 78-84 Bursill St, Guildford - Section 95 Model
PM amended
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B
A
Basement amendments due to Council's R.F.I.
Section 4.56 Modification Application


J.T.
J.T.
12/12/2018
15/08/2018
INT DATE



PROJECT ADDRESS
**78, 80 & 84 Bursill St,
Guildford, NSW, 2161**
PROJECT NO. STATUS
17/14 S.96
DRAWN BY CHECKED BY

DRAWING:
Basement Floor Plan
SCALE: 1:100@A1
1:200@A3
DRAWING NO.: **A2.2**
ISSUE: **B**
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BURSILL STREET

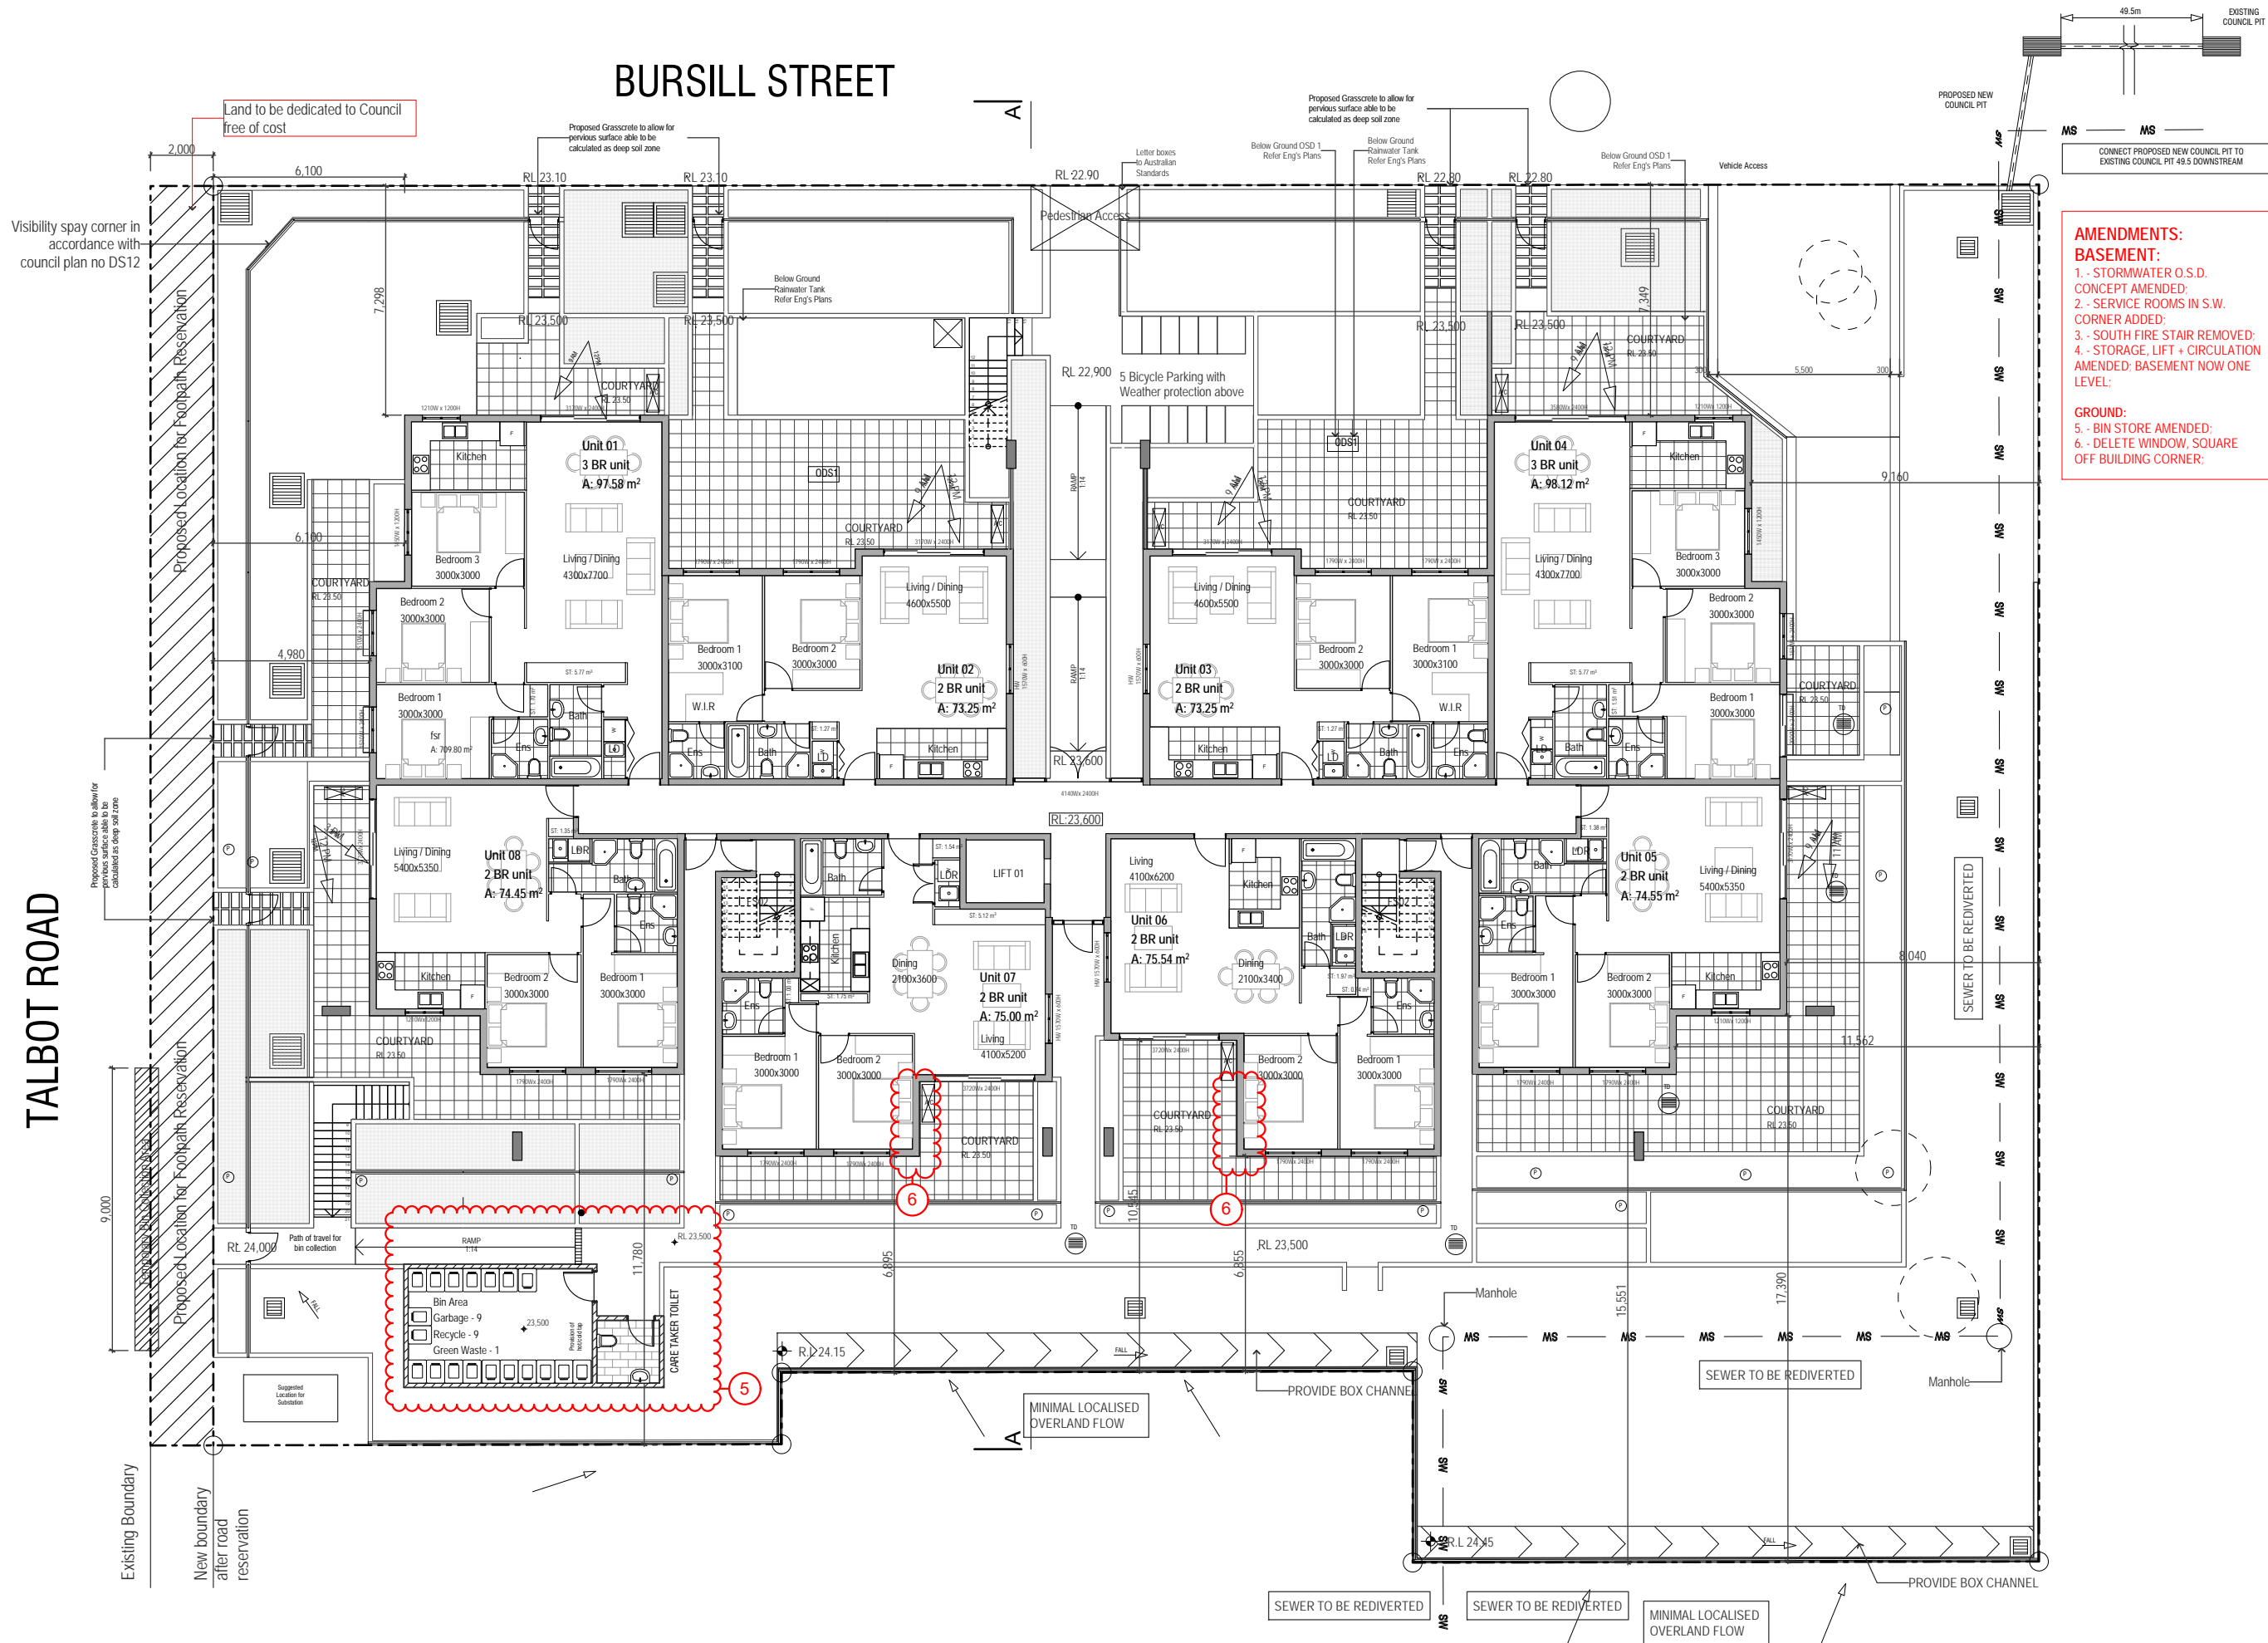

BASIX Commitments

Water Commitments

- Fixtures**
- Must install min 3 Star rating showerheads in all showers. (> 4.5 but <= 6l/min)
 - Must install min 5 Star rating toilet flushing system in each toilet
 - Must install min 5 Star rating taps in each bathroom

Energy Commitments

Hotwater

Must install gas instantaneous 5 star system for each unit
Cooling/Heating System
Must install 1-phase airconditioning 3 star (new rating) zoned in the living and bedroom areas of each unit.

Ventilation

Must install exhaust systems in:
Bathrooms, for all units: individual fan, ducted to facade or roof; Operation control: Manual switch on/off.
Kitchens, for units 1, 4, 5, 8, 9, 12, 13, 16, 22, 26, 30, 33: individual fan, not ducted; Operation control: Manual switch on/off. For units 2, 3, 6, 7, 10, 11, 14, 15, 17, 18, 19, 20, 21, 23, 24, 26, 27, 28, 29, 31, 32: Individual fan, ducted to facade or roof; Operation control: Manual switch on/off. Laundry, for all units: Individual fan ducted to facade or roof; Operation control: Manual switch on/off.

Other

Must install gas cooktop and electric oven in the kitchen and a well ventilated fridge space in all units.
Must install an indoor or sheltered clothes drying line in all units.
Lighting
Must provide dedicated artificial lighting for kitchens, bathrooms, laundry and hallways for all units and 1 bedroom for units: 18, 19, 20, 27, 28. 2 bedrooms for units: 2, 3, 5, 6, 7, 8, 10, 11, 13, 14, 15, 16, 17, 21, 22, 23, 24, 25, 26, 29, 30, 31, 33. 3 bedrooms for units: 1, 4, 9, 12.

Common Areas

Energy Commitments

Ventilation

Must install exhaust system in: All carpark areas; Supply + Exhaust; Efficiency measure: carbon monoxide monitor + VSD fan. Garbage Room: Ventilation Exhaust only.
Lighting
-Must install Lighting in: all carpark areas; Efficiency measure: Daylight sensor.
-Must install lighting in: All lobbies; Fluorescent; Efficiency measure; Manual on/timer off. Must install lighting in: Lift car: Fluorescent; Efficiency measure; Connected to lift call button.

Water Commitments

Fixtures

- Must install min 4 Star rating toilet flushing system in each toilet.
- Must install min 5 Star rating taps

Water Commitments

Fixtures

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- Must install min 5 Star rating taps

Water Commitments

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Water Commitments

Fixtures

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- Must install min 5 Star rating taps

Water Commitments

Fixtures


- Must install min 4 Star rating toilet flushing system in each toilet.
- Must install min 5 Star rating taps

Water Commitments

Fixtures

- Must install min 4 Star rating toilet flushing system in each toilet.
- Must install min 5 Star rating taps

BURSILL STREET

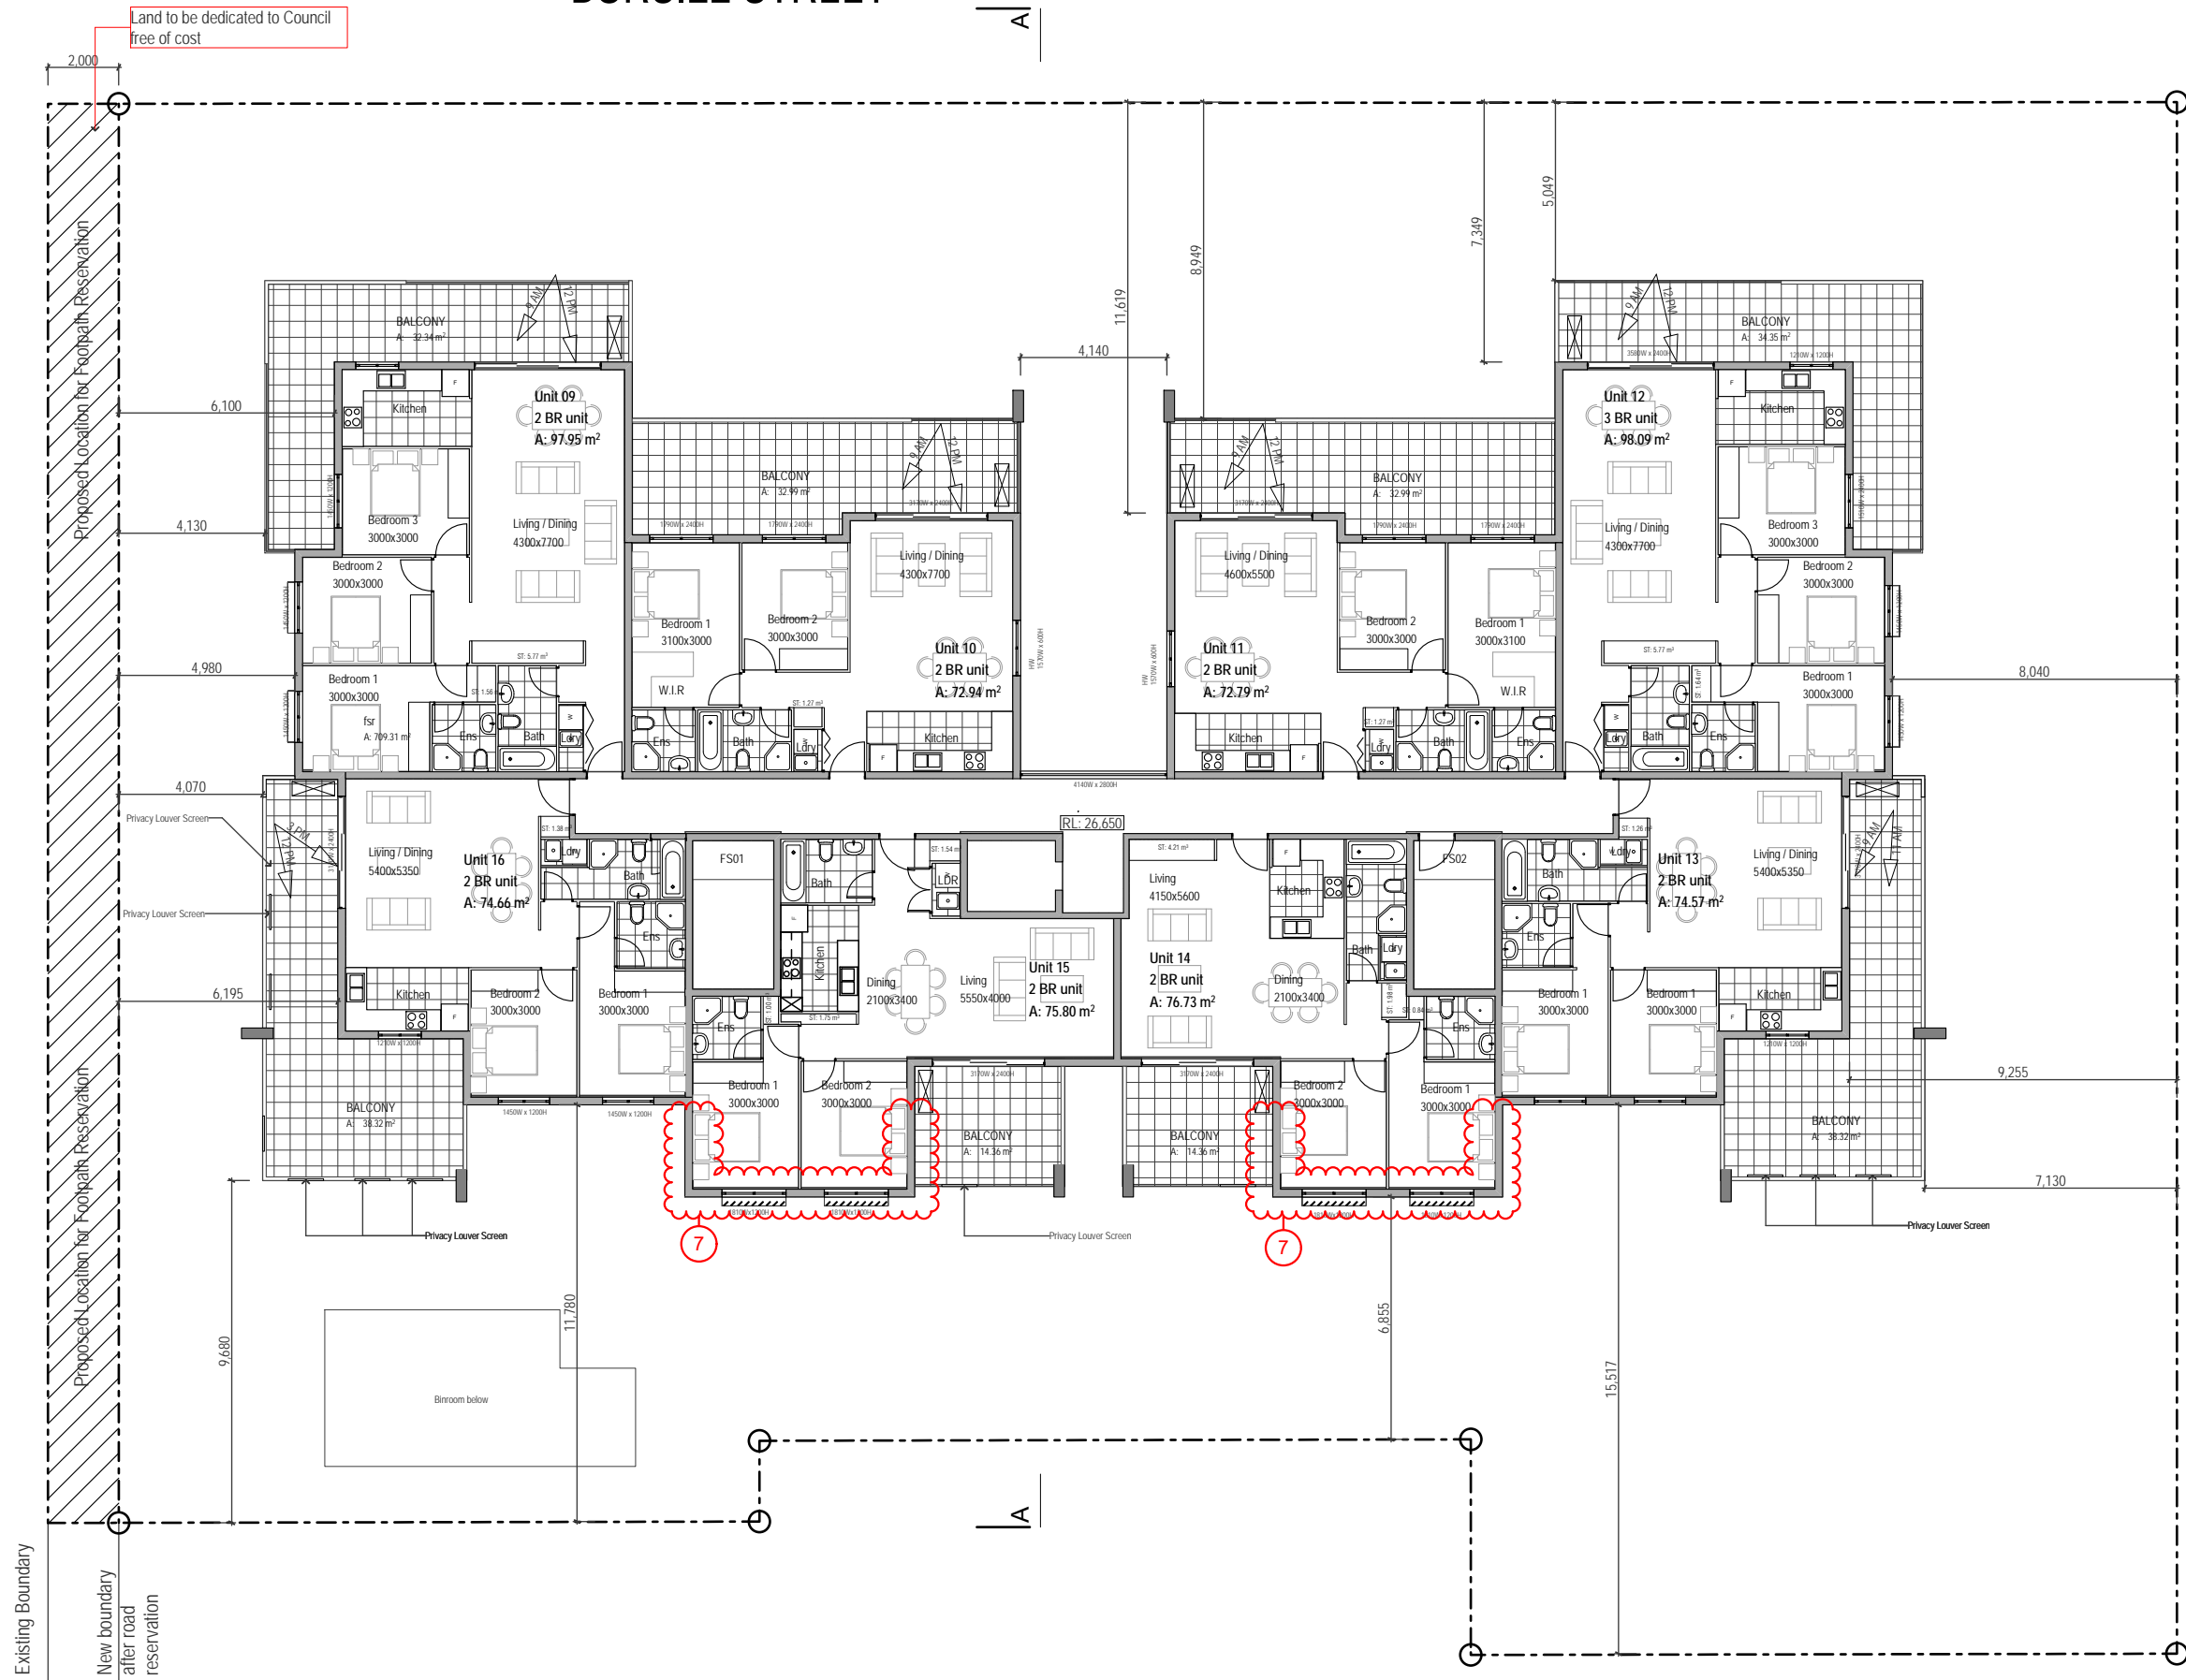

AMENDMENTS:

BASEMENT:

1. - STORMWATER O.S.D.
2. - SERVICE ROOMS IN S.W. CORNER ADDED:
3. - SOUTH FIRE STAIR REMOVED:
4. - STORAGE, LIFT + CIRCULATION

GROUND:

5. - BIN STORE AMENDED:
6. - DELETE WINDOW, SQUARE OFF BUILDING CORNER:

FIRST; SECOND; THIRD:

7. - DELETE BEDROOM 1 WINDOW, MOVE BEDROOM 2 WINDOW, SQUARE OFF BUILDING CORNER:

BASIX Commitments

Water Commitments

Fixtures

- Must install min 3 Star rating showerheads in all showers. (> 4.5 but <= 6l/min)
- Must install min 5 Star rating toilet flushing system in each toilet
- Must install min 5 Star rating taps in each bathroom

Energy Commitments

Hotwater

Must install gas instantaneous 5 star system for each unit

Cooling/Heating System

Must instal 1-phase airconditioning 3 star (new rating) zoned in the living and bedroom areas of each unit.

Ventilation

Must install exhaust systems in: Bathrooms, for all units: individual fan, ducted to facade or roof; Operation control: Manual switch on/off.

Kitchens, for units

1,4,5,8,9,12,13,16,22,26,30,33:individual al fan, not ducted: Operation Control:Manual switch on/off. For units

2,3,6,7,10,11,14,15,17,18,19,20,21,23,24,26,27,28,29,31,32: Individual fan, ducted to facade or roof; Operation control: Manual swithc on/pff. Laundry, for all units : Individual fan ducted to facade or roof; Opearaion control: Manual switch on/off/

Other

Must install gas cooktop and electric oven in the kitchen and a well ventilated fridge space in all units. Must install an indoor or sheltered clothes drying line in al units.

Lighting

Must provide dedicated artificial lighting for kitchens, bathrooms, laundry and hallways for all units and 1 bedroom for units: 18,19,20,27,28. 2 bedrooms for units:

2,3,5,6,7,8,10,11,13,14,15,16,17,21,22,23,24,25,26,29,30,31,33. 3 bedrooms for units: 1,4,9,12.

Common Areas

Energy Commitments

Ventilation

Must install exhaust system in; All carpark areas; Supplu + Exhaust; Efficiency measure: carbon monoxide monitor + VSD fan. Garbase Room: Ventilation Exhasut only.

Lighting

-Must install Lighting in; all carpark areas; Efficiency measure: Daylight sensor.

-Must install lighting in; All lobbies; Fluorescent; Efficiency measure; Manual on/timer off. Must install lighting in: Lift car: Fluorescent; Efficiency measure; Connected to lift call button.

Water Commitments

Fixtures

- Must install min 4 Star rating toilet flushing system in each toilet.
- Must install min 5 Star rating taps

Note:

Wall Construction

All External Walls Hebal Construction
All Internal Walls Platerboard on studs

Floor Construction

Floor Slabs in concrey

Roof Construction

Metal Clad



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ARCHITECTURE\2018\03\09_78-84 Bursill St, Guildford - Section No Model
2018\02\09
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Section 4.56 Modification Application
DETAILS

J.T. INT DATE



PROJECT ADDRESS
**78, 80 & 84 Bursill St,
Guildford, NSW, 2161**

PROJECT NO.
17/14

STATUS
S.96

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CHECKED BY

DRAWING:
First Floor Plan


SCALE:
1:100@A1
1:200@A3

DRAWING NO.:
A2.4

ISSUE:
A

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BURSILL STREET

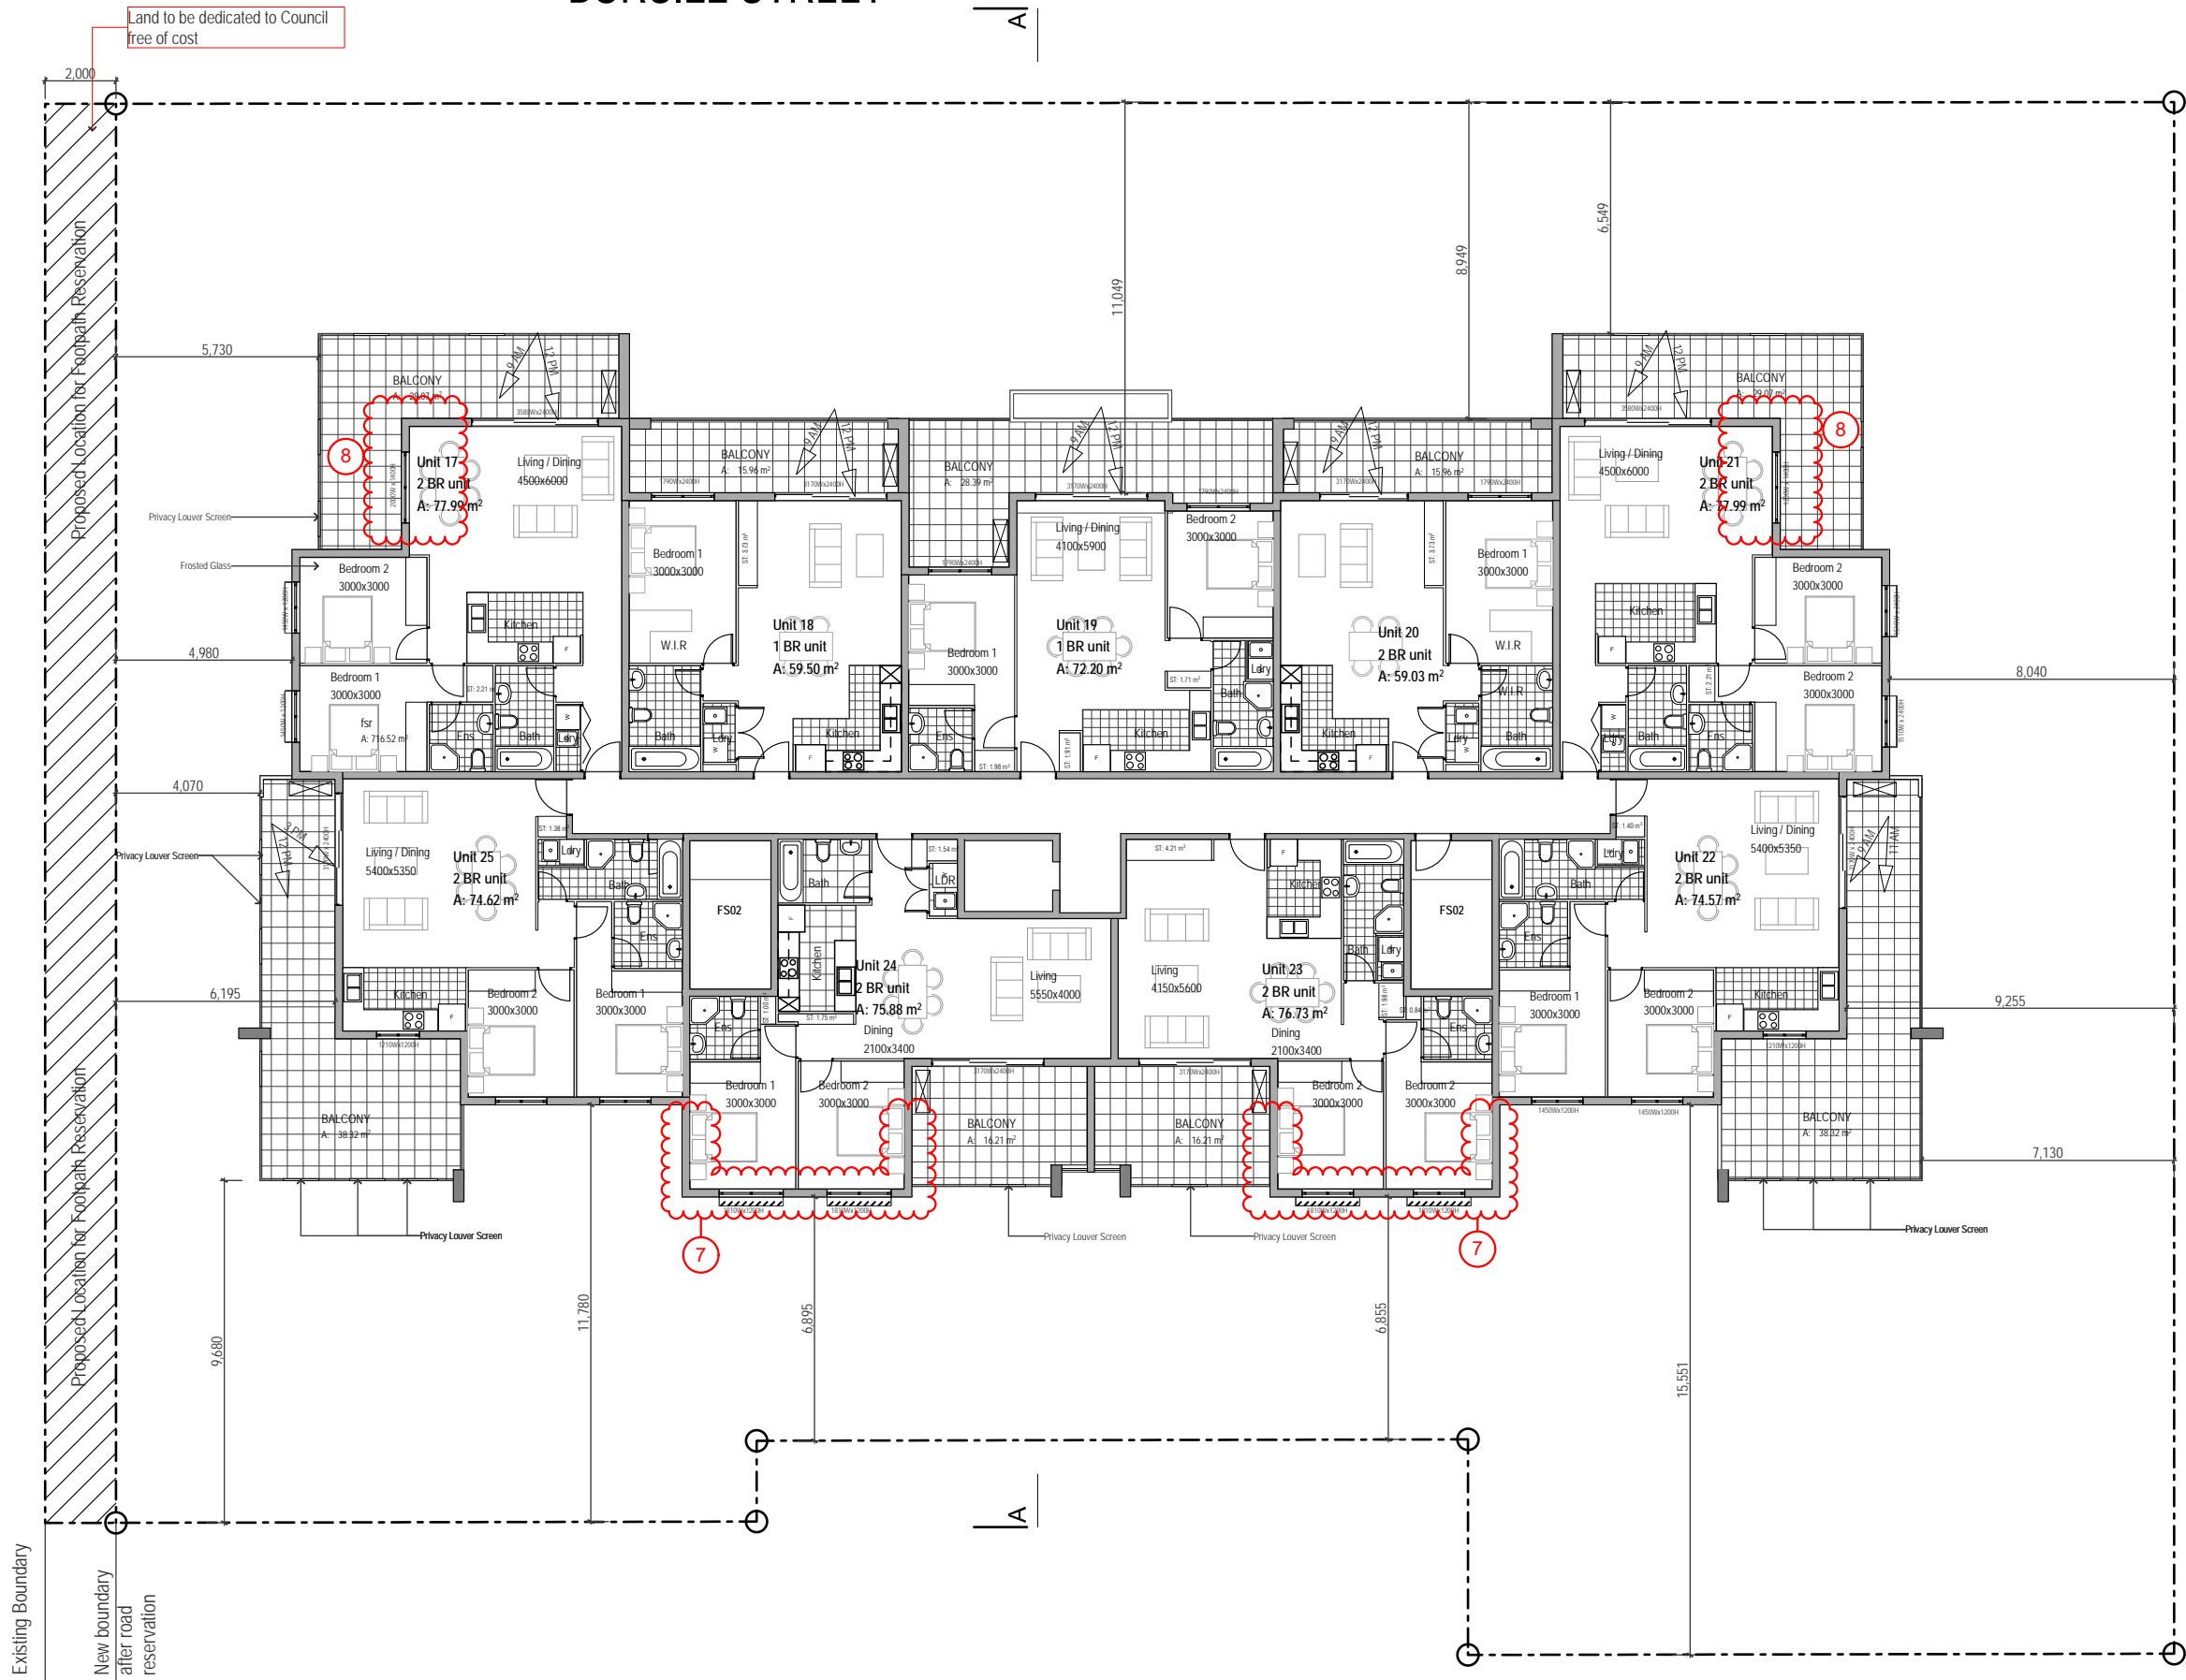

AMENDMENTS:

BASEMENT:

1. - STORMWATER O.S.D. CONCEPT AMENDED;
2. - SERVICE ROOMS IN S.W. CORNER ADDED;
3. - SOUTH FIRE STAIR REMOVED;
4. - STORAGE, LIFT + CIRCULATION AMENDED: BASEMENT NOW ONE LEVEL;

GROUND:

5. - BIN STORE AMENDED;
6. - DELETE WINDOW, SQUARE OFF BUILDING CORNER;

FIRST; SECOND; THIRD:

7. - DELETE BEDROOM 1 WINDOW, MOVE BEDROOM 2 WINDOW, SQUARE OFF BUILDING CORNER;

SECOND; THIRD:

8. - CONSOLIDATE WINDOWS INTO ONE WINDOW;

BASIX Commitments

Water Commitments

Fixtures

- Must install min 3 Star rating showerheads in all showers. (> 4.5 but <= 6/min)
- Must install min 5 Star rating toilet flushing system in each toilet
- Must install min 5 Star rating taps in each bathroom

Energy Commitments

Hotwater

Must install gas instantaneous 5 star system for each unit

Cooling/Heating System

Must instal 1-phase airconditioning 3 star (new rating) zoned in the living and bedroom areas of each unit.

Ventilation

Must install exhaust systems in:

Bathrooms, for all units: individual fan, ducted to facade or roof; Operation control: Manual switch on/off.

Kitchens, for units

1,4,5,8,9,12,13,16,22,26,30,33:individual al fan, not ducted: Operation Control:Manual switch on/off. For units

2,3,6,7,10,11,14,15,17,18,19,20,21,23, 24,26,27,28,29,31,32: Individual fan,

ducted to facade or roof; Operation control: Manual swithc on/pff. Laundry, for all units : Individual fan ducted to facade or roof; Operation control:

Manual switch on/off/ Other

Must intall gas cooktop and electric oven in the kitchen and a well ventilated fridge space in all units.

Must install an indoor or sheltered clothes drying line in al units.

Lighting

Must provide dedicated artificial lighting for kitchens, bathrooms, laundry and hallways for all units and 1

bedroom for units: 18,19,20,27,28. 2 bedrooms for units:

2,3,5,6,7,8,10,11,13,14,15,16,17,21,22, 23,24,25,26,29,30,31,33. 3 bedrooms for units: 1,4,9,12.

Common Areas

Energy Commitments

Ventilation

Must install exhaust system in; All carpark areas; Supplu + Exhaust:

Efficiency measure: carbon monoxide monitor + VSD fan. Garbase Room: Ventilation Exhasut only.

Lighting

-Must install Lighting in; all carpark areas; Efficiency measure: Daylight sensor.

-Must install lighting in; All lobbies; Fluorescent; Efficiency measure; Manual on/timer off. Must install lighting in: Lift car: Fluorescent;

Efficiency measure; Connected to lift call button.

Note:

Wall Construction

All External Walls Hebal Construction
All Internal Walls Platerboard on studs

Floor Construction

Floor Slabs in concreye

Roof Constrction

Metal Clad



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ARCHITECTURE\2018\03\09_78-84 Bursill St, Guildford - Section No Model
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Section 4.56 Modification Application

J.T. INT DATE



PROJECT ADDRESS
**78, 80 & 84 Bursill St,
Guildford, NSW, 2161**

PROJECT NO.

17/14

STATUS

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DRAWING:

Second Floor Plan

SCALE:

1:100@A1

1:200@A3

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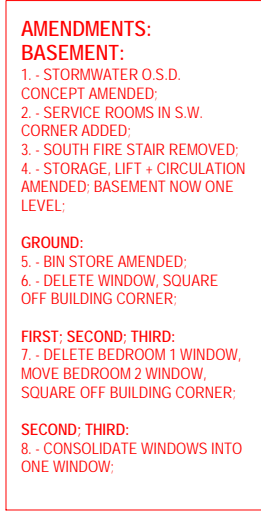
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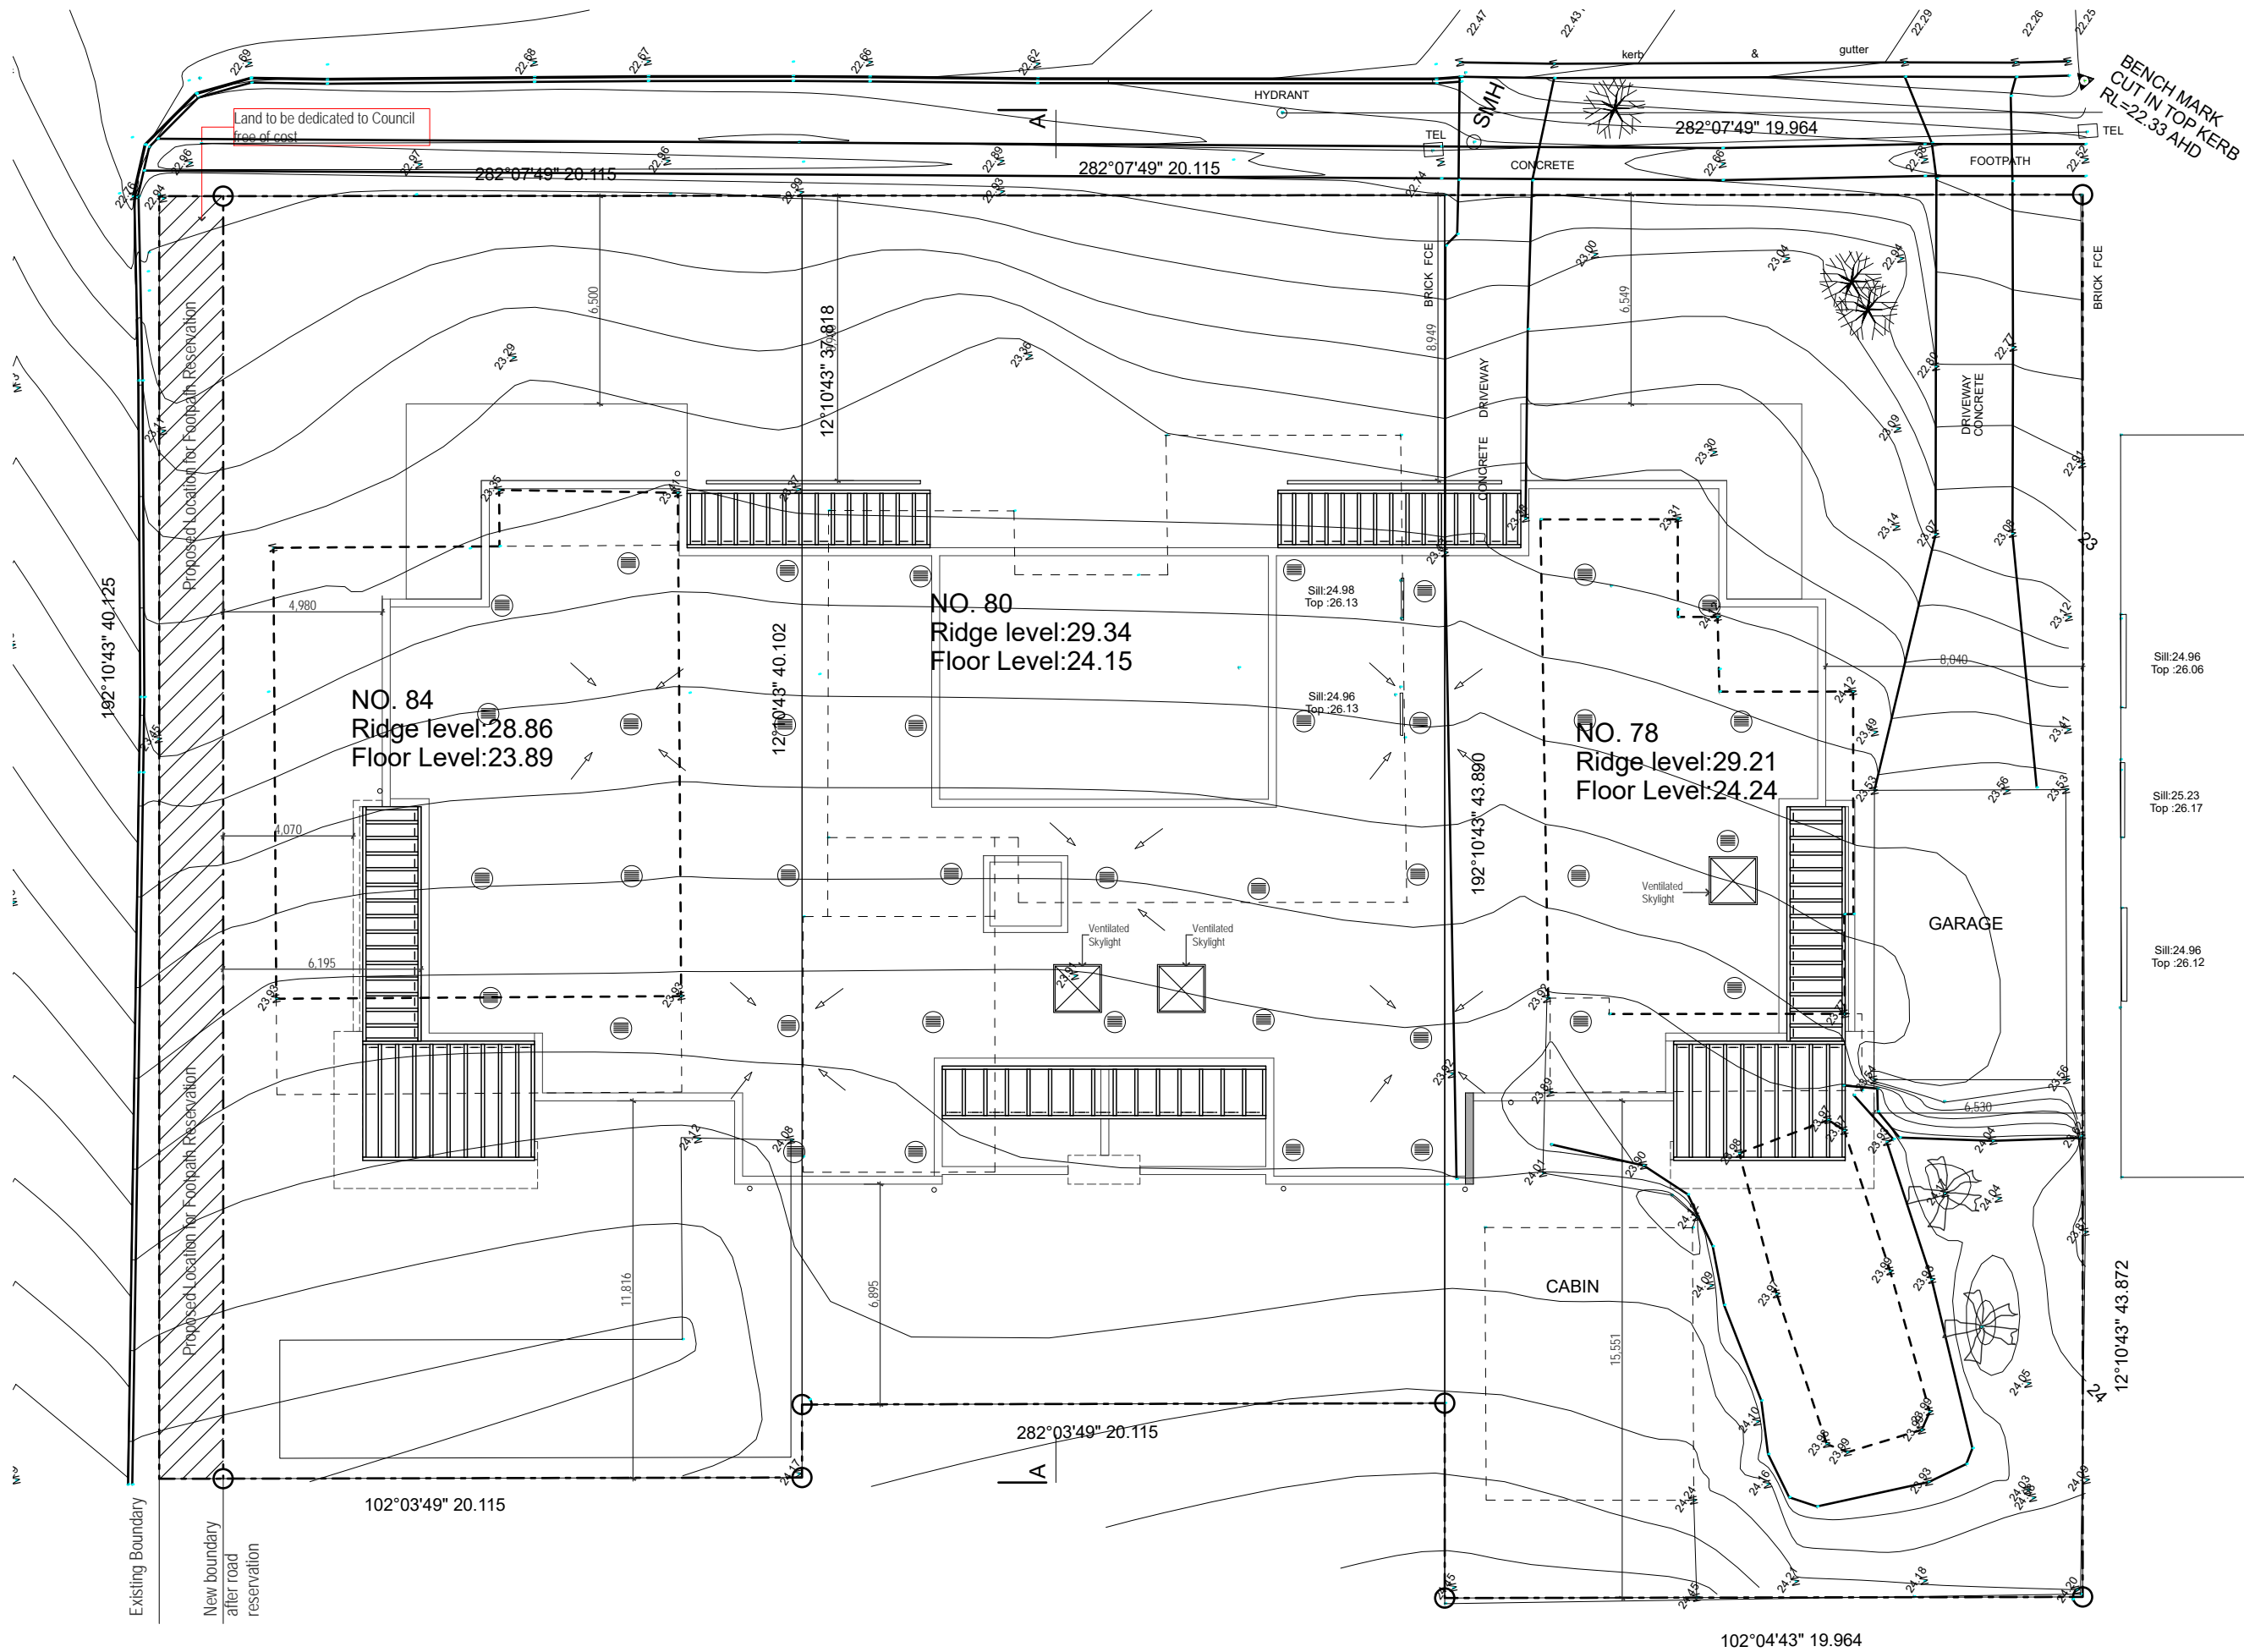
ISSUE:

A

A



Roof Construction
Metal Clad



- AMENDMENTS:**
- BASEMENT:**
1. - STORMWATER O.S.D. CONCEPT AMENDED;
 2. - SERVICE ROOMS IN S.W. CORNER ADDED;
 3. - SOUTH FIRE STAIR REMOVED;
 4. - STORAGE, LIFT + CIRCULATION AMENDED; BASEMENT NOW ONE LEVEL;
- GROUND:**
5. - BIN STORE AMENDED;
 6. - DELETE WINDOW, SQUARE OFF BUILDING CORNER;
- FIRST; SECOND; THIRD:**
7. - DELETE BEDROOM 1 WINDOW, MOVE BEDROOM 2 WINDOW, SQUARE OFF BUILDING CORNER;
- SECOND; THIRD:**
8. - CONSOLIDATE WINDOWS INTO ONE WINDOW;


BASIX Commitments
Water Commitments
Fixtures
- Must install min 3 Star rating showerheads in all showers. (>4.5 but <=6l/min)
- Must install min 5 Star rating toilet flushing system in each toilet
- Must install min 5 Star rating taps in each bathroom

Energy Commitments
Hotwater
Must install gas instantaneous 5 star system for each unit
Cooling/Heating System
Must instal 1-phase airconditioning 3 star (new rating) zoned in the living and bedroom areas of each unit.
Ventilation
Must install exhaust systems in: Bathrooms, for all units: individual fan, ducted to facade or roof; Operation control: Manual switch on/off. Kitchens, for units 1,4,5,8,9,12,13,16,22,26,30,33:individual fan, not ducted: Operation Control:Manual switch on/off. For units 2,3,6,7,10,11,14,15,17,18,19,20,21,23,24,26,27,28,29,31,32: Individual fan, ducted to facade or roof; Operation control: Manual switch on/off. Laundry, for all units : Individual fan ducted to facade or roof; Operaion control: Manual switch on/off/
Other
Must intali gas cooktop and electric oven in the kitchen and a well ventilated fridge space in all units. Must install an indoor or sheltered clothes drying line in al units.
Lighting
Must provide dedicated artificiatl lighting for kitchens, bathrooms, laundry and hallways for all units and 1 bedroom for units:
18,19,20,27,28. 2 bedrooms for units:
2,3,5,6,7,8,10,11,13,14,15,16,17,21,22,23,24, 25,26,29,30,31,33. 3 bedrooms for units:
1,4,9,12.

Common Areas
Energy Commitments
Ventilation
Must install exhaust system in; All carpark areas; Supplu + Exhaust; Efficiency measure; carbon monoxide monitor + VSD fan. Garbase Room: Ventilation Exhasut only.
Lighting
-Must install Lighting in; all carpark areas; Efficiency measure: Daylight sensor.
-Must install lighting in; All lobbies; Fluorescent; Efficiency measure; Manual on/timer off. Must install lighting in: Lift car: Fluorescent; Efficiency measure; Connected to lift call button.

Water Commitments
Fixtures
- Must install min 4 Star rating toilet flushing system in each toilet.
- Must install min 5 Star rating taps

AMENDMENTS:
BASEMENT:
1. - STORMWATER O.S.D. CONCEPT AMENDED;
2. - SERVICE ROOMS IN S.W. CORNER ADDED;
3. - SOUTH FIRE STAIR REMOVED;
4. - STORAGE, LIFT + CIRCULATION AMENDED; BASEMENT NOW ONE LEVEL;
GROUND:
5. - BIN STORE AMENDED;
6. - DELETE WINDOW, SQUARE OFF BUILDING CORNER;
FIRST; SECOND; THIRD:
7. - DELETE BEDROOM 1 WINDOW, MOVE BEDROOM 2 WINDOW, SQUARE OFF BUILDING CORNER;
SECOND; THIRD:
8. - CONSOLIDATE WINDOWS INTO ONE WINDOW;

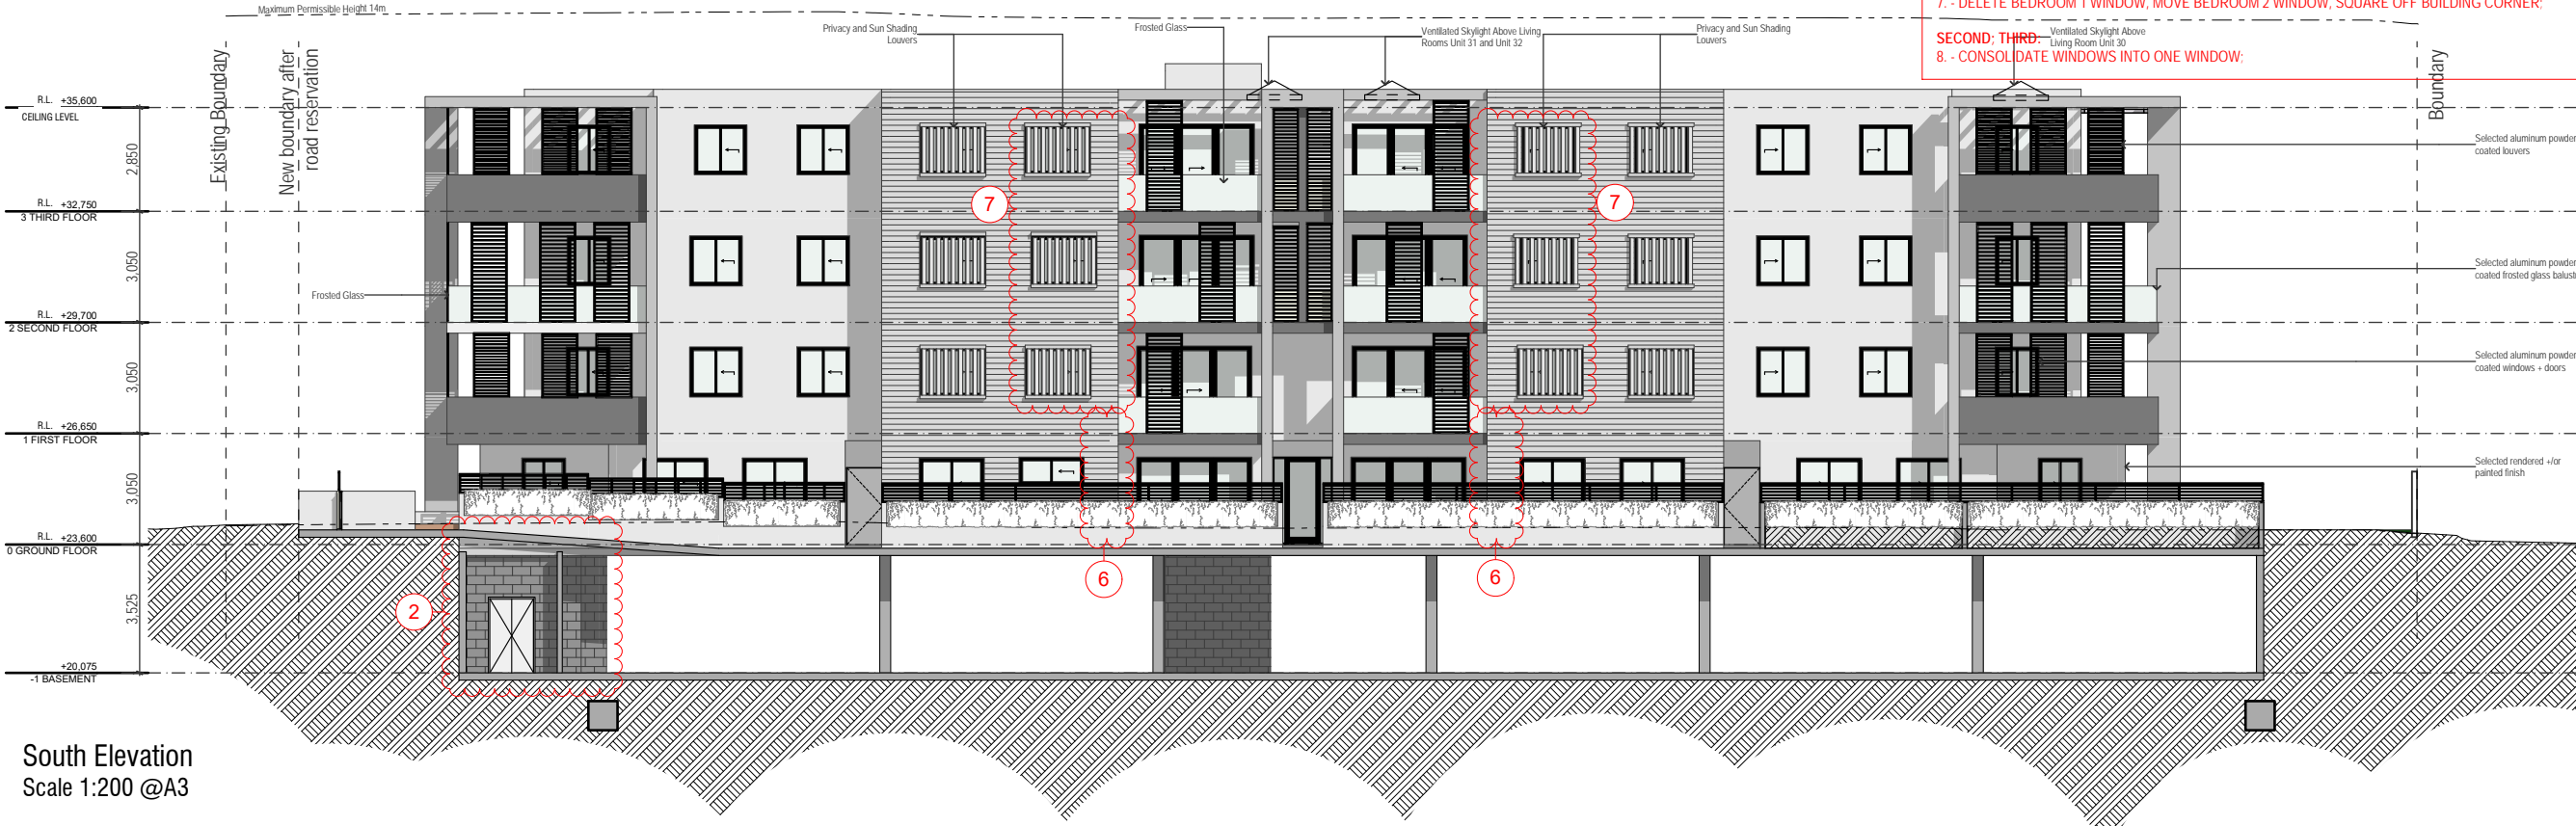

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Nominated Architect No.6033
ABN 76 091 107 201
ACN 091107201

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2018/02/04

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Section 4.56 Modification Application

J.T.

15/08/2018

DATE



PROJECT ADDRESS
78, 80 & 84 Bursill St,
Guildford, NSW, 2161

PROJECT NO.
17/14

STATUS
S.96

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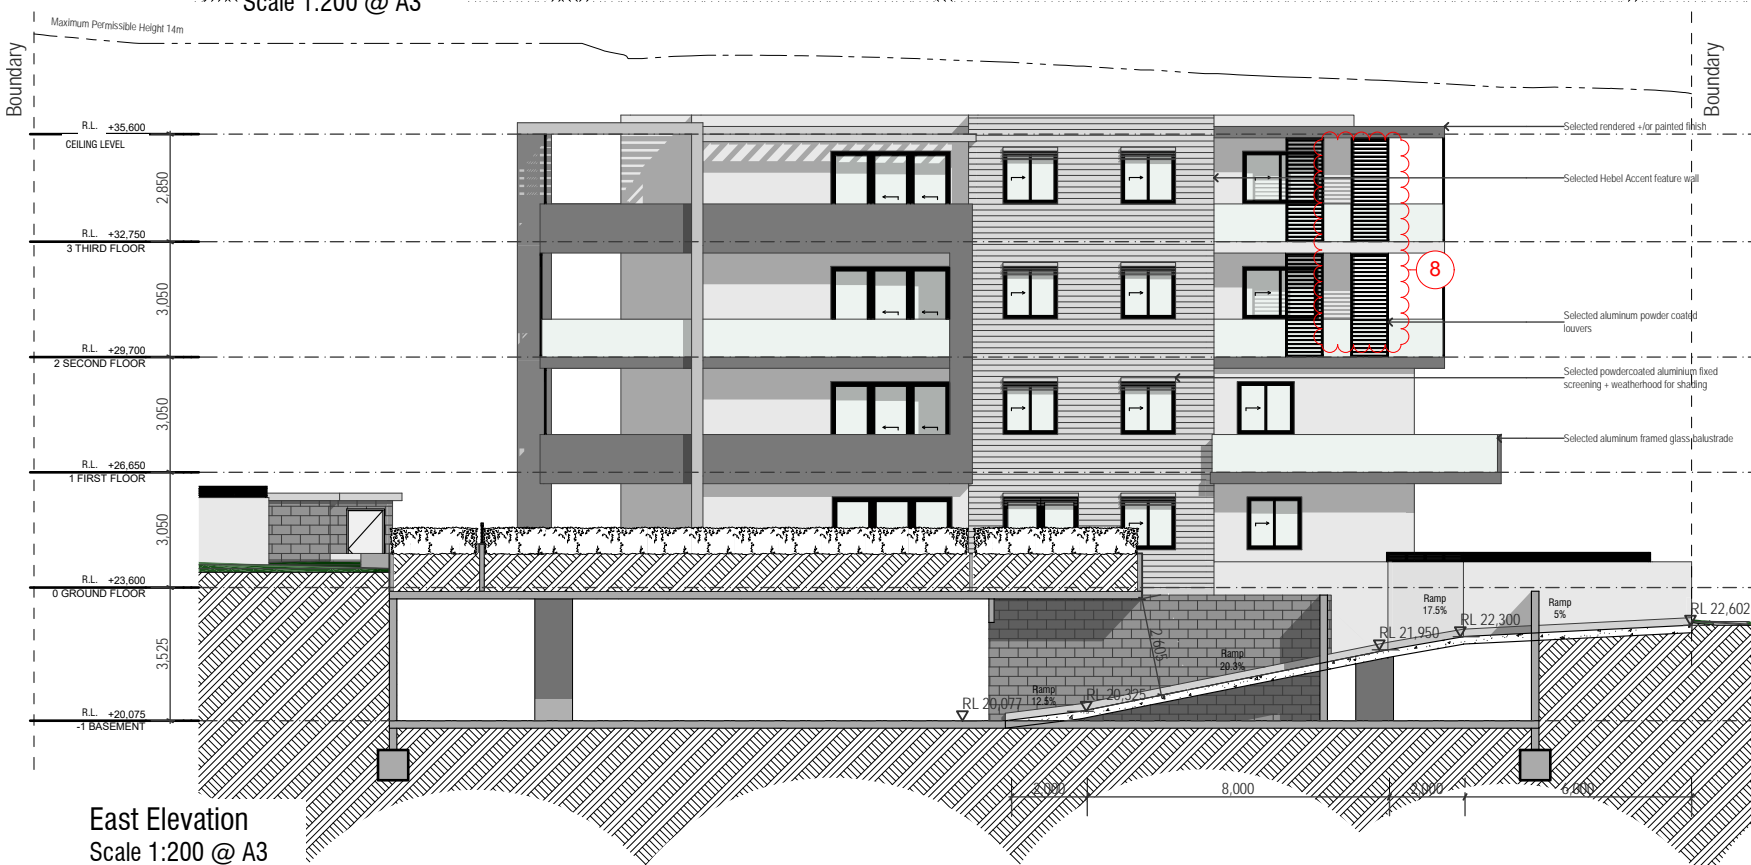
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North and South Elevations

SCALE:
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1:200@A3

DRAWING NO.:
A3.1

ISSUE:
A

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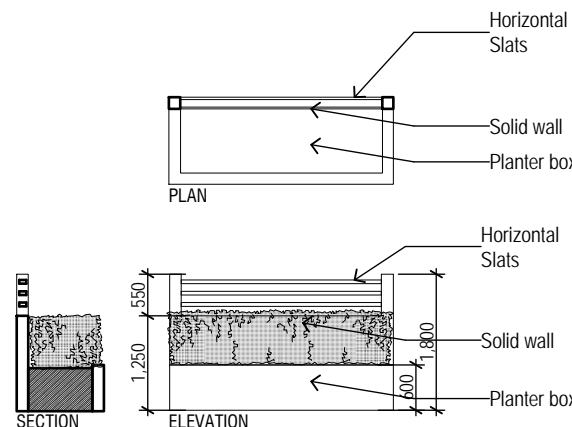
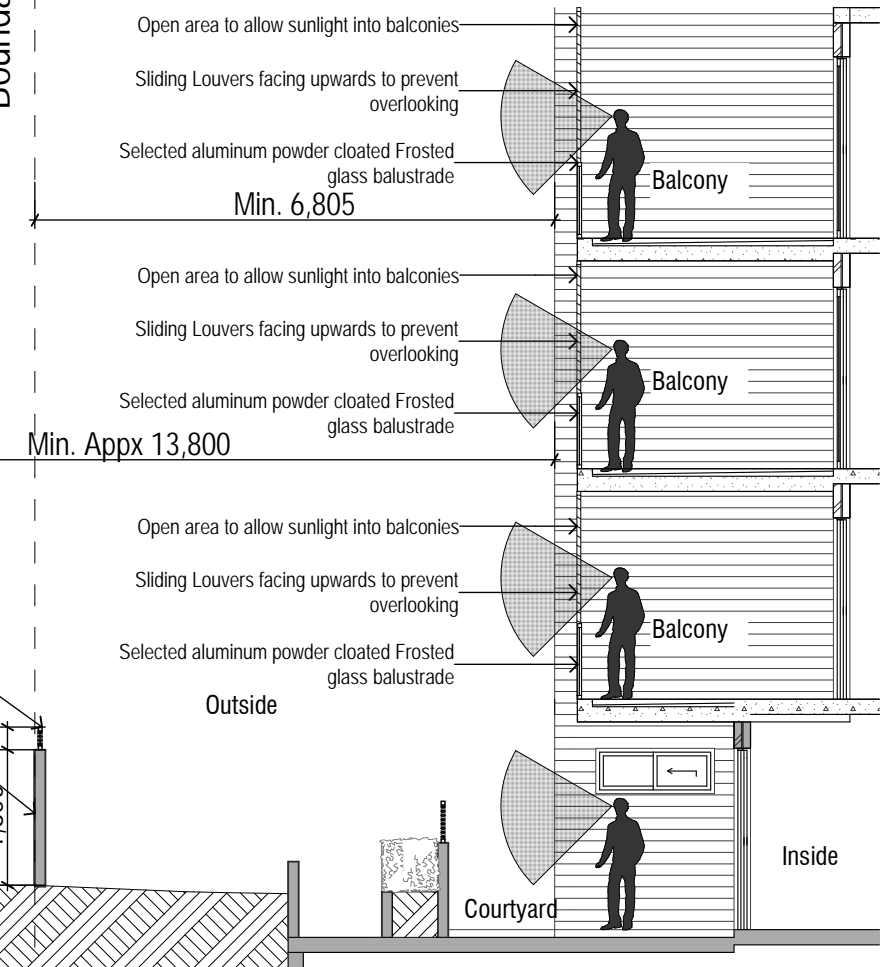
Existing Neighbour
No 2 Talbot Road

Section Showing Privacy Screens Scale 1:100 @ A3


- AMENDMENTS:**
- 1. - STORMWATER O.S.D. CONCEPT AMENDED;
 - 2. - SERVICE ROOMS IN S.W. CORNER ADDED;
 - 3. - SOUTH FIRE STAIR REMOVED;
 - 4. - STORAGE, LIFT + CIRCULATION AMENDED: BASEMENT NOW ONE LEVEL;
- GROUND:**
- 5. - BIN STORE AMENDED;
 - 6. - DELETE WINDOW, SQUARE OFF BUILDING CORNER;
- FIRST; SECOND; THIRD:**
- 7. - DELETE BEDROOM 1 WINDOW, MOVE BEDROOM 2 WINDOW, SQUARE OFF BUILDING CORNER;
- SECOND; THIRD:**
- 8. - CONSOLIDATE WINDOWS INTO ONE WINDOW;

Front Fence along Talbot St Scale 1:100 @ A3


Boundary



BASIX Commitments Water Commitments Fixtures <ul style="list-style-type: none">- Must install min 3 Star rating showerheads in all showers. (>4.5 but <=6l/min)- Must install min 5 Star rating toilet flushing system in each toilet- Must install min 5 Star rating taps in each bathroom		Other Must install gas cooktop and electric oven in the kitchen and a well ventilated fridge space in all units. Must install an indoor or sheltered clothes drying line in all units. Lighting Must provide dedicated artificial lighting for kitchens, bathrooms, laundry and hallways for all units and 1 bedroom for units: 18,19,20,27,28. 2 bedrooms for units: 2,3,5,6,7,8,10,11,13,14,15,16,17,21,22,23,24,25,26,29,30,31,33. 3 bedrooms for units: 1,4,9,12.		Water Commitments Fixtures <ul style="list-style-type: none">- Must install min 4 Star rating toilet flushing system in each toilet.- Must install min 5 Star rating taps	
Energy Commitments Hotwater Must install gas instantaneous 5 star system for each unit Cooling/Heating System Must install 1-phase airconditioning 3 star (new rating) zoned in the living and bedroom areas of each unit. Ventilation Must install exhaust systems in: Bathrooms, for all units: individual fan, ducted to facade or roof; Operation control: Manual switch on/off. Kitchens, for units 1,4,5,8,9,12,13,16,22,26,30,33: individual fan, not ducted; Operation Control: Manual switch on/off. For units 2,3,6,7,10,11,14,15,17,18,19,20,21,23,24,26,27,28,29,31,32: Individual fan, ducted to facade or roof; Operation control: Manual switch on/off. Laundry, for all units: Individual fan ducted to facade or roof; Operation control: Manual switch on/off.		Common Areas Energy Commitments Ventilation Must install exhaust system in; All carpark areas; Supplu + Exhaust; Efficiency measure; carbon monoxide monitor + VSD fan. Garbase Room: Ventilation Exhaust only. Lighting -Must install Lighting in; all carpark areas; Efficiency measure: Daylight sensor. -Must install lighting in; All lobbies; Fluorescent; Efficiency measure; Manual on/timer off. Must install lighting in: Lift car: Fluorescent; Efficiency measure; Connected to lift call button.		Note: Wall Construction All External Walls Hebel Construction All Internal Walls Plasterboard on studs Floor Construction Floor Slabs in concrete Roof Construction Metal Clad	

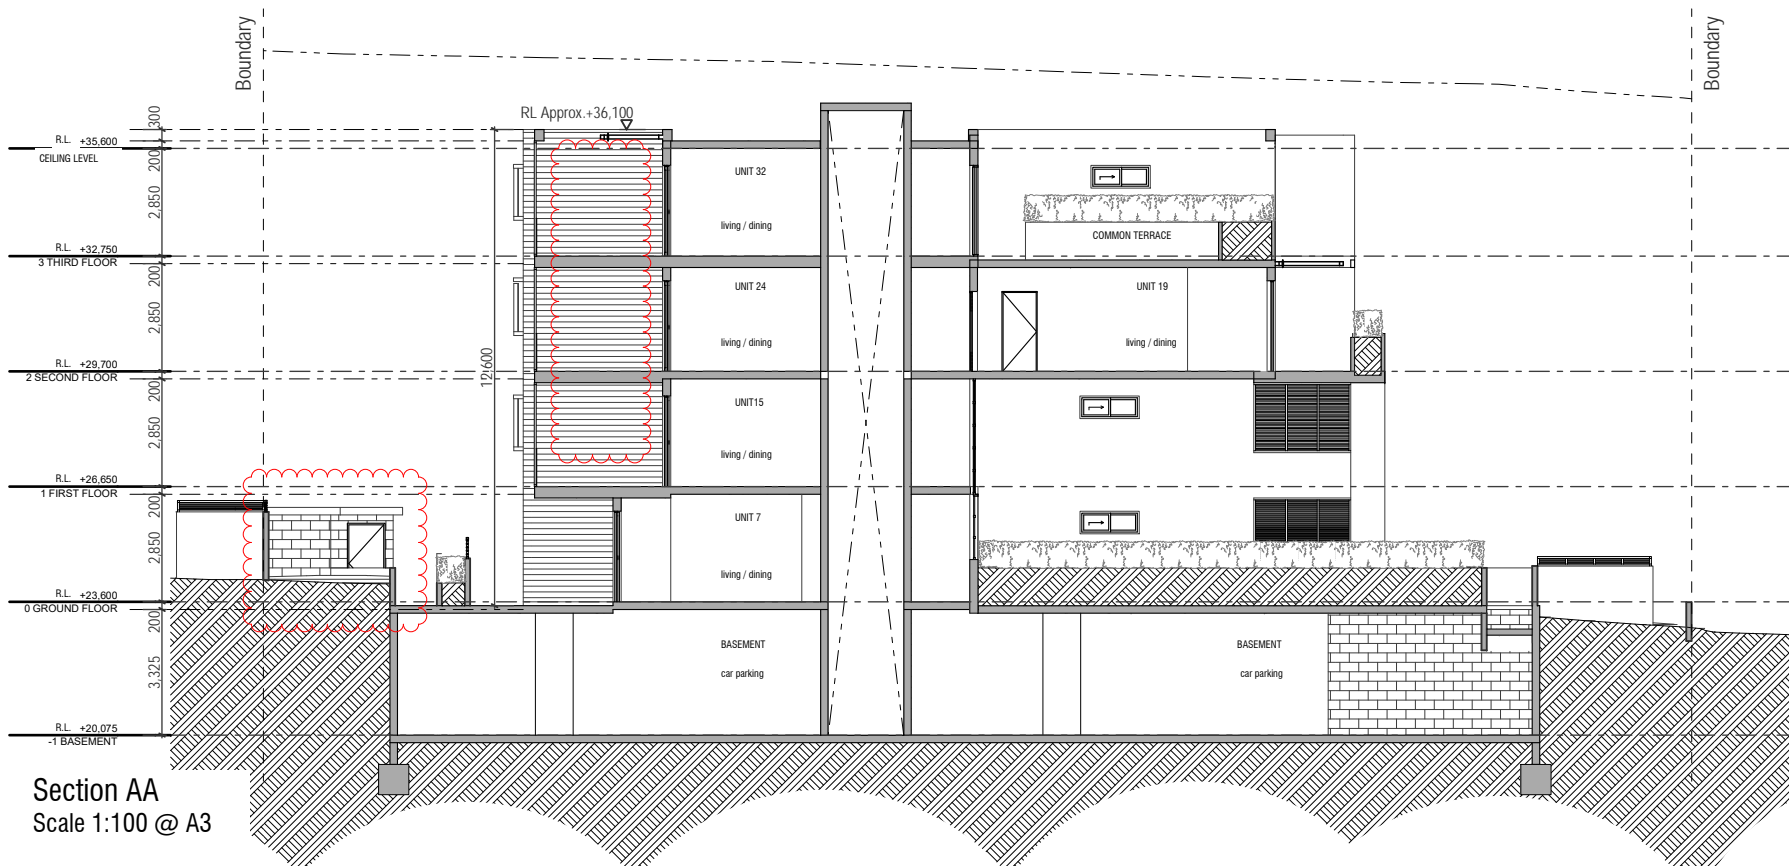


Section AA
Scale 1:100 @ A3

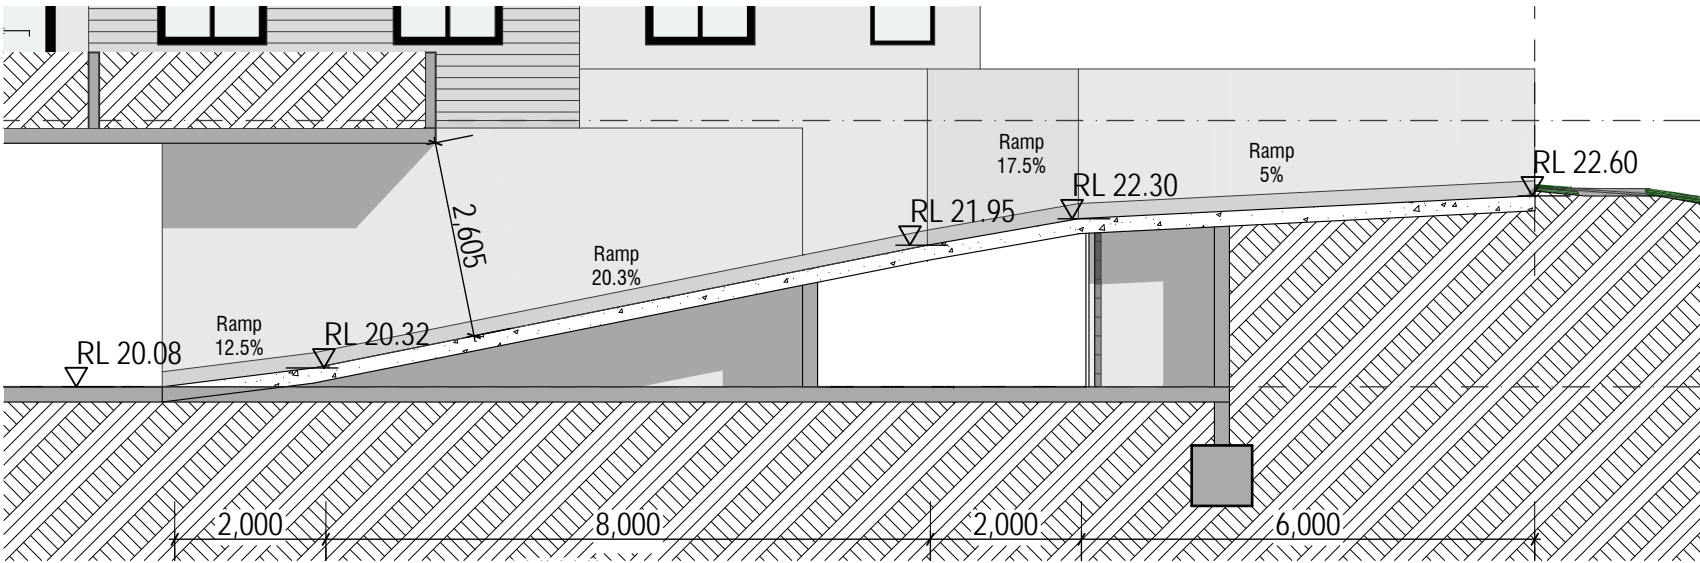


Driveway Section
Scale 1:100 @ A3

Section Across Footpath
of Talbot Road
Scale 1:100 @ A3

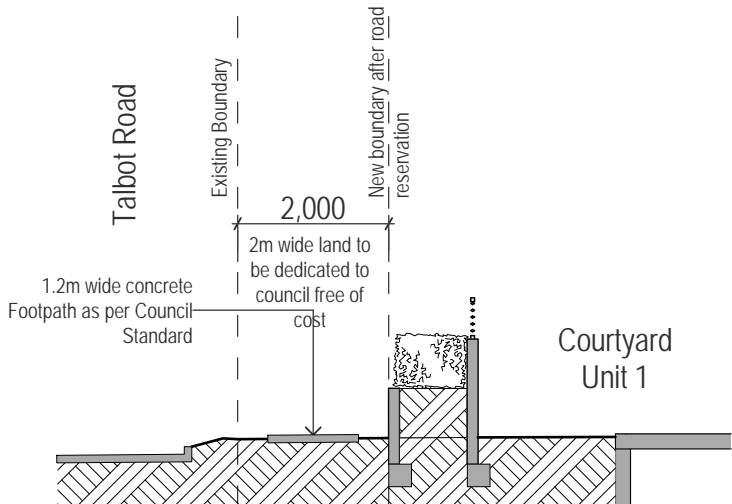


Profile Section
Scale 1:50 @ A3

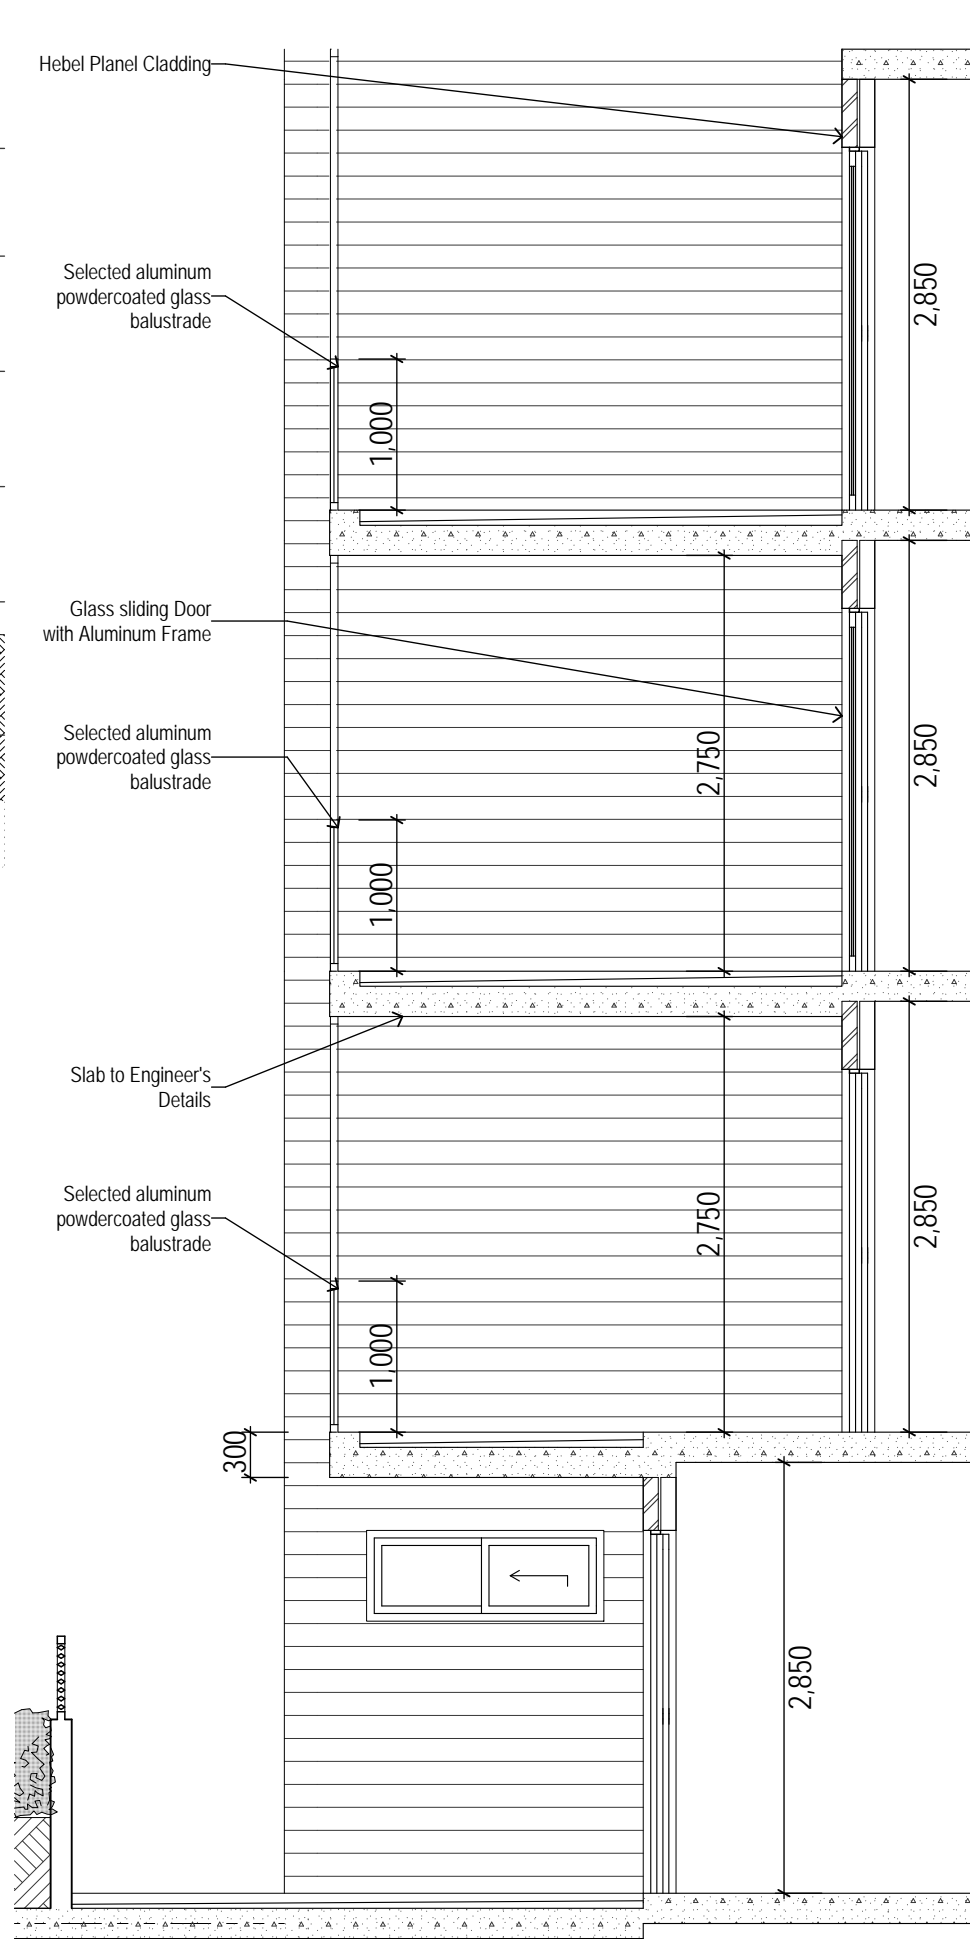

BASIX Commitments
Water Commitments
Fixtures
- Must install min 3 Star rating showerheads in all showers. (> 4.5 but <= 6/min)
- Must install min 5 Star rating toilet flushing system in each toilet
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Energy Commitments
Hotwater
Must install gas instantaneous 5 star system for each unit
Cooling/Heating System
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Must install exhaust systems in:
Bathrooms, for all units: individual fan, ducted to facade or roof; Operation control: Manual switch on/off.
Kitchens, for units 1,4,5,8,9,12,13,16,22,26,30,33: individual fan, not ducted; Operation Control: Manual switch on/off. For units 2,3,6,7,10,11,14,15,17,18,19,20,21,23,24,26,27,28,29,31,32: Individual fan, ducted to facade or roof; Operation control: Manual switch on/off. Laundry, for all units: Individual fan ducted to facade or roof; Operation control: Manual switch on/off.
Other
Must install gas cooktop and electric oven in the kitchen and a well ventilated fridge space in all units. Must install an indoor or sheltered clothes drying line in all units.
Lighting
Must provide dedicated artificial lighting for kitchens, bathrooms, laundry and hallways for all units and 1 bedroom for units: 18,19,20,27,28. 2 bedrooms for units: 2,3,5,6,7,8,10,11,13,14,15,16,17,21,22,23,24,25,26,29,30,31,33. 3 bedrooms for units: 1,4,9,12.
Common Areas
Energy Commitments
Ventilation
Must install exhaust system in: All carpark areas; Supply + Exhaust; Efficiency measure: carbon monoxide monitor + VSD fan. Garbage Room: Ventilation Exhaust only.
Lighting
-Must install Lighting in: all carpark areas; Efficiency measure: Daylight sensor.
-Must install lighting in: All lobbies; Fluorescent; Efficiency measure; Manual on/timer off. Must install lighting in: Lift car: Fluorescent; Efficiency measure; Connected to lift call button.
Water Commitments
Fixtures
- Must install min 4 Star rating toilet flushing system in each toilet.
- Must install min 5 Star rating taps

Note:
Wall Construction
All External Walls Hebel Construction
All Internal Walls Plasterboard on studs
Floor Construction
Floor Slabs in concrete
Roof Construction
Metal Clad

ENSURE TRUNK POSITION IS WITHIN 10% OF POT CENTRE. IF TREE IS GRAFTED ENSURE SCION AND ROOTSTOCK ARE SOUND.

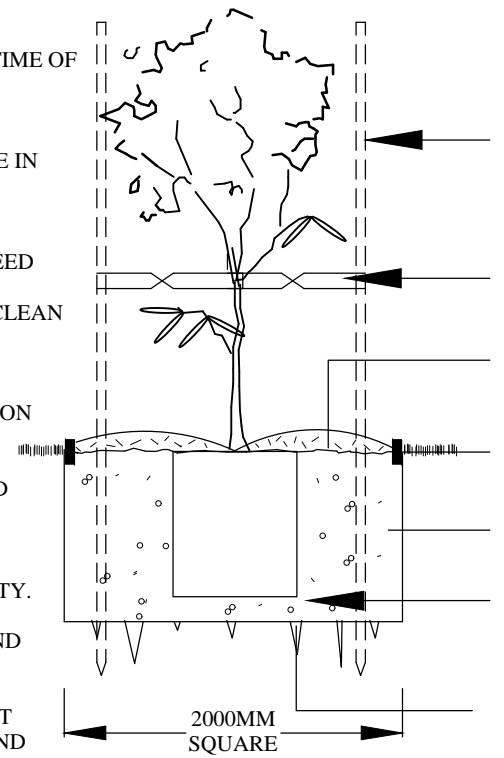

45-75LTR TYPICAL PLANTING
(NTS)

SELECTED EDGING - REFER TO DETAIL

EXCAVATE HOLE AND INCORPORATE SOIL AMENDMENTS TO 30% MAX. IF REQUIRED.

TAMP SOIL GENTLY AROUND AND BENEATH ROOT BALL
SO ROOT BALL DOES NOT MOVE - WATER WEEKLY FOR
MINIMUM 4 WEEKS TO ESTABLISH.


SCARIFY SUB SOIL AND SIDES TO 100MM MINIMUM IN HEAVY CLAY SOILS. MAY BE REQUIRED TO MOUND PLANT.

STREET TREES AND TURF TO BE PROTECTED DURING CONSTRUCTION (NOT SHOWN ON CONTOUR PLANS PROVIDED). ANY DAMAGE TO TURF AND STREET TREE TO BE RECTIFIED AS PART OF THE LANDSCAPE WORKS. THE METHODS OF TREE PROTECTION SHALL COMPLY WITH AUSTRALIAN STANDARD 4970-2009 – 'PROTECTION OF TREES ON DEVELOPMENT SITES'.


REFER TO HYDRAULICS ENGINEERS PLAN FOR OSD / DWARF WALL
DETAILS - MULCH OSD WITH NON FLOATABLE DECORATIVE GRAVEL.
ALL FINISHED GROUND LEVELS AS PER HYDRAULICS ENGINEERS DETAILS.

GENERAL NOTES:-

LANDSCAPE CONTRACTOR TO CHECK DA CONDITIONS AND STAMPED LANDSCAPE PLAN BEFORE COMMENCING WORKS TO ENSURE NO ADDITIONS/ AMENDMENTS TO PLAN. GARDEN BEDS TO BE CONSTRUCTED TO EXISTING PAVING/ DECKING/ GRAVEL. REFER TO HYDRAULICS ENGINEER'S PLAN FOR OSD DESIGN OF 75MM BED LEVELS. MULCHED PLANTING BEDS TO BE A MINIMUM DEPTH OF 75MM AS SELECTED. CONTRACTORS RESPONSIBILITY TO CHECK AND ADJUST SOIL pH AS REQUIRED. PROVIDE A MINIMUM 1.2M HEALTHY FENCING. GATES TO OPENING TURTLE AND GARDEN BEDS/ PATHWAYS. EDGING TO BE PROVIDED TO ALL AREAS WHERE DIFFERING MATERIALS MEET, IE: TURF/ GARDEN, TURF/ GRAVEL, PATH/ ETC. PROVIDE MULCH UNDER GRAVEL BEDS. MULCH TO BE SECURED TO LIMIT MUD TRACKING. PREMIUM ORGANIC GARDEN MIX, TURF, USED. ALL PLANTS TO BE HEALTHY AND VIGOROUS. CONTRACTOR TO MAKE GOOD ANY DAMAGE TO EXISTING STRIP POST CONSTRUCTION. DO NOT SCALE ARCHITECTURAL SETOUT FROM LANDSCAPE DRAWING. EXISTING TREE SPREAD APPROXIMATE ONLY. REFER TO TREE REPORT WHEN APPLICABLE. CONTRACTOR TO BE ADVISED BY TREE REPORT OF ANY TREE PROTECTION. BUFFALO TURF PREFERRED OVER KIKUYU.

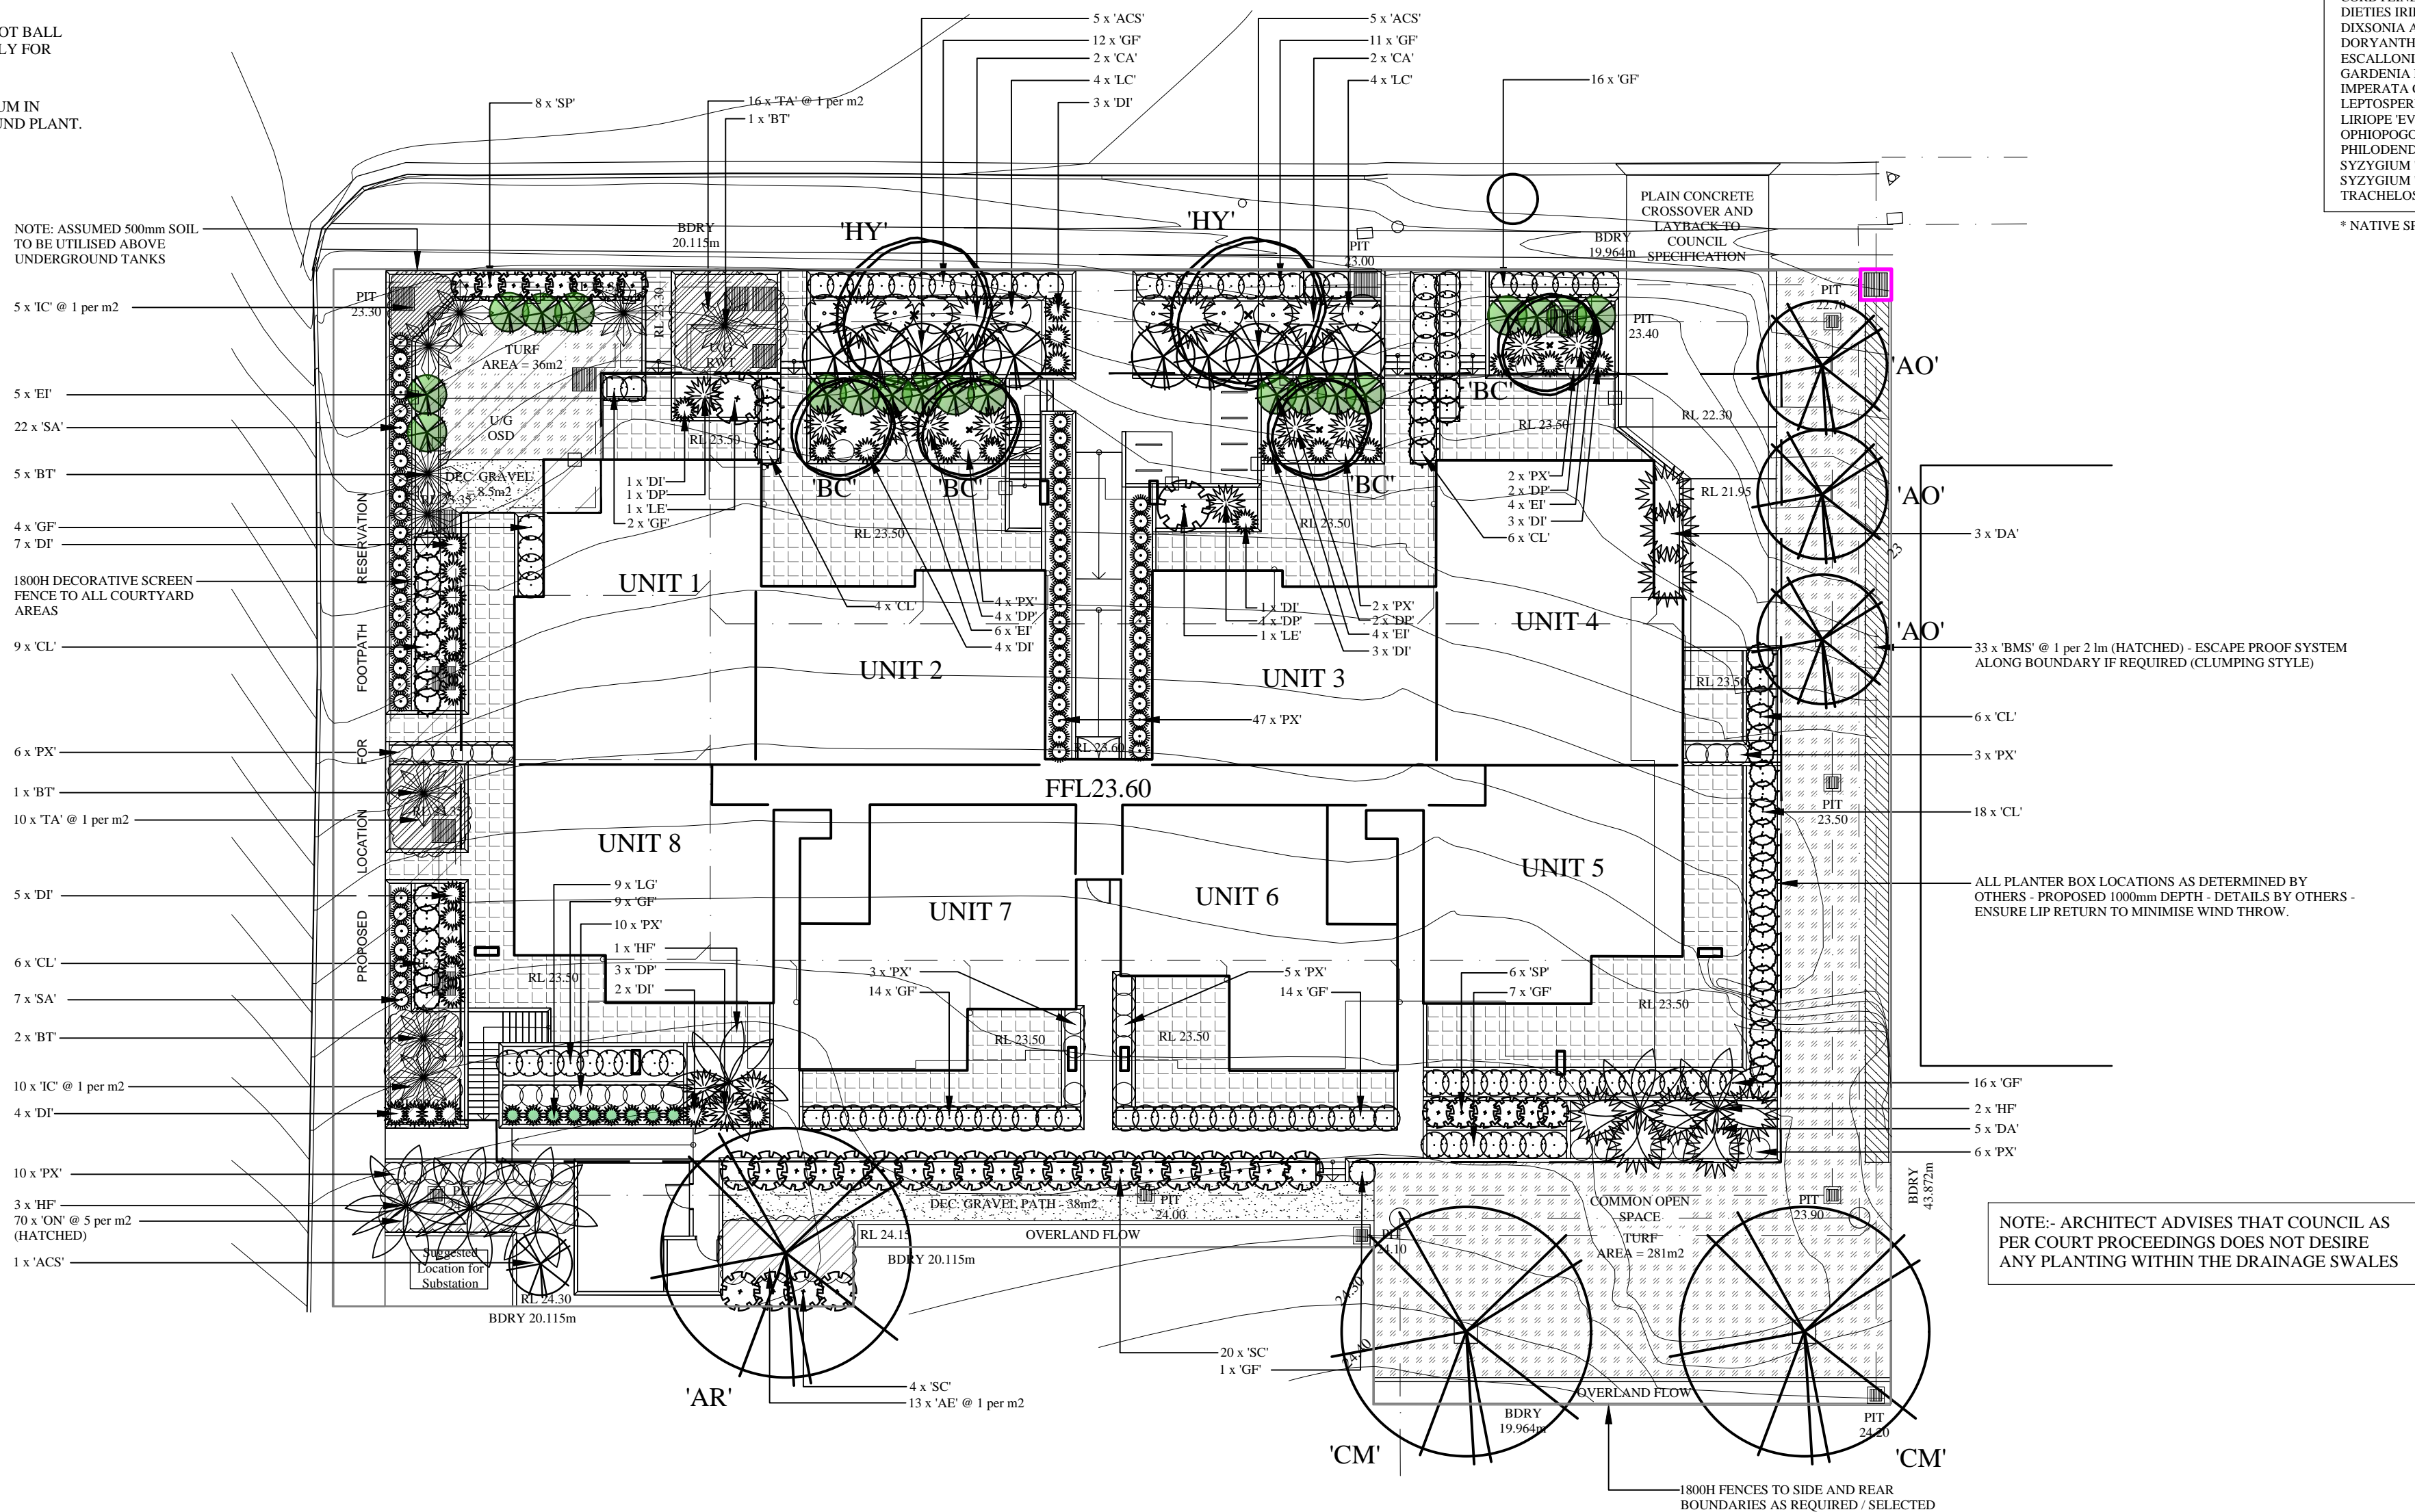


NOTE:- ARCHITECT ADVISES THAT COUNCIL AS PER COURT PROCEEDINGS DOES NOT DESIRE ANY PLANTING WITHIN THE DRAINAGE SWALES

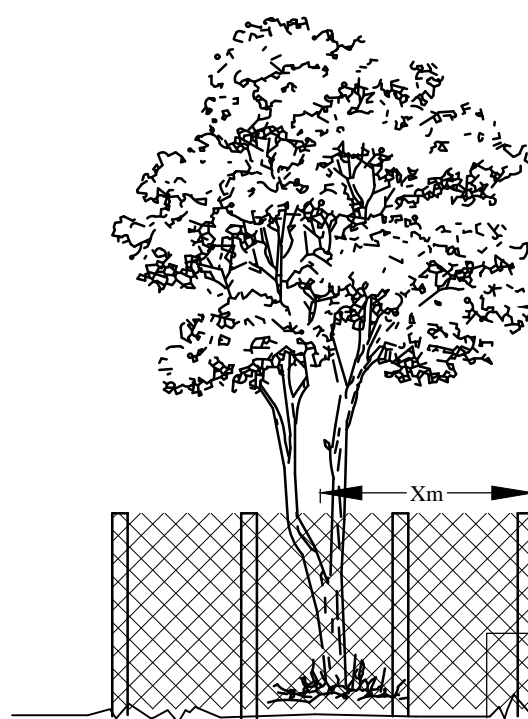

TYPICAL TREE PROTECTION
DETAIL - (NTS)
(IF NO ARBORIST REPORT REQUIRED)

REFER TO AS 4970-2009 -
'PROTECTION OF TREES ON
DEVELOPMENT SITES'

* IRRIGATION WITHIN TPZ AT ARBORIST OR COUNCIL DISCRETION

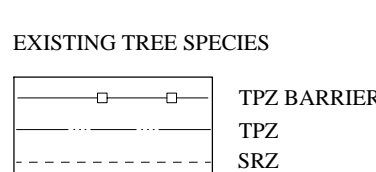

DISTANCE AS SHOWN ON PLAN

1800MM TEMPORARY FENCE HIGH
PLASTIC FEET - NO STAKES IN GROUND
UNLESS SPECIFIED

TPZ TO BE MULCHED WITH A MINIMUM
100MM RECYCLED LEAF LITTER MULCH

NOTE:- MONACO DESIGNS PL RESERVES THE RIGHT NOT TO UNDERTAKE NOR SUPPLY CERTIFICATION FOR OCCUPATION CERTIFICATE

NOTE:- TO AID COMPLIANCE WITH BASIX LEGISLATION, PLANTS (WHERE APPLICABLE) HAVE BEEN SELECTED FROM THE LOCAL CITY COUNCIL / SHIRE PLANT LISTS

NOTE:- LOCATION OF SEWER MAINS / LINES, WATER PIPES, UNDERGROUND ELECTRICITY AND OTHER SERVICES MUST BE OBTAINED PRIOR TO COMMENCEMENT OF ANY WORK ON SITE. DIAL BEFORE YOU DIG 1100

CONTRACTORS NOTE:- CALCULATED AREAS DETERMINED BY CAD AND HAVE BEEN ROUNDED UP FOR USE AS A GUIDE ONLY. ALLOW STANDARD PERCENTAGES FOR CUTTING AND WASTAGE. CONFIRM DIMENSIONS AND NUMBERS PRIOR TO QUOTING / ORDERING. COPYRIGHT:- THIS PLAN AND DESIGN IS THE PROPERTY OF MONACO DESIGNS PL. IT IS NOT TO BE COPIED OR REPRODUCED WITHOUT THE WRITTEN PERMISSION OF THE COMPANY. REPRODUCTION PARTLY OR IN FULL, CONSTITUTE AN INFRINGEMENT OF COPYRIGHT. FULL TERMS AND CONDITIONS CAN BE OBTAINED FROM MONACO DESIGNS WEBSITE. OR UPON REQUEST. THIS PLAN MAY ONLY BE UTILISED FOR ITS INTENDED PURPOSE ONCE PAYMENT HAS BEEN RECEIVED IN FULL, OR AS PER OUR LETTER OF AGREEMENT.



PLANT SCHEDULE

BOTANIC NAME	KEY	QTY	POT SIZE	HT (M)
TREES				
ACER OCTOBER GLORY (MAPLE)	AO	3	75L	10-15+
ACACIA ROBUSTA (RAUPU)	AR	4	45L	15+
BACHOFFUSA CATTODRODA (LEMON MYRTLE)*	BC	4	300MM	5-10
CORYMBIA MACULATA (SPOTTED GUM)*	CM	2	45L	15+
HOWEA FOSTERIANA (SENTINEL PALM)*	HF	6	30L	10-15
HYMENOSPORUM FLAVUUM (NATIVE FRANGIPANI)*	HY	2	45L	5-10
SHRUBS				
ACHENA CHERUB SURPRISE (LILLY PILLY)*	ACS	11	200MM	3-5
SVYZJGUM AUSSIE BOOMER (LILLY PILLY)*	SA	29	200MM	1-5
ASPIDISTRA ELATOR (CAST IRON PLANT)	AE	13	140MM	1
BAMBUSA MULTIPLEX STRIPESMEX	BMS	33	200MM	3-8
BAMBUSA TEXTILIS GREENTILES (CLUMPING BAMBOO)	BT	9	300MM	5
CAMELLIA LITTLE LIANE	CL	49	200MM	1-2
CTRUS LEMON	LE	2	25L	3
CORYDINE AUSTRALS (CABBAGE TREE)*	CA	4	200MM	2
DIETIES IRIDIODES (WILD IRIS)	DI	33	140MM	1
DIXSONIA ANTARTICA (TREE FERN)*	DA	8	200MM	3
DORYANTHES PALMERBII CYMELA LILLY)*	DP	13	200MM	1-5
ESCALLONIA TWEY (ESCALLONIA)	EI	19	200MM	2
GARDENIA FLORIDA	GF	106	200MM	1
IMPERATA CYLINDRICA (BLADY GRASS)*	IC	15	140MM	1
LEPTOSPERMUM CARDWELL (TEA TREE)*	LC	8	200MM	3
LIRIOPE EVERGREEN GIAN (LIRIOPE)	LG	9	100MM	0.6
ORIPHOLOG NIGRA (BLACK MONK)	ON	70	100MM	0.2
PHILODENDRON 'NANADI'	PN	51	200MM	1
SVYZJGUM CASCADE (LILLY PILLY)*	SC	24	200MM	1
SVYZJGUM 'PINKSALE' (LILLY PILLY)*	SP	14	200MM	1
TRACHELOSPERMUM ASIATICUM	TA	26	140MM	TRIM GC

* NATIVE SPECIES

07 AUG 18 - REDRAW PLAN
31 JAN 17 - ADD TURF SWALE
30 JAN 17 - REDRAW BIN ROOM AND TURF SWALE
27 SEP 16 - REDRAW ARCHITECTURALS AND STORMWATER
09 MAR 16 - MOVE 'AR' BEHIND FENCE
24 FEB 16 - REDRAW PLANS

CB
MONACO
DESIGNS PL

14 York Street, Glenbrook NSW, 2773
ph & fax: 0247395136 mb: 0409123200
email: paul@monaco.net.au

PROJECT:
PROPOSED DEVELOPMENT

ADDRESS:
78-84 BURSILL STREET,
GUILDFORD

CLIENT:
DESIGN CUBICLE - JOE REFFALO

TITLE: DA
LANDSCAPE PLAN

DATE:	SCALE:	SHEET No:
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27 FEB 2015	1 : 200 - A1
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JOB No.	DRAWN
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4007	P MONACO
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TREE REPORTS
LANDSCAPE PLANS
VEGETATION MANAGEMENT PLANS

78 - 84 BURSILL STREET, GUILDFORD

PROPOSED RESIDENTIAL UNITS DEVELOPMENT

STORMWATER MANAGEMENT PLANS

LEGEND

	PROPOSED STORMWATER
	PROPOSED STORMWATER BYPASSING OSD
	PROPOSED STORMWATER DRAINING TO RWT
	PROPOSED STORMWATER DRAINING TO OSD
	PIPE OVERCROSSING MINIMUM 150mm CLEARANCE
	PROPOSED PIPE MOUNTED TO GROUND FLOOR UNDER SLAB
	SUBSOIL DRAINAGE
	EXISTING STORMWATER
	EXISTING SEWER MAIN (FROM RECORDS)
	EXISTING OPTIC FIBER MAIN (FROM RECORDS)
	EXISTING WATER (FROM RECORDS)
	EXISTING POWER (FROM RECORDS)
	EXISTING GAS (FROM RECORDS)
	EXISTING TELSTRA (FROM RECORDS)
	GUTTER DOWNPIPE
	DOWNPIPE WITH VERTICAL BEND
	DOWNPIPE NUMBER AND SIZE
	ROOF GUTTER HIGH POINT
	ROOF SLOPE
	PLANTER GRATE
	FLOOR GRATE
	RAINWATER OUTLET
	BREAK / OPEN VOID IN RAIL / BALLUSTRADE FOR STORMWATER EMERGENCY OVERFLOW
	Ø300 CLEANING EYE
	x,xxxL RAINWATER TANK
	SURFACE FLOW ARROWS
	DESIGN SURFACE LEVEL
	EXISTING SURFACE LEVEL
	INVERT LEVEL OF PIPE JUNCTION
	FENCE WITH 50mm GAP BENEATH FOR OVERLAND FLOWS
	CLOSED STYLE FENCING
	POOL TYPE SAFETY FENCE



LOCALITY PLAN

N.T.S

DRAWING INDEX

Drawing No.	DESCRIPTION
000	COVER SHEET, NOTES & LEGEND
101	STORMWATER LAYOUT PLAN BASEMENT LEVEL SHEET 1 OF 2
102	STORMWATER LAYOUT PLAN BASEMENT LEVEL SHEET 2 OF 2
103	STORMWATER LAYOUT PLAN GROUND LEVEL SHEET 1 OF 2
104	STORMWATER LAYOUT PLAN GROUND LEVEL SHEET 2 OF 2
105	COMBINED OSD/RWT TANK DETAILS SHEET 1 OF 2
106	COMBINED OSD/RWT TANK DETAILS SHEET 2 OF 2
107	SEDIMENT & EROSION CONTROL PLAN
108	MISCELLANEOUS DETAILS SHEET

PIPES NOTE:

Ø65 PVC @ MIN 1.0%
Ø90 PVC @ MIN 1.0%
Ø100 PVC @ MIN 1.0%
Ø150 PVC @ MIN 1.0%
Ø225 PVC @ MIN 0.5%
Ø300 PVC @ MIN 0.4%
UNLESS NOTED OTHERWISE

GENERAL NOTES

- ALL THE CLEANING EYES (OR INSPECTION EYES) FOR THE UNDERGROUND PIPES HAVE TO BE TAKEN UP TO THE FINISHED GROUND LEVEL FOR EASY IDENTIFICATION AND MAINTENANCE PURPOSES
- ALL LEVELS SHALL RELATE TO THE ESTABLISHED BENCH MARK.
- THE BUILDER SHALL ENSURE THAT THE STORMWATER ENGINEERS DRAWINGS CORRESPOND TO THE ARCHITECTURAL, STRUCTURAL AND LANDSCAPING DRAWINGS. IF THERE EXISTS AND DISCREPANCIES BETWEEN THE DRAWINGS, THE BUILDER SHALL REPORT THE DISCREPANCIES TO THE ENGINEER PRIOR TO COMMENCEMENT OF ANY WORKS
- ALL MULCHING TO BE USED WITHIN THE AREA DESIGNATED AS ONS-SITE DETENTION STORAGE SHALL BE OF A NON-FLOATABLE MATERIAL SUCH AS DECORATIVE RIVER GRAVEL. PINE BARK MULCHING SHALL NOT BE USED WITHIN THE DETENTION STORAGE AREA.
- ALL RETAINING WALLS SHALL BE CONSTRUCTED COMPLETELY WITHIN THE PROPERTY BOUNDARY LIMITS TO DETAILS PREPARED BY THE STRUCTURAL ENGINEER. WALLS FORMING THE ON-SITE DETENTION SYSTEM SHALL BE OF MASONARY/BRICK CONSTRUCTION AND WATER TIGHT.
- ALL SUB-SOIL DRAINAGE SHALL BE A MINIMUM OF 65MM DIA AND SHALL BE PROVIDED WITH A FILTER SOCK. THE SUBSOIL DRAINAGE SHALL BE INSTALLED IN ACCORDANCE WITH DETAILS TO BE PROVIDED BY THE LANDSCAPE ARCHITECT.
- PRIOR TO COMMENCING ANY WORKS, THE BUILDER SHALL ENSURE THAT THE INVERT LEVELS OF WHERE THE SITE STORMWATER SYSTEM CONNECTS INTO THE COUNCILS KERB/DRAINAGE SYSTEM MATCHED THE DESIGN LEVELS. ANY DISCREPANCIES SHALL BE REPORTED TO THE DESIGN ENGINEER IMMEDIATELY.
- ALL LINES ARE TO BE Ø90 uPVC 1.0% GRADE UNLESS NOTED OTHERWISE. CHARGED LINES TO BE SEWERGRADE & SEALED.
- EXISTING SERVICES LOCATIONS SHOWN INDICATIVE ONLY.
- IT IS THE CONTRACTORS RESPONSIBILITY TO LOCATE & LEVEL ALL EXISTING SERVICES PRIOR TO THE COMMENCEMENT OF ANY EARTHWORKS.
- ALL PIPES TO HAVE MIN 150mm COVER IF LOCATED WITHIN PROPERTY.
- ALL PITS IN DRIVEWAYS TO BE 450x450 CONCRETE AND ALL PITS IN LANDSCAPED AREAS TO BE 450x450PLASTIC.
- PITS LESS THAN 450 DEEP MAY BE BRICK, PRECAST OR CONCRETE.
- ALL BALCONIES AND ROOFS TO BE DRAINED AND TO HAVE SAFETY OVERFLOWS IN ACCORDANCE WITH RELEVANT AUSTRALIAN STANDARDS.
- ALL EXTERNAL SLABS TO BE WATERPROOFED.
- ALL GRATES TO HAVE CHILD PROOF LOCKS.
- ALL DRAINAGE WORKS TO AVOID TREE ROOTS.
- ALL DP'S TO HAVE LEAF GUARDS.
- ALL EXISTING LEVELS TO BE CONFIRMED BY BUILDER PRIOR TO CONSTRUCTION.
- ALL WORK WITHIN COUNCIL RESERVE TO BE INSPECTED BY COUNCIL PRIOR TO CONSTRUCTION.
- COUNCIL'S ISSUED FOOTWAY DESIGN LEVELS TO BE INCORPORATED INTO THE FINISHED LEVELS ONCE ISSUED BY COUNCIL.
- ALL WORK SHALL BE IN ACCORDANCE WITH B.C.A. AND A.S.3500.3.
- REFER TO LANDSCAPE ARCHITECT'S DRAWINGS FOR LANDSCAPING.
- ALL WALLS FORMING THE DETENTION BASINS SHALL BE CONSTRUCTED WHOLLY WITHIN THE PROPERTY BOUNDARIES OF THE SITE BEING DEVELOPED.
- OSD WARNING SIGN AND SAFETY FENCING SHALL BE PROVIDED TO ABOVE GROUND OSD STORAGE AREA IN ACCORDANCE WITH COUNCIL'S REQUIREMENTS.
- ENSURE THAT NON FLOATABLE MULCH IS USED IN DETENTION BASINS, ie, USE DECORATIVE ROCK MULCH OR EQUIVALENT.
- ALL PIPES IN BALCONIES TO BE Ø65 uPVC IN CONCRETE SLAB. CONTRACTOR TO PROVIDE A BREAK / OPEN VOID IN RAIL / BALLUSTRADE FOR STORMWATER EMERGENCY OVERFLOW. ALL ENCLOSED AREAS / PLANTER BOXES TO BE FITTED WITH FLOOR WASTES & DRAINED TO OSD. DOWNPIPES TO BE CHECKED BY ARCHITECT & PLUMBER PRIOR TO CONSTRUCTION.
- THE OSD BASIN / TANK IS TO BE BUILT TO THE CORRECT LEVELS & SIZE AS PER THIS DESIGN. ANY VARIATIONS ARE TO BE DONE UNDER CONSULTATION FROM OUR OFFICE ONLY. ANY AMENDMENTS WITHOUT OUR APPROVAL WOULD RESULT IN ADDITIONAL FEES FOR REDESIGN AT OC STAGE OR IF A SOLUTION CANNOT BE FOUND, RECONSTRUCTION IS REQUIRED UNDER THE CONTRACTOR'S EXPENSES

C	ISSUE FOR S.455 MODIFICATION	09/12/2018	E.Y.	O.C.
B	ISSUE FOR SECTION 96 APPROVAL	27/08/2018	A.S.	J.B
A	ISSUE FOR CONSTRUCTION CERTIFICATE	28/05/2018	A.S.	J.B
Issue	Description	Date	Design	Engineer

Certification By:

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Council
Cumberland
Council

Scale




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Project
78 - 84 BURSILL STREET, GUILDFORD
PROPOSED RESIDENTIAL UNITS DEVELOPMENT
STORMWATER MANAGEMENT PLAN
CONSTRUCTION CERTIFICATE

Drawing Title
COVER SHEET PLAN

Scale	A1	Project No.	Dwg. No.	Issue
N.T.S.		171716	000	C

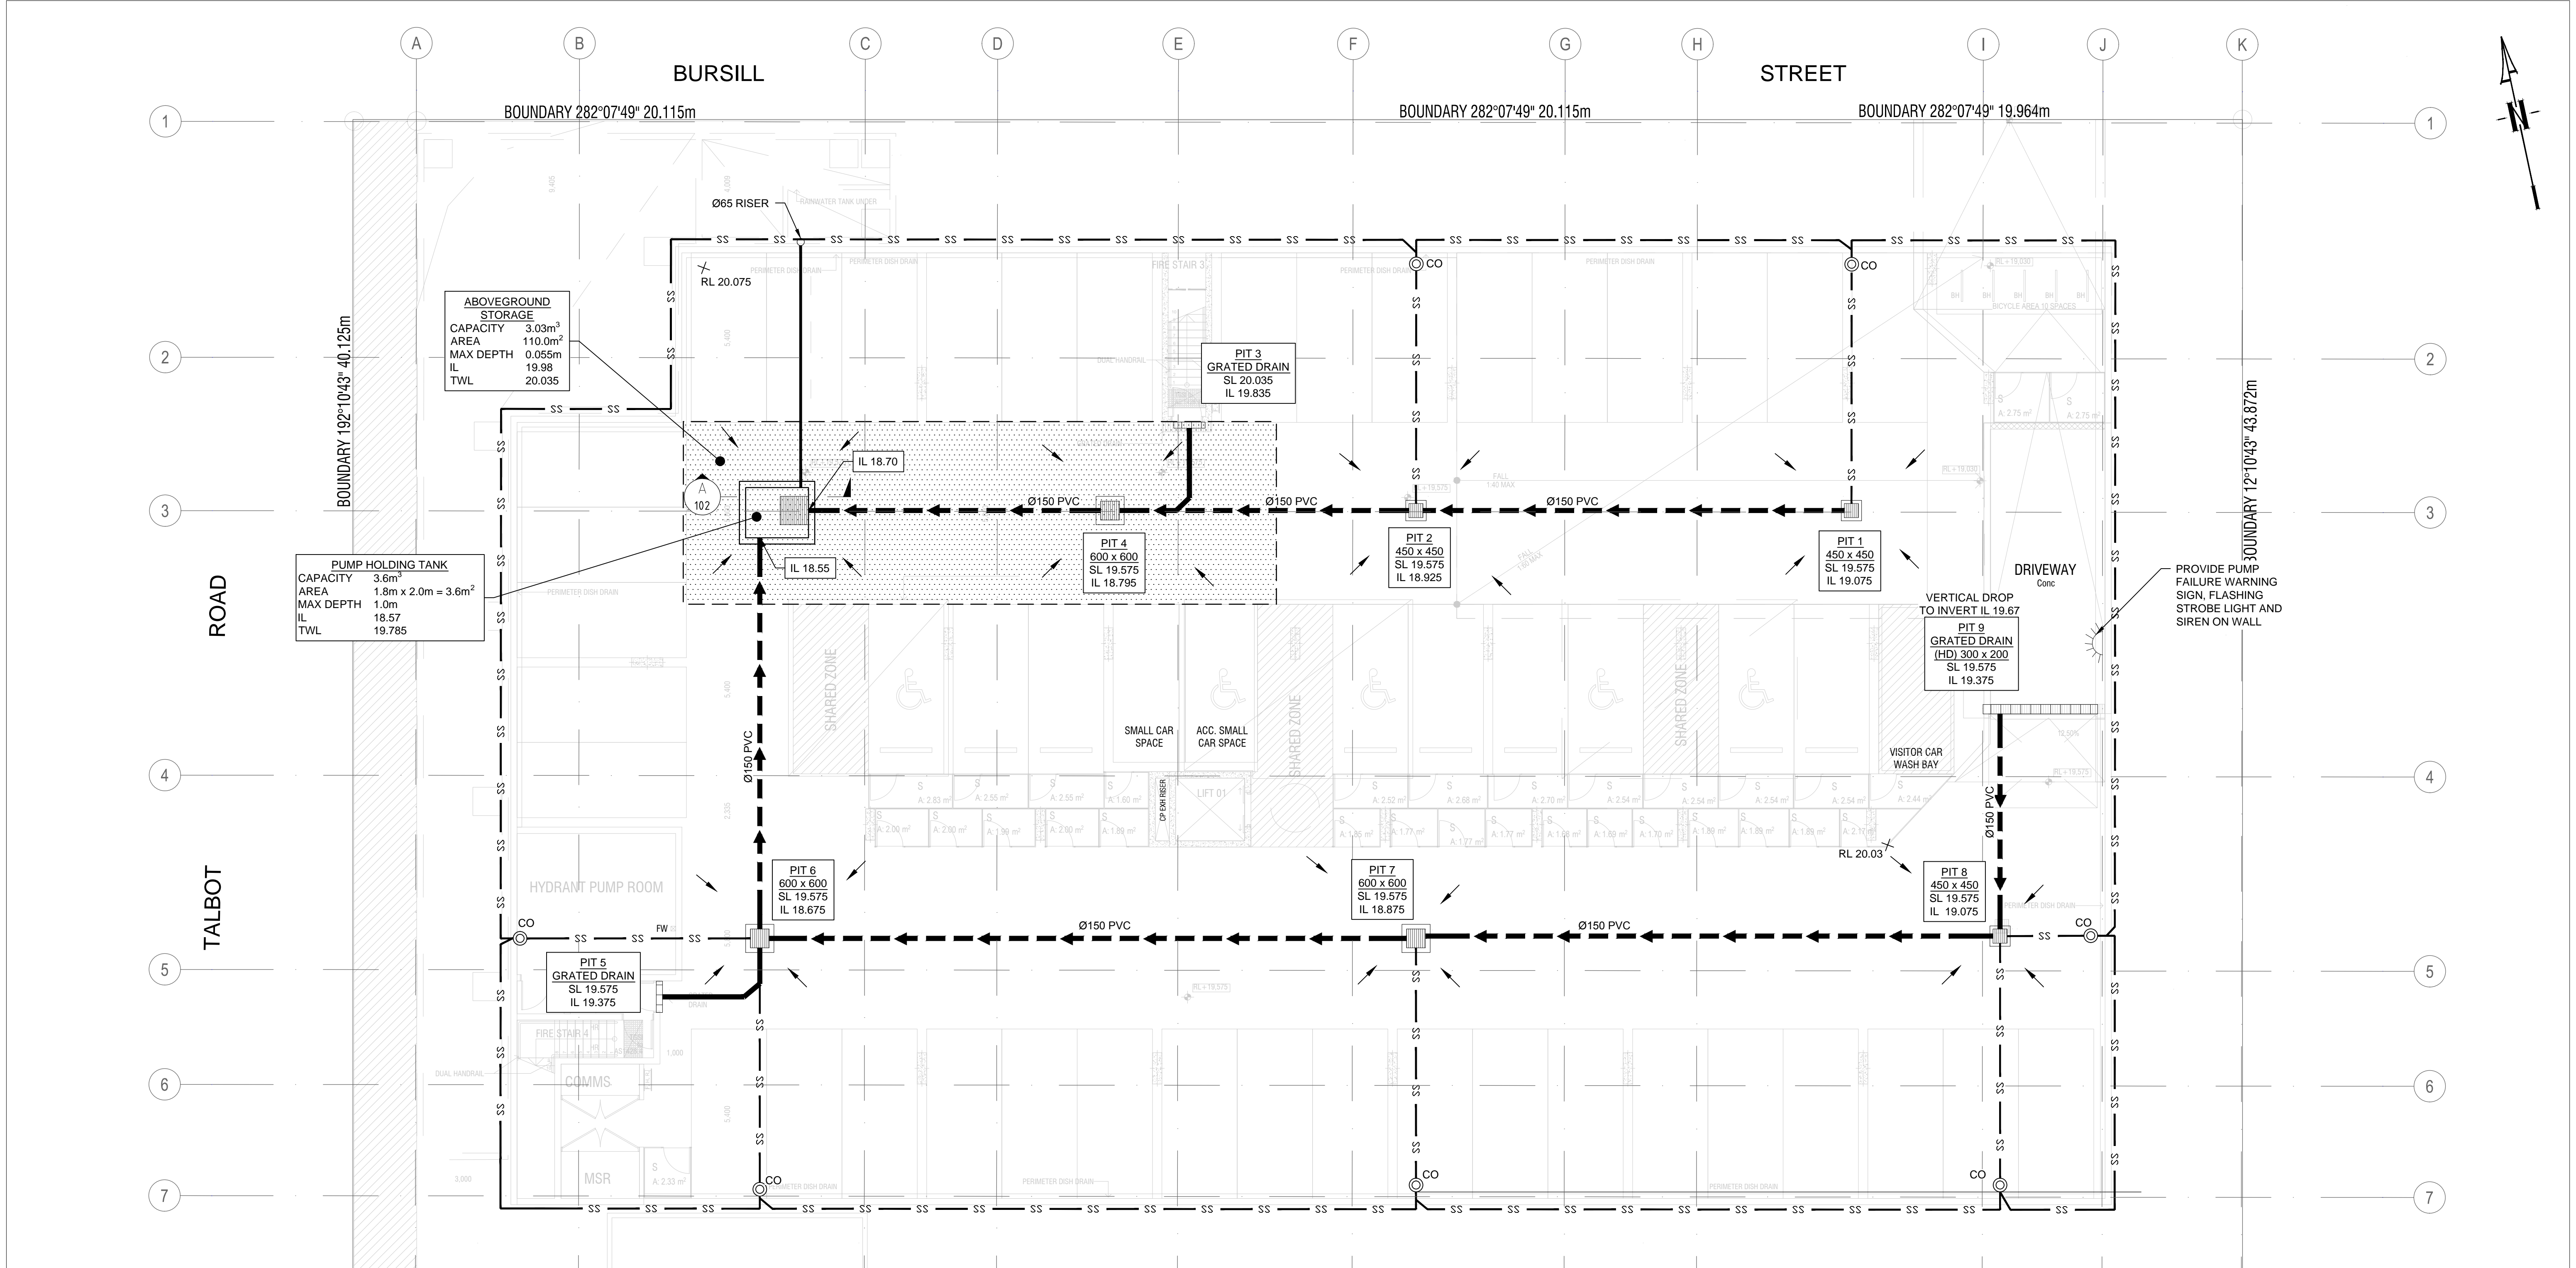

LEGEND

- PROPOSED STORMWATER
- SURFACE FLOW ARROWS
- SUBSOIL DRAINAGE
- CLEANING EYE (OR INSPECTION EYE)
- PROPOSED STORAGE AREA
- FINISHED SURFACE LEVEL
- GRATED DRAIN

STANDARD PUMP OUT DESIGN NOTES

- THE PUMP OUT SYSTEM SHALL BE DESIGN TO BE OPERATED IN THE FOLLOWING MANNER:
- THE PUMP SHALL BE PROGRAMMED TO WORK ALTERNATELY TO ALLOW BOTH PUMPS TO HAVE AN EQUAL OPERATION LOAD AND PUMP LIFE.
 - A FLOAT SHALL BE PROVIDED TO ENSURE OF THE MINIMUM REQUIRED WATER LEVEL IS MAINTAINED WITHIN THE SUMP AREA OF THE BELOW GROUND TANK. IN THIS REGARD THIS FLOAT WILL FUNCTION AS AN OFF SWITCH FOR THE PUMPS AT THE MINIMUM WATER LEVEL. THE SAME FLOAT SHALL BE SET TO TURN ONE OF THE PUMPS ON UPON THE WATER LEVEL IN THE TANK RISING TO APPROXIMATELY 300mm ABOVE THE MINIMUM WATER LEVEL. THE PUMP SHALL OPERATE UNTIL THE TANK IS DRAINED TO THE MINIMUM WATER LEVEL.
 - A SECOND FLOAT SHALL BE PROVIDE AT A HIGH LEVEL, WHICH IS APPROXIMATELY THE ROOF LEVEL OF THE BELOW GROUND TANK. THIS FLOAT SHALL START THE OTHER PUMP THAT IS NOT OPERATING AND ACTIVATE THE ALARM.
 - AN ALARM SYSTEM SHALL BE PROVIDE WITH A FLASHING STROBE LIGHT AND A PUMP FAILURE WARNING SIGN WHICH ARE TO BE LOCATED AT THE DRIVEWAY ENTRANCE TO THE BASEMENT LEVEL. THE ALARM SYSTEM SHALL BE PROVIDED WITH A BATTERY BACK-UP IN CASE OF POWER FAILURE.
 - A CONFINED SPACE DANGER SIGN SHALL BE PROVIDED AT ALL ACCESS POINT TO THE PUMP-OUT STORAGE TANK IN ACCORDANCE WITH THE UPPER PARRAMATA RIVER CATCHMENT TRUST OSD HANDBOOK.



CONFINED SPACE DANGER SIGN

- A) A CONFINED SPACE DANGER SIGN SHALL BE POSITIONED IN A LOCATION AT ALL ACCESS POINTS, SUCH THAT IT IS CLEARLY VISIBLE TO PERSONS PROPOSING TO ENTER THE BELOW GROUND TANK/S CONFINED SPACE.
- B) MINIMUM DIMENSIONS OF THE SIGN - 300mm x 450mm (LARGE ENTRIES, SUCH AS DOORS) - 250mm x 180mm (SMALL ENTRIES SUCH AS GRATES & MANHOLES)
- C) THE SIGN SHALL BE MANUFACTURED FROM COLOUR BONDED ALUMINUM OR POLYPROPYLENE
- D) SIGN SHALL BE AFFIXED USING SCREWS AT EACH CORNER OF THE SIGN
- COLOURS:
'DANGER' & BACKGROUND = WHITE
ELLIPTICAL AREA = RED
RECTANGLE CONTAINING ELLIPSE = BLACK
BORDER AND OTHER LETTERING = BLACK

Issue	Description	Date	Design	Engineer
C	ISSUE FOR S.455 MODIFICATION	09/12/2018	E.Y.	O.C.
B	ISSUE FOR SECTION 96 APPROVAL	27/08/2018	A.S.	J.B
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Certification By: [Signature]

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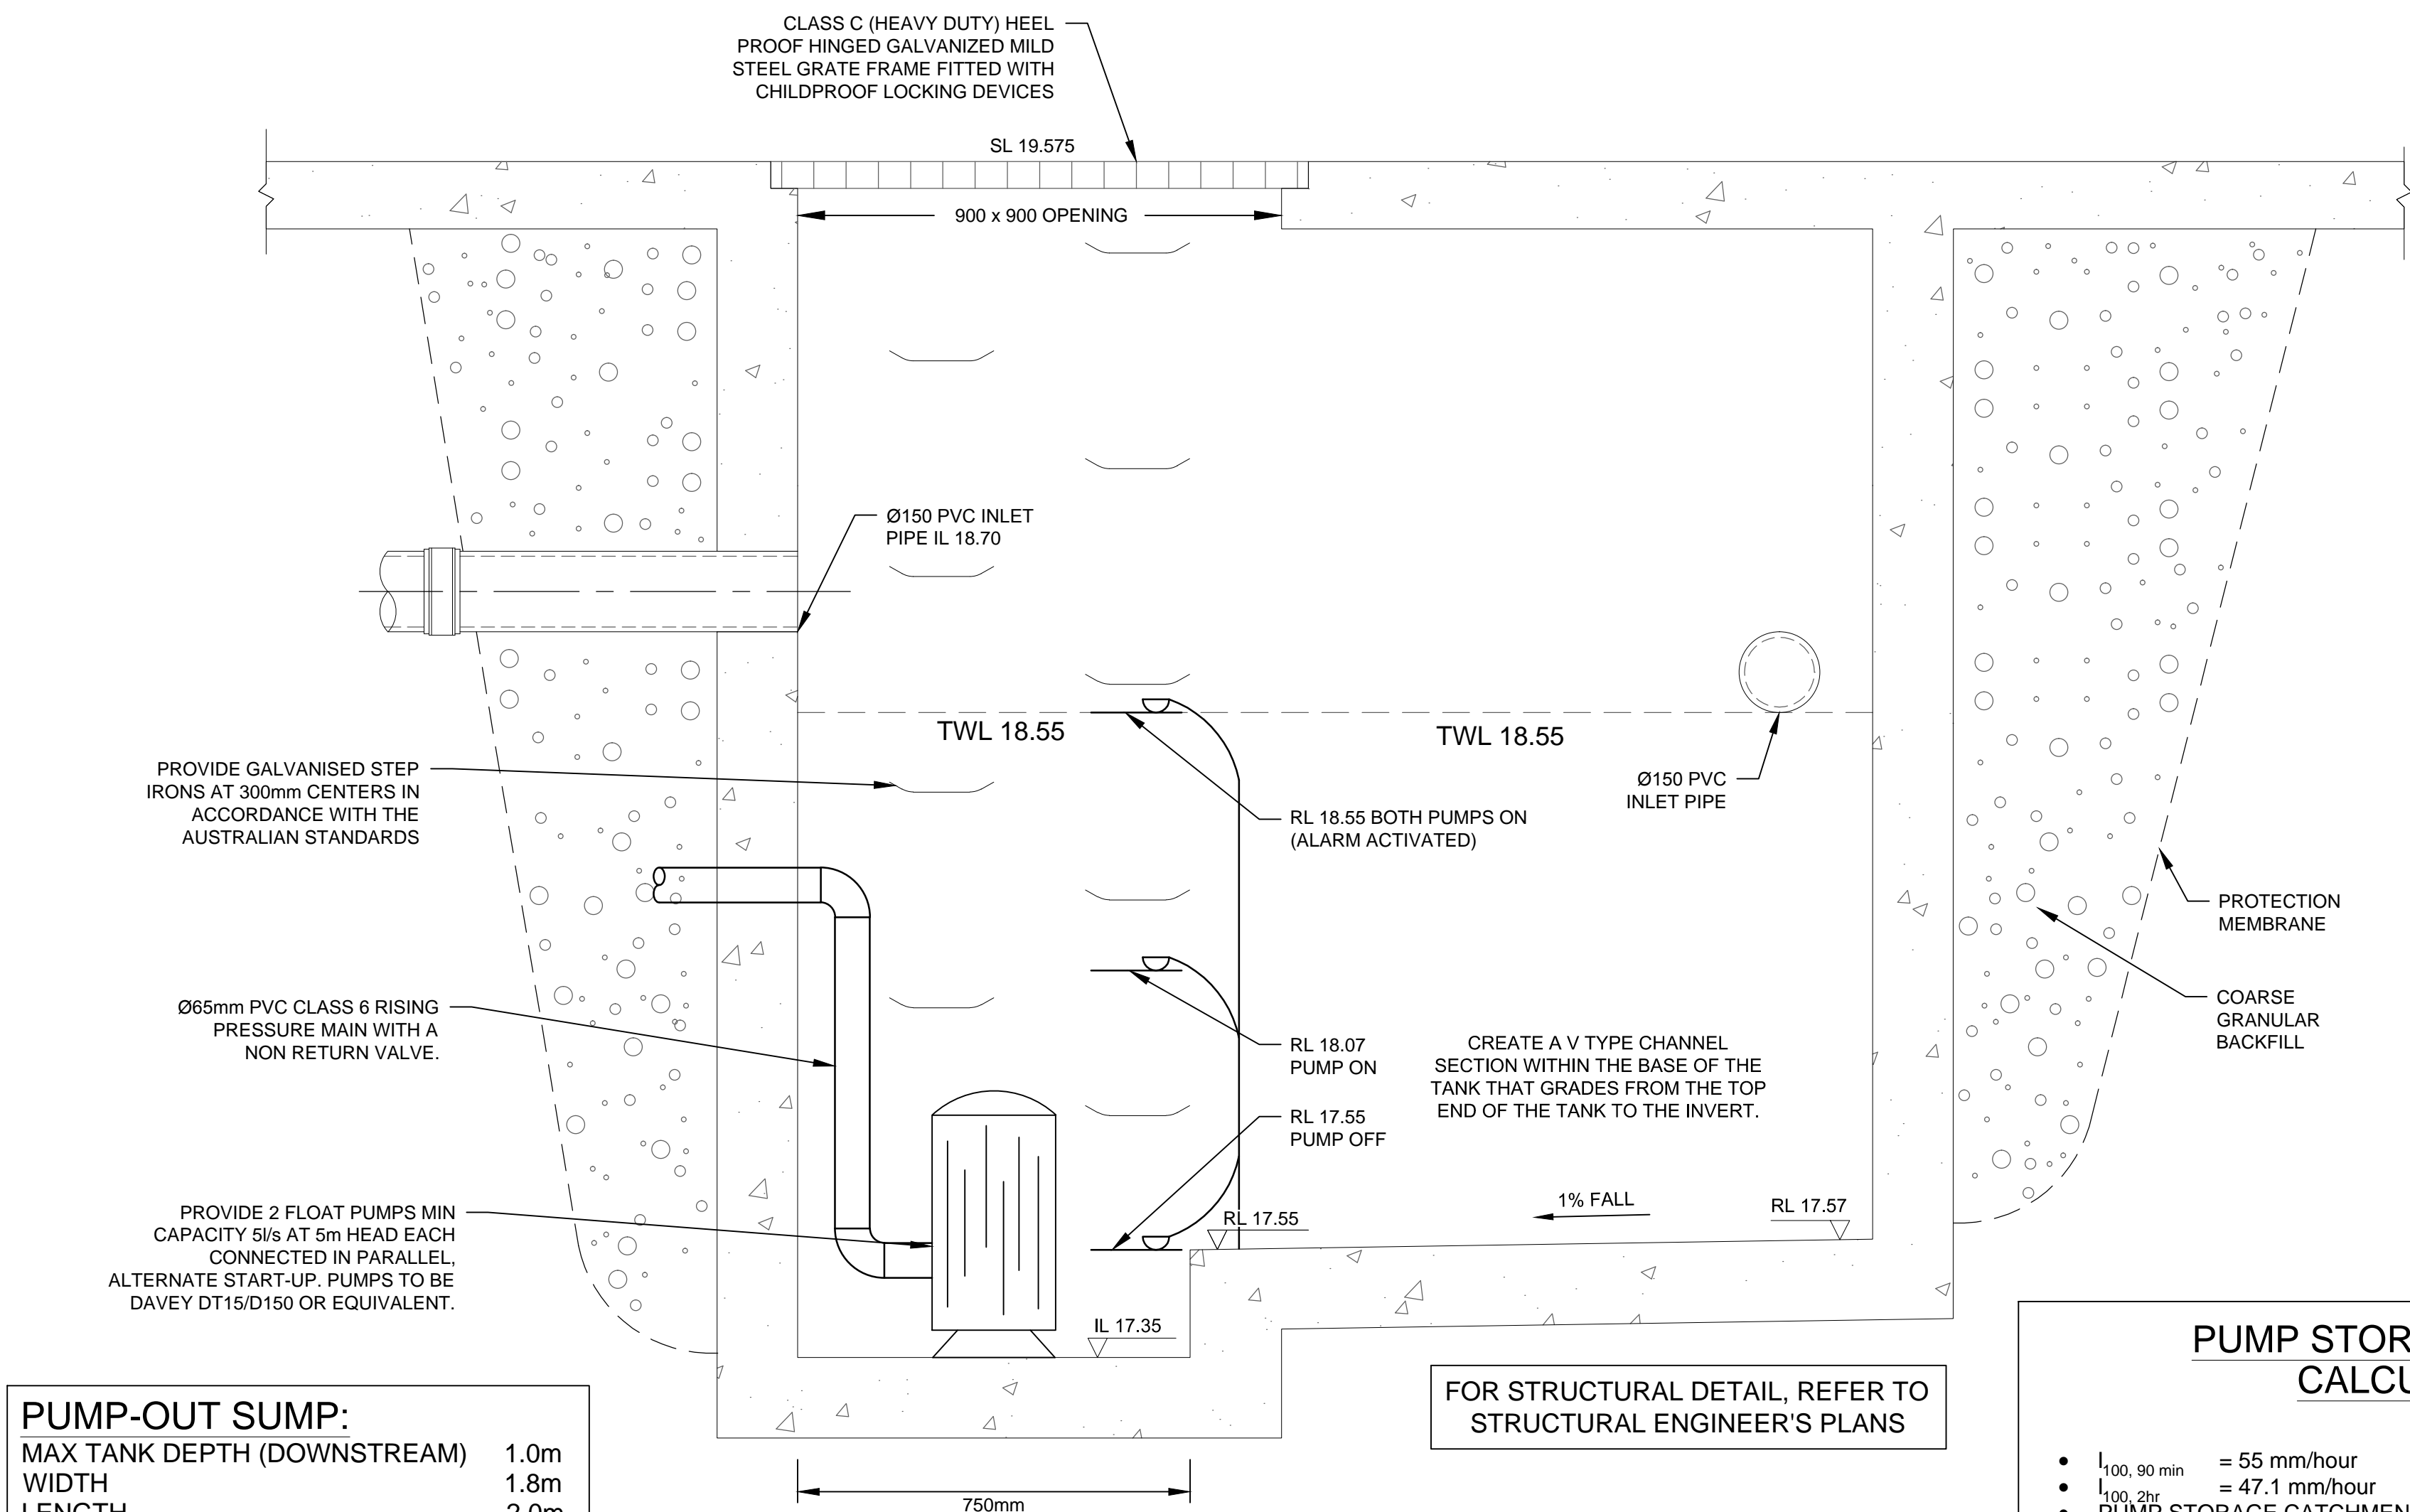
Council
Cumberland
Council

Scale
0 2 4 6m
SCALE 1:100 @ A1

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Project
78 - 84 BURSILL STREET, GUILDFORD
PROPOSED RESIDENTIAL UNITS DEVELOPMENT
STORMWATER MANAGEMENT PLAN
CONSTRUCTION CERTIFICATE

Drawing Title	Scale	A1	Project No.	Dwg. No.	Issue
STORMWATER LAYOUT PLAN BASEMENT LEVEL SHEET 1 OF 2	1:100		171716	101	C



PUMP-OUT SUMP:
MAX TANK DEPTH (DOWNSTREAM) 1.0m
WIDTH 1.8m
LENGTH 2.0m
VOLUME PROVIDED 3.6m³


SECTION A STORMWATER PUMP-OUT SUMP

SCALE 1:10

FOR STRUCTURAL DETAIL, REFER TO
STRUCTURAL ENGINEER'S PLANS

PUMP STORAGE VOLUME CALCULATION


- $I_{100, 90 \text{ min}} = 55 \text{ mm/hour}$
- $I_{100, 2 \text{ hr}} = 47.1 \text{ mm/hour}$
- PUMP STORAGE CATCHMENT AREA: $A = 62.0 \text{ m}^2 = 0.0062 \text{ ha}$
- $Q = C \times I \times A / 360$ WHERE $C = 1.0$ (REFER TO AS3500.3.5.4.6 (a))
 $= 1.0 \times 55 \times 0.0062 / 360$
 $= 0.000947 \text{ m}^3/\text{s}$
 $= 0.947 \text{ L/s}$
- THEREFORE, THE PUMP HOLDING TANK VOLUME IS:
 $V = 0.947 \times 3600$
 $= 3.409 \text{ m}^3$
- ABOVE GROUND STORAGE VOLUME:
 $Q = 1.0 \times 47.1 \times 0.0062 / 360$
 $= 0.811 \text{ L/s}$
 $V = 0.811 \times 3600$
 $= 2.92 \text{ m}^3$

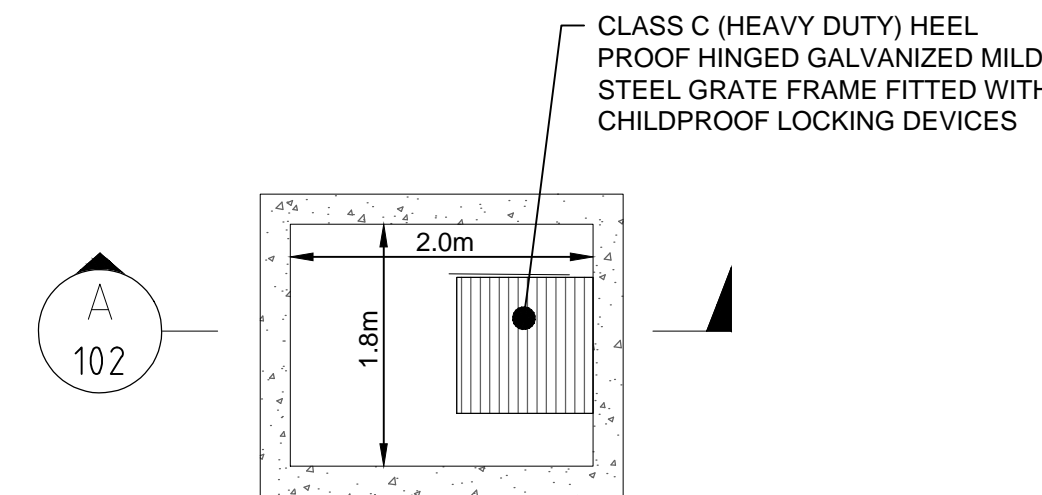

NOTE:
1- FOR ALL THE STRUCTURAL DETAILS, REFER TO STRUCTURAL ENGINEER'S PLAN.
2- ALL THE AG LINES BEHIND BASEMENT WALLS TO BE CONNECTED TO PUMP-OUT SUMP.

PUMP-OUT SUMP DETAIL PLAN VIEW


SCALE 1:50

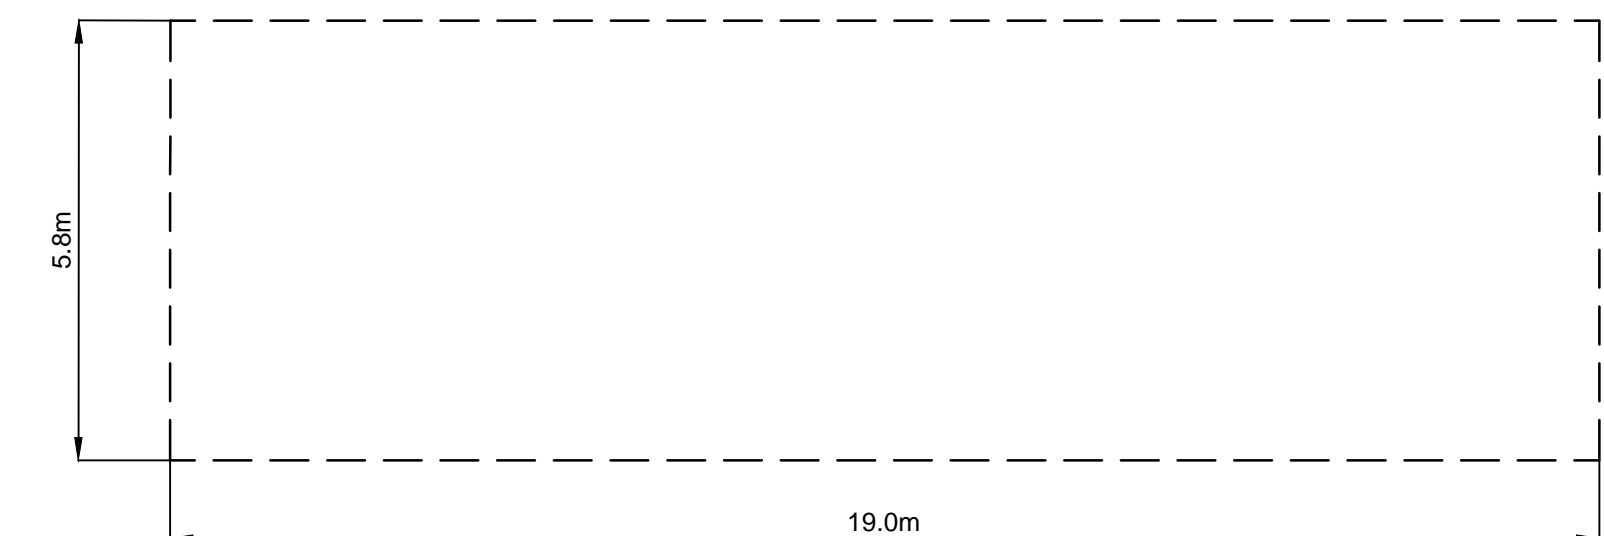

ABOVEGROUND STORAGE DIMENSIONS

SCALE 1:100

Volume Calculations				Pump Selection		
Pump Tank				Pumps		
Length	Width	Depth	Volume (cu.m)	2 Of Davey DT15/D150		
2	1.8	1	3.6	Rising Main 65mm Diameter Class 12 PVC pipe		
Above Ground						
R.L.	Area	Volume (cu.m)		PUMP Storage Summary		
19.98	0.00	3.03		Storage	Required (cu.m)	Provide (cu.m)
20.04	110.00			Pump Tank	3.41	3.60
Total = 6.63 (cu.m)				Above Ground	2.92	3.03
				Total	6.33	6.63

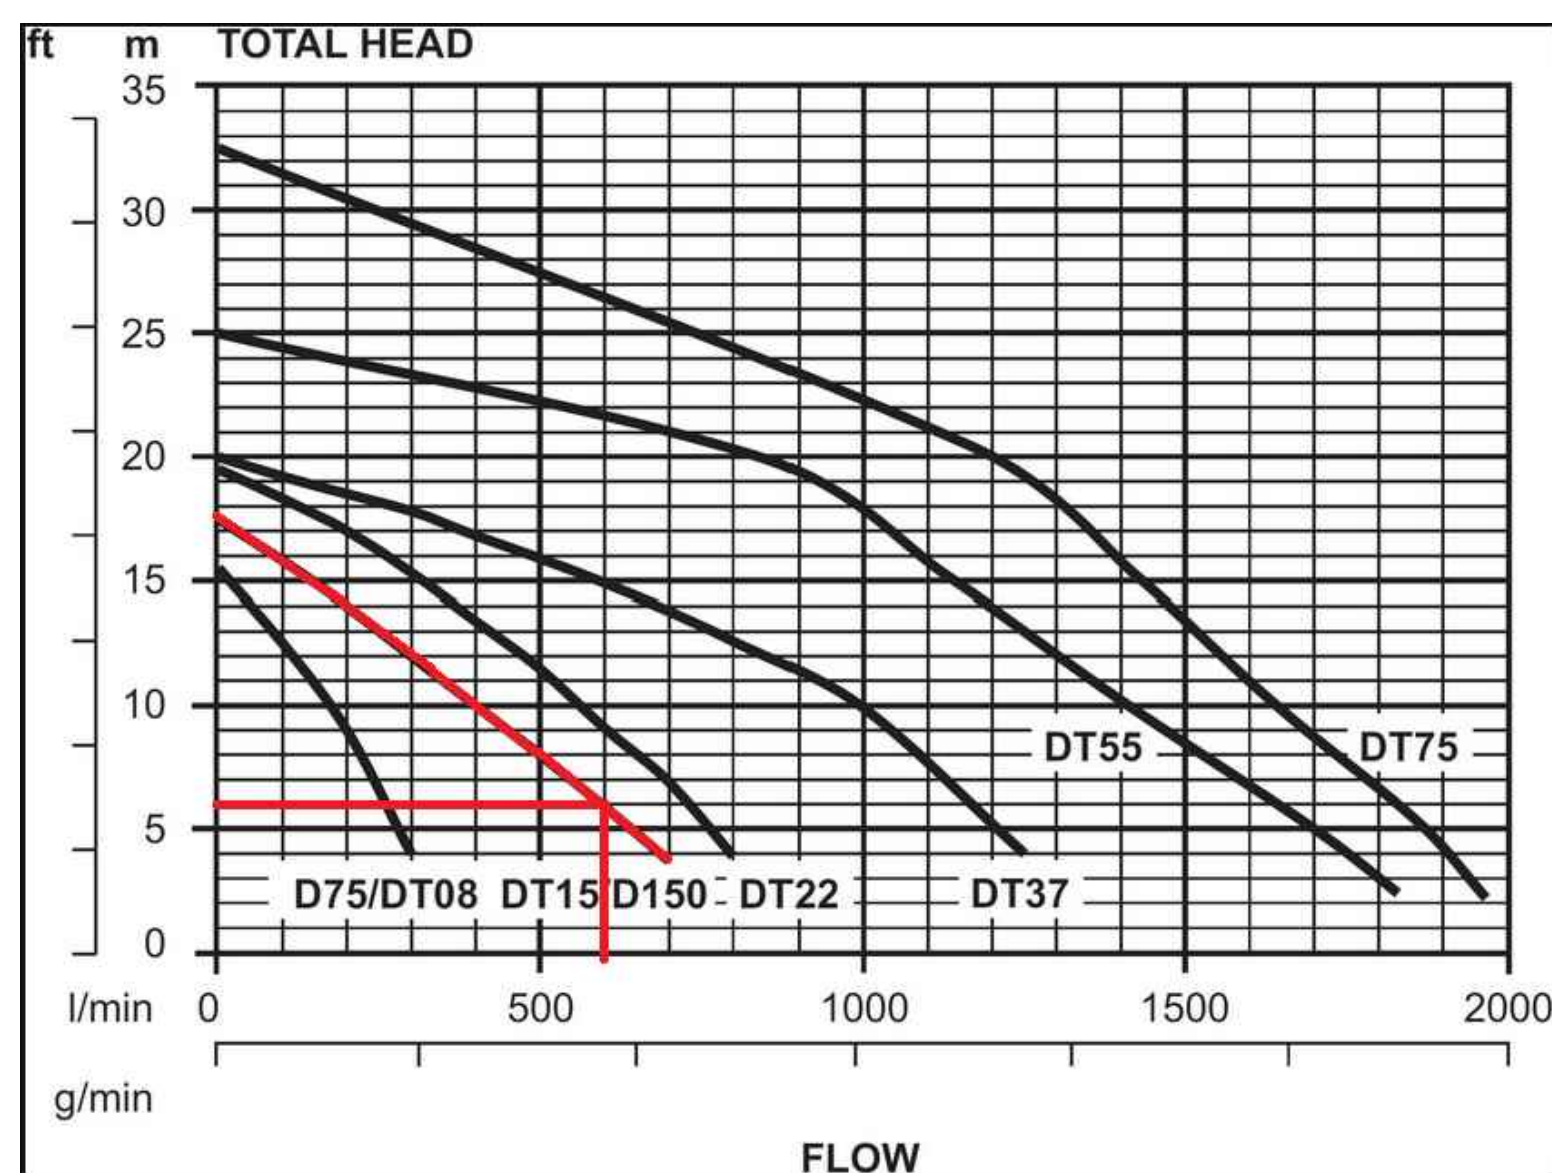

PUMP CALCULATIONS	
Project Address:	78-84 Bursill Street, Guildford

$HL = (3.35 \times 10 \times Q / (d^2 \times 63 \times C))^2 \times 1.852$
HL(m/100m), Q(L/s), d(mm)

$h1 = kv^2 / 2g$
k(cum), v(m/s), g=9.8(m/s ²)

$$H(\text{total head}) = H_f + h1 + \text{Elevation Head (static head)}$$

Elevation Head(m) = 5

Pipe Length(m) = 8

Hazen - Williams C = 145

Hazen-Williams Constant

125-140 Commercial steel pipe

135-140 Bitumen Lined Cast iron pipe

140-145 Copper Tube

145-150 PVC

Q(L/s)		0	1	2	3	4	5	6	7	8	9	10
HL(m/100m)		0.00	0.18	0.64	1.36	2.32	3.51	4.92	6.55	8.39	10.44	12.68
Hf(m)	HL x pipe Length/100	0.00	0.01	0.05	0.11	0.19	0.28	0.39	0.52	0.67	0.83	1.01
v(m/s)	Q(L/s) / area of pipe crossing section	0.00	0.30	0.60	0.90	1.21	1.51	1.81	2.11	2.41	2.71	3.01
h1(m)	$k(\text{cum}) \times v(\text{m/s})^2 / 2 \times g$	0.00	0.05	0.19	0.42	0.76	1.18	1.70	2.31	3.02	3.82	4.72
H(m)	= Hf + H1 + Elevation Head	5.00	5.06	5.24	5.53	5.94	6.46	7.09	7.84	8.69	9.66	10.74

UNDERGROUND PUMP - OUT SUMP STAGED STORAGE CALCULATIONS

DEPTH (mm)	AREA (m ²)	CUMULATIVE VOLUME (m ³)
0	3.6	0
100	3.6	0.36
200	3.6	0.72
300	3.6	1.08
400	3.6	1.44
500	3.6	1.80
600	3.6	2.16
700	3.6	2.52
800	3.6	2.88
900	3.6	3.24
1000	3.6	3.60

0 2 4 6 m

SCALE 1:100 @ A1

Issue	Description	Date	Design	Engineer
C	ISSUE FOR S.455 MODIFICATION	09/12/2018	E.Y.	O.C.
B	ISSUE FOR SECTION 96 APPROVAL	27/08/2018	A.S.	J.B
A	ISSUE FOR CONSTRUCTION CERTIFICATE	28/05/2018	A.S.	J.B

Certification By:

[Signature]

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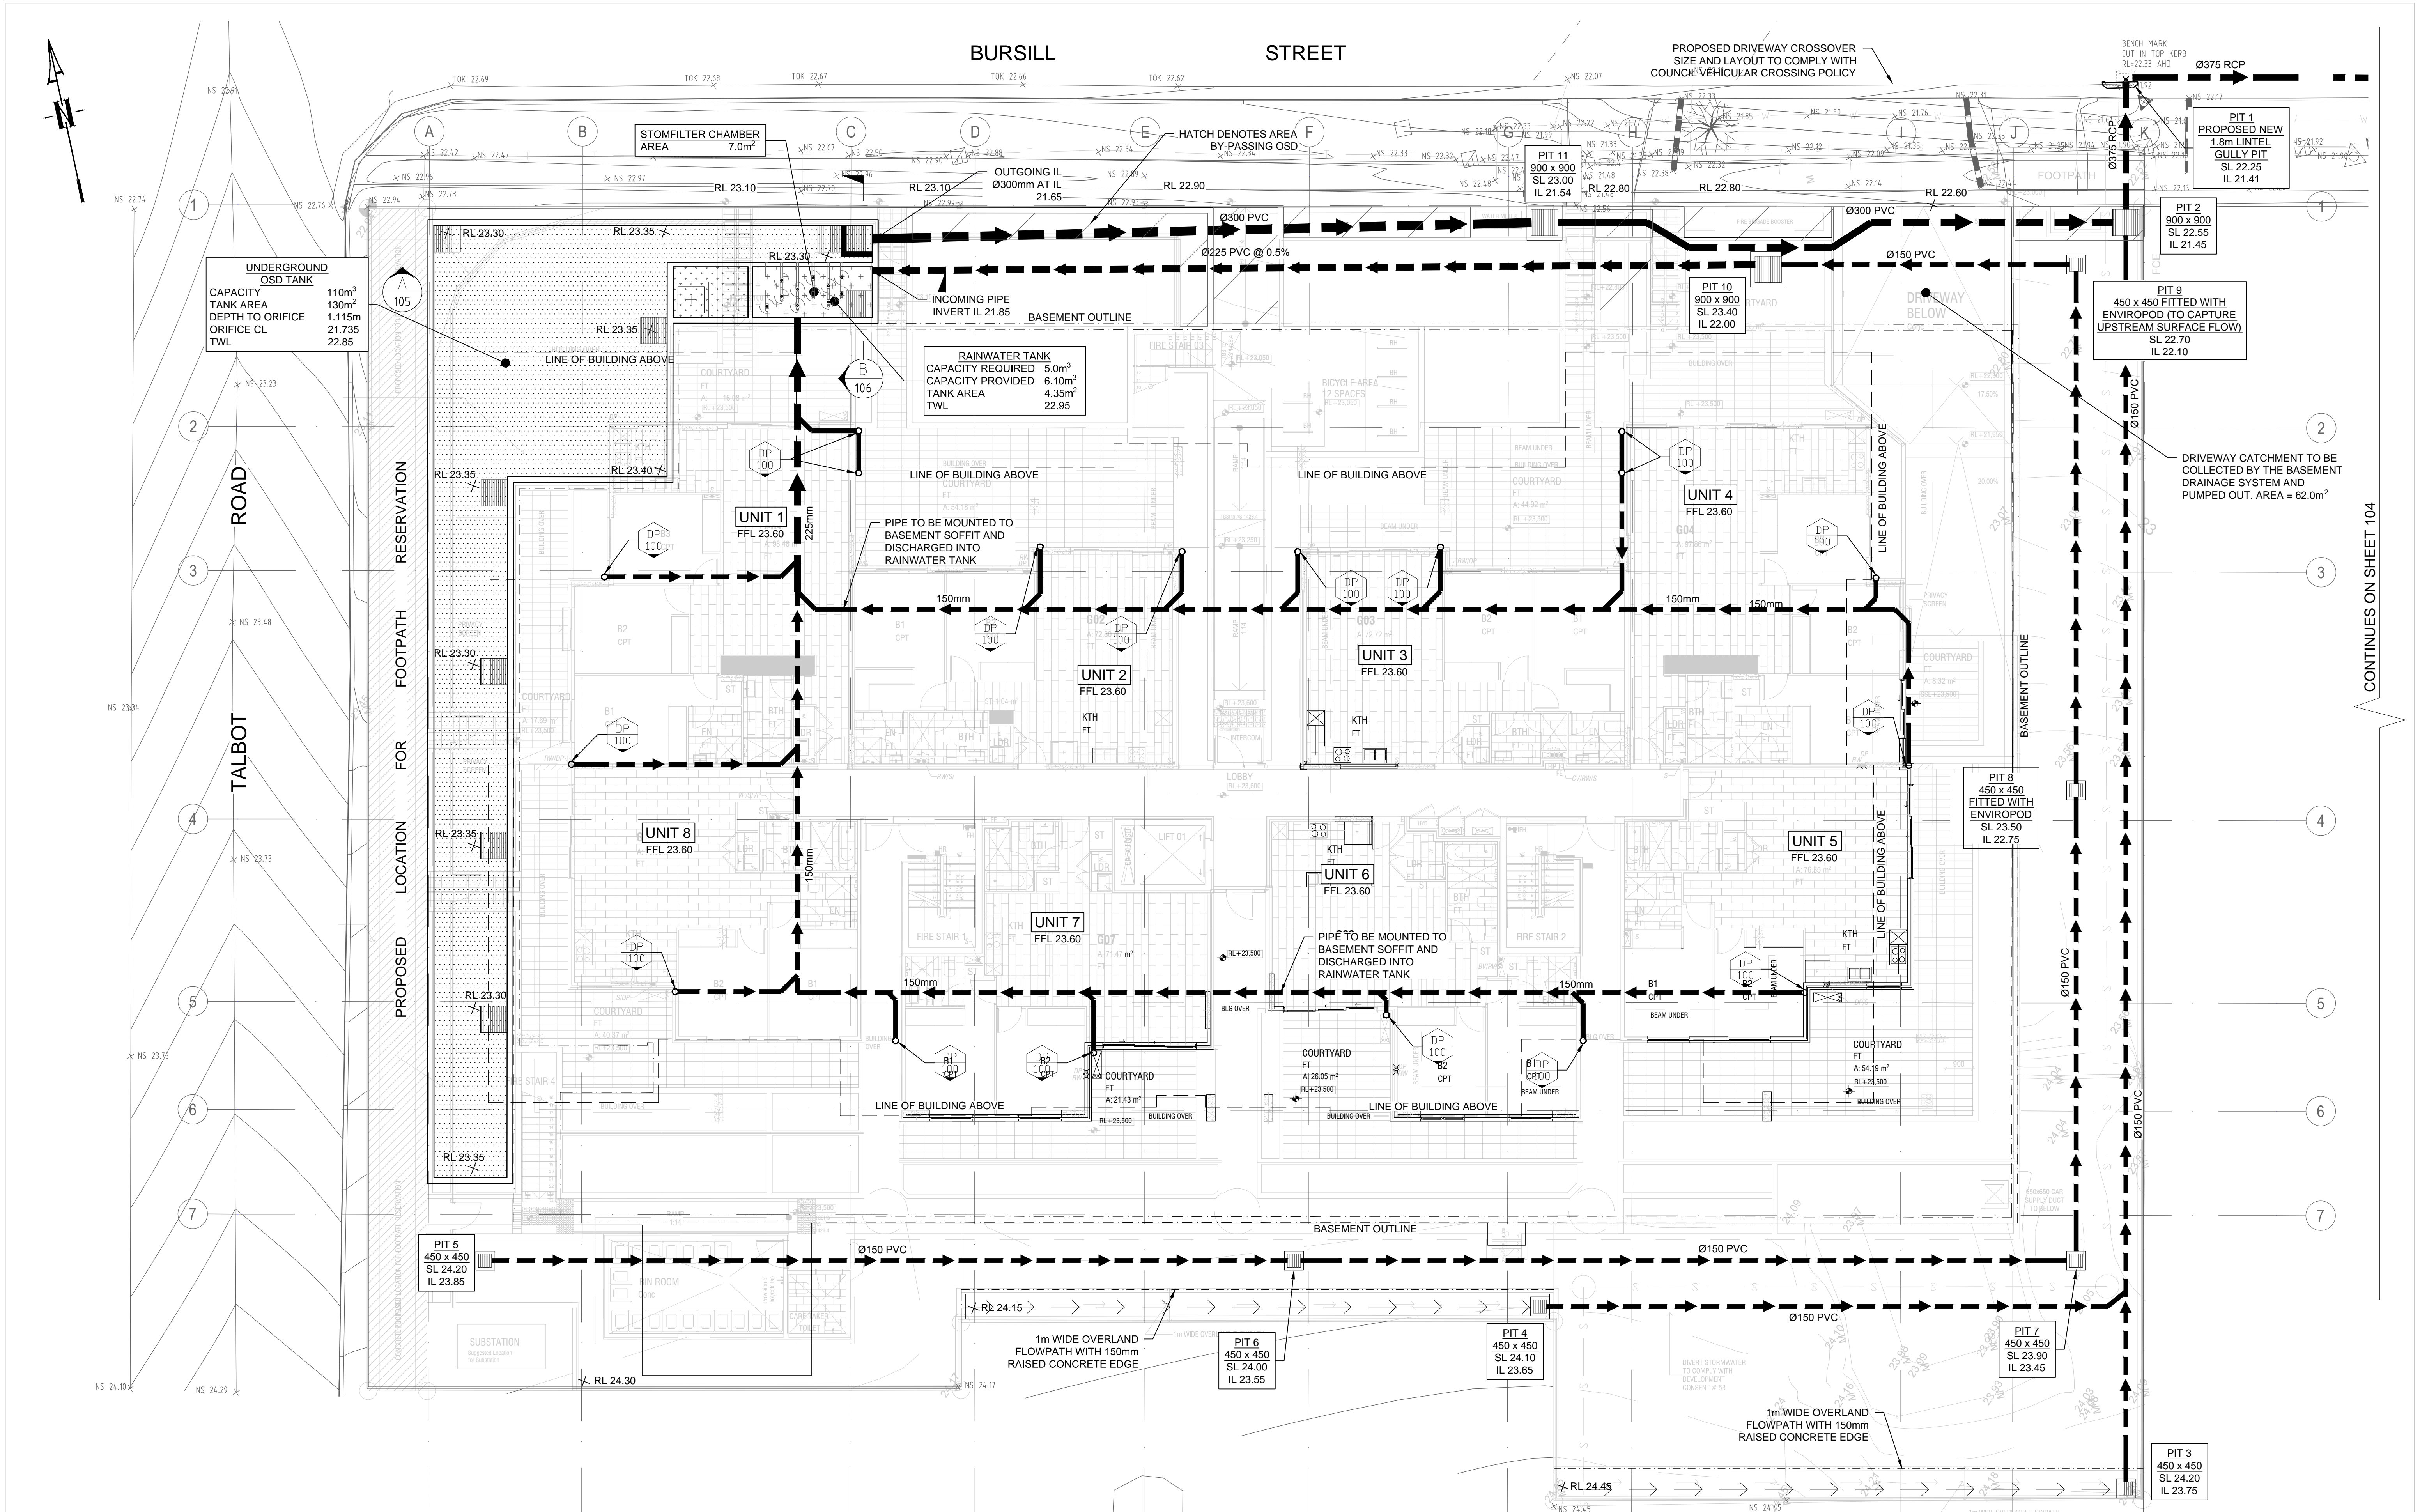
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Scale
0 200 400 600mm
SCALE 1:10 @ A1
0 1 2 3 m
SCALE 1:50 @ A1

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
Project
78 - 84 BURSILL STREET, GUILDFORD
PROPOSED RESIDENTIAL UNITS DEVELOPMENT
STORMWATER MANAGEMENT PLAN
CONSTRUCTION CERTIFICATE

Drawing Title
STORMWATER CONCEPT PLAN
BASEMENT LEVEL
SHEET 2 OF 2
Scale A1 Project No. 171716 Dwg. No. 102 Issue C



GROUND FLOOR PLAN
SCALE 1:200

Issue	Description	Date	Design	Engineer
C	ISSUE FOR S.455 MODIFICATION	09/12/2018	E.Y.	O.C.
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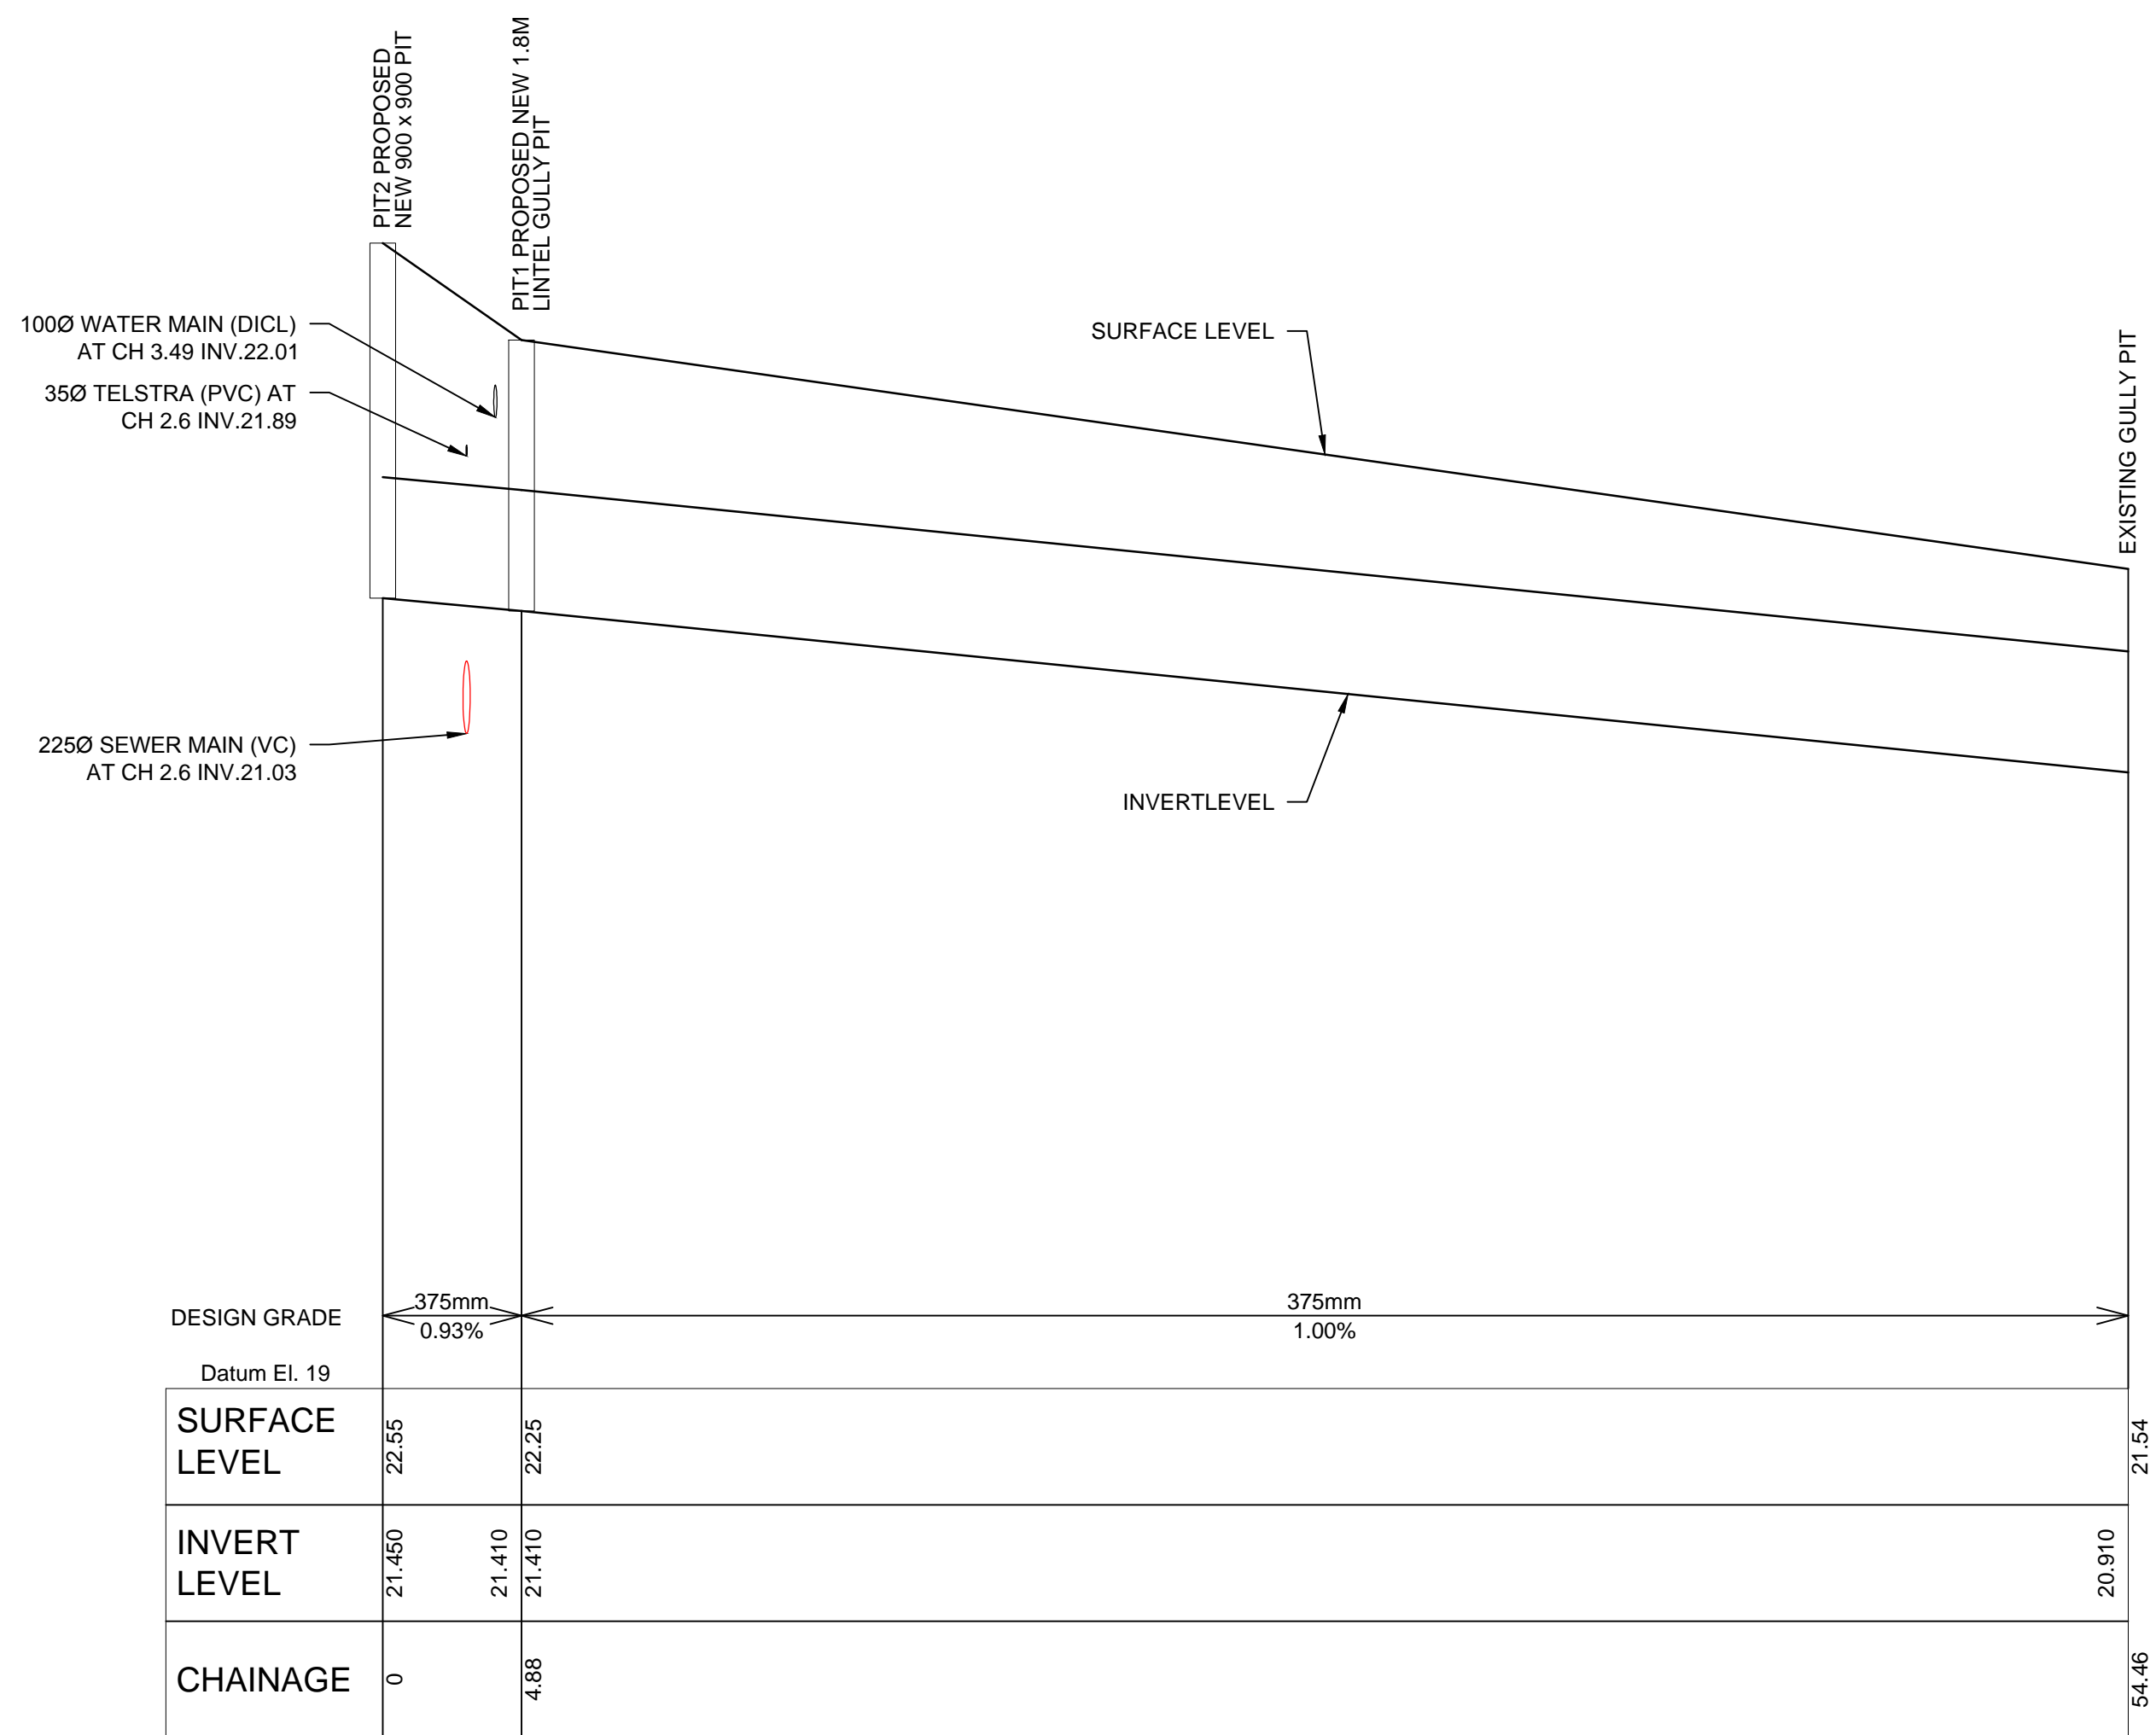
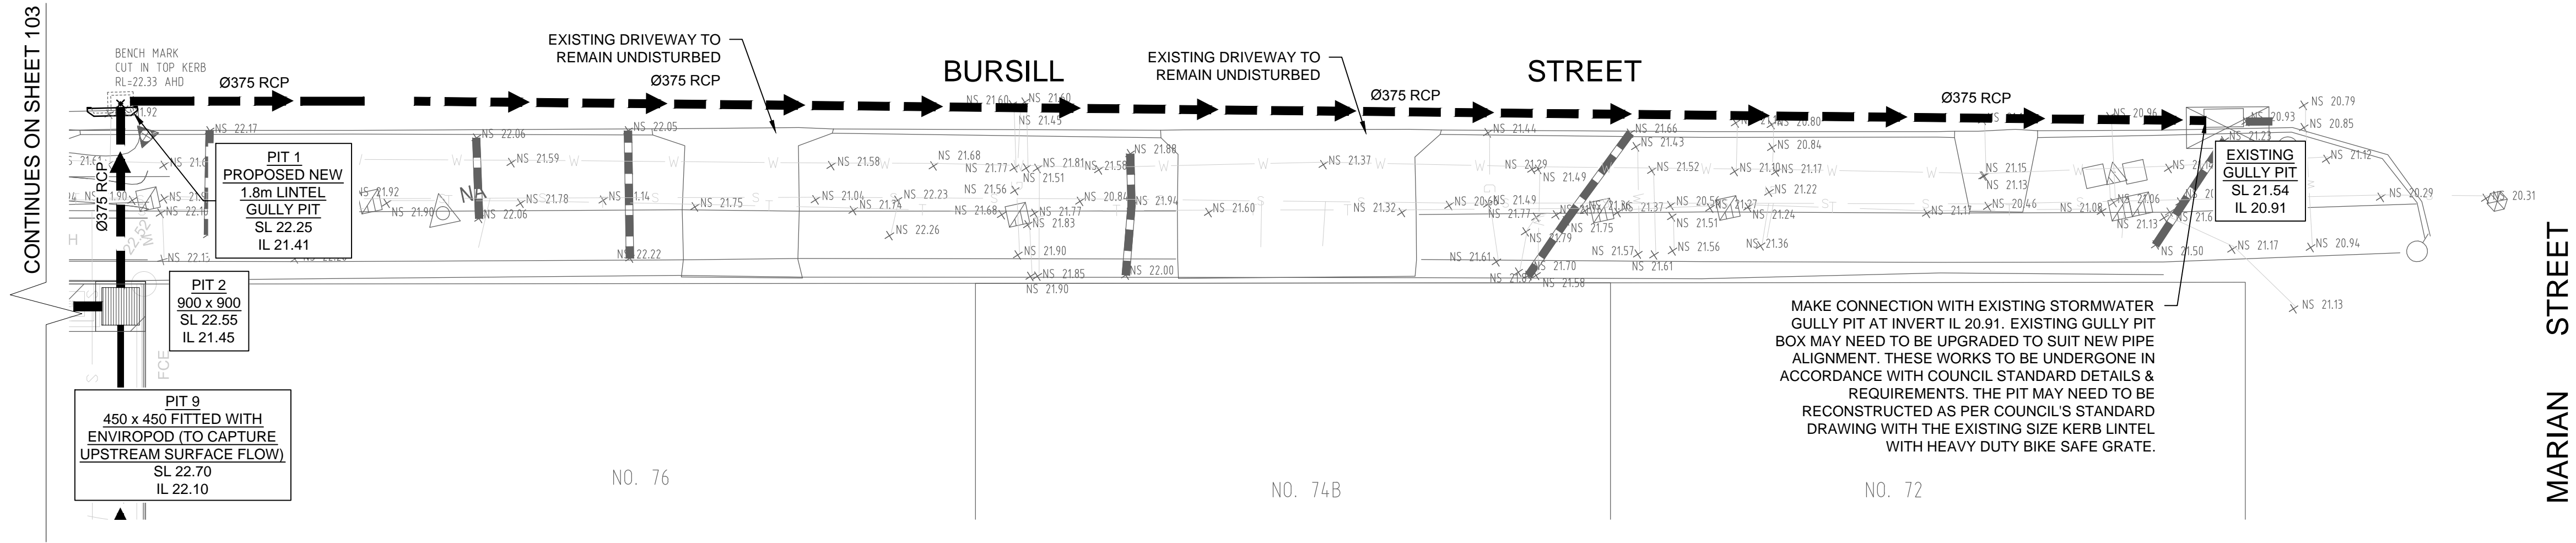
Council
Cumberland
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Scale
0 2 4 6 m
SCALE 1:100 @ A1


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CONSTRUCTION CERTIFICATE


Drawing Title
STORMWATER MANAGEMENT
PLAN GROUND LEVEL
SHEET 1 OF 2
Scale A1 Project No. 171716 Dwg. No. 103 Issue C



LONGITUDINAL SECTION NOTE:
AS PER UTILITY PLAN PRODUCED BY "DURKIN: DATED 16-14-2018 FOR THE SUBJECT SITE. THE TWO UTILITIES (SEWER MAIN & WATER MAIN) WHICH ARE CROSSING THE STORMWATER OUTLET PIPE HAVE BEEN SHOWN WITH QUALITY LEVEL B (AS PER A5 5488-2013) WHICH HAS +/-300mm HORIZONTAL TOLERANCE & +/-500 VERTICAL TOLERANCE. CONTRACTOR, MUST POTHOLE THE UTILITIES (WITH NON DESTRUCTIVE DIGGING METHOD) AND CONFIRM THAT THESE UTILITIES DON'T CLASH WITH THE PROPOSED OUTLET PIPE. IF ANY CLASHES FOUND, SERVICES PROVIDES TO BE INFORMED FOR SERVICES RELOCATION BEFORE ANY CONSTRUCTION WORKS.


STORMWATER LONGITUDINAL SECTION
SCALE (H) 1:250
(V) 1:100

C	ISSUE FOR S.455 MODIFICATION	09/12/2018	E.Y.	O.C.
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A	ISSUE FOR CONSTRUCTION CERTIFICATE	28/05/2018	A.S.	J.B
Issue	Description	Date	Design	Engineer
1cm at full size				
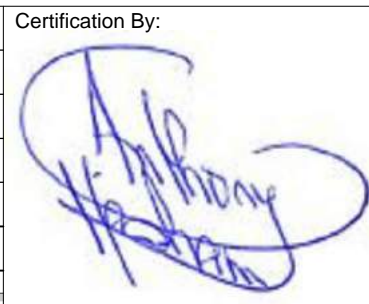
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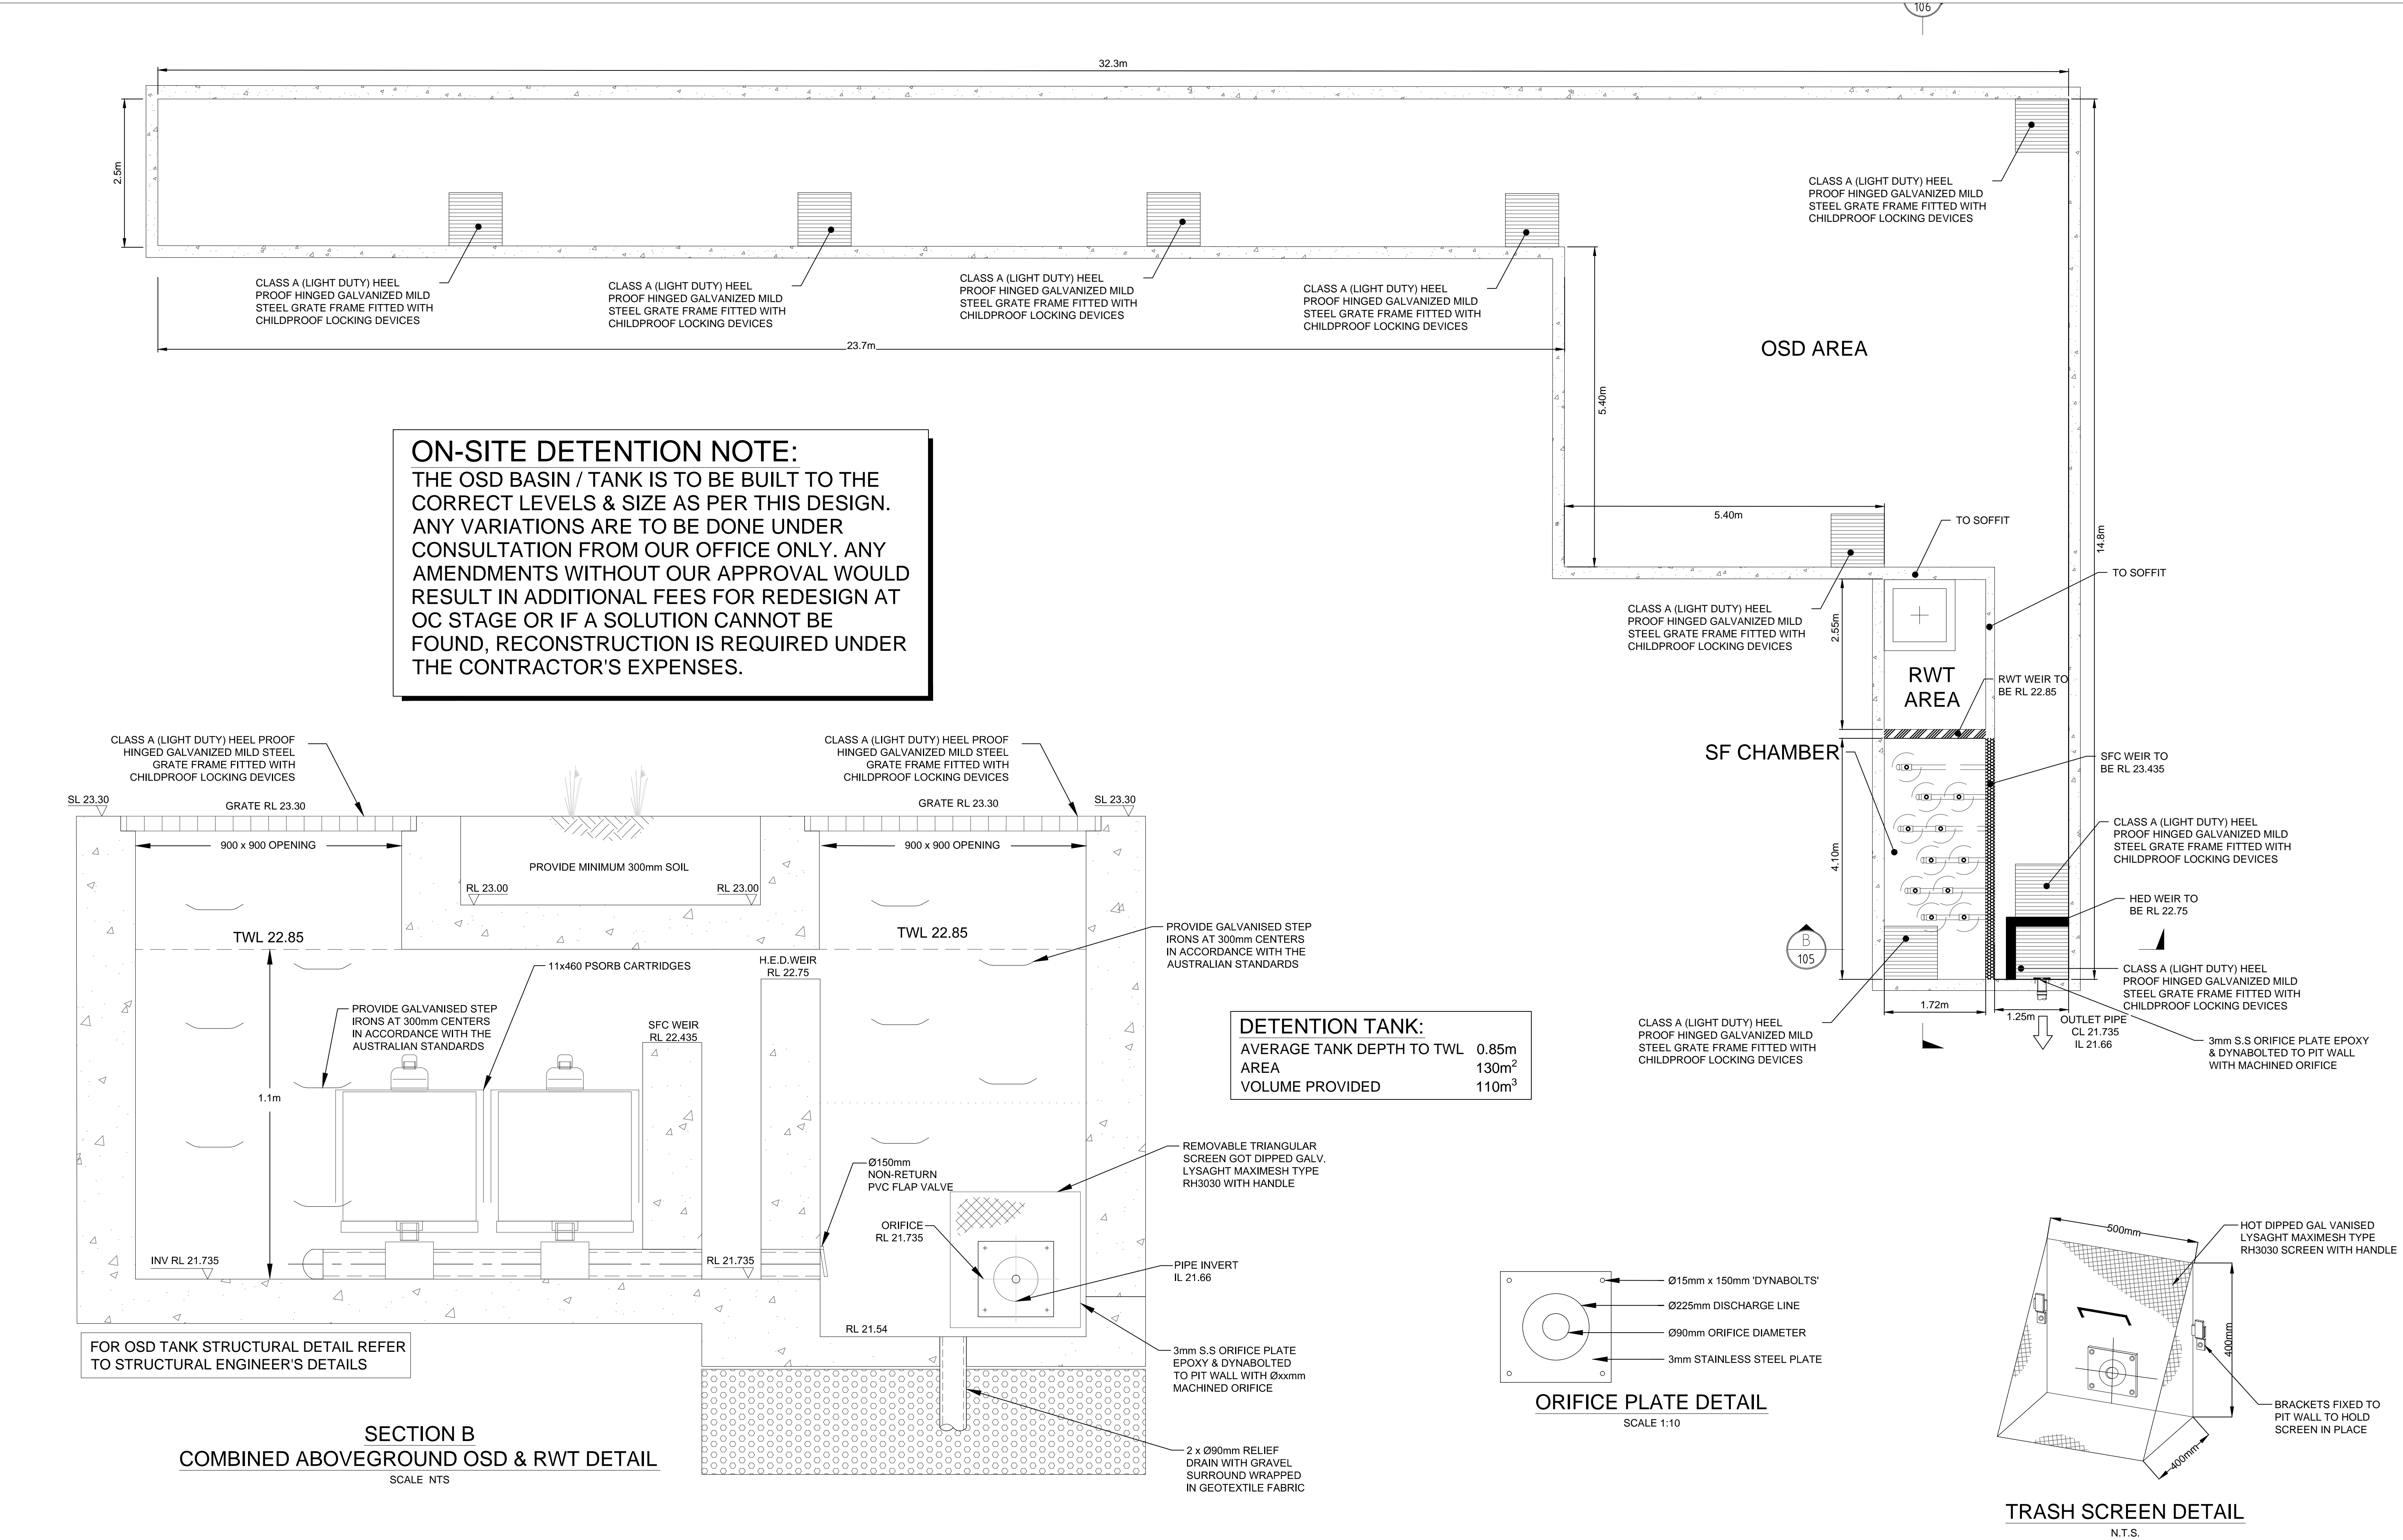
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Scale

SCALE 1:100 @ A1


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STORMWATER MANAGEMENT PLAN
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Drawing Title	STORMWATER MANAGEMENT PLAN GROUND LEVEL SHEET 2 OF 2			
Scale	A1	Project No.	Dwg. No.	Issue
1:100		171716	104	C

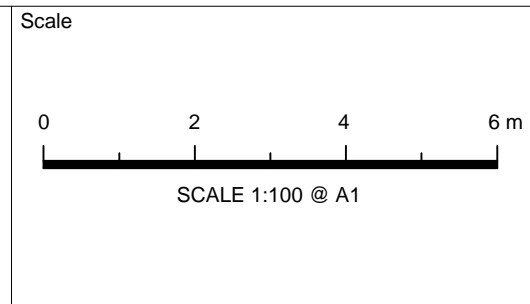

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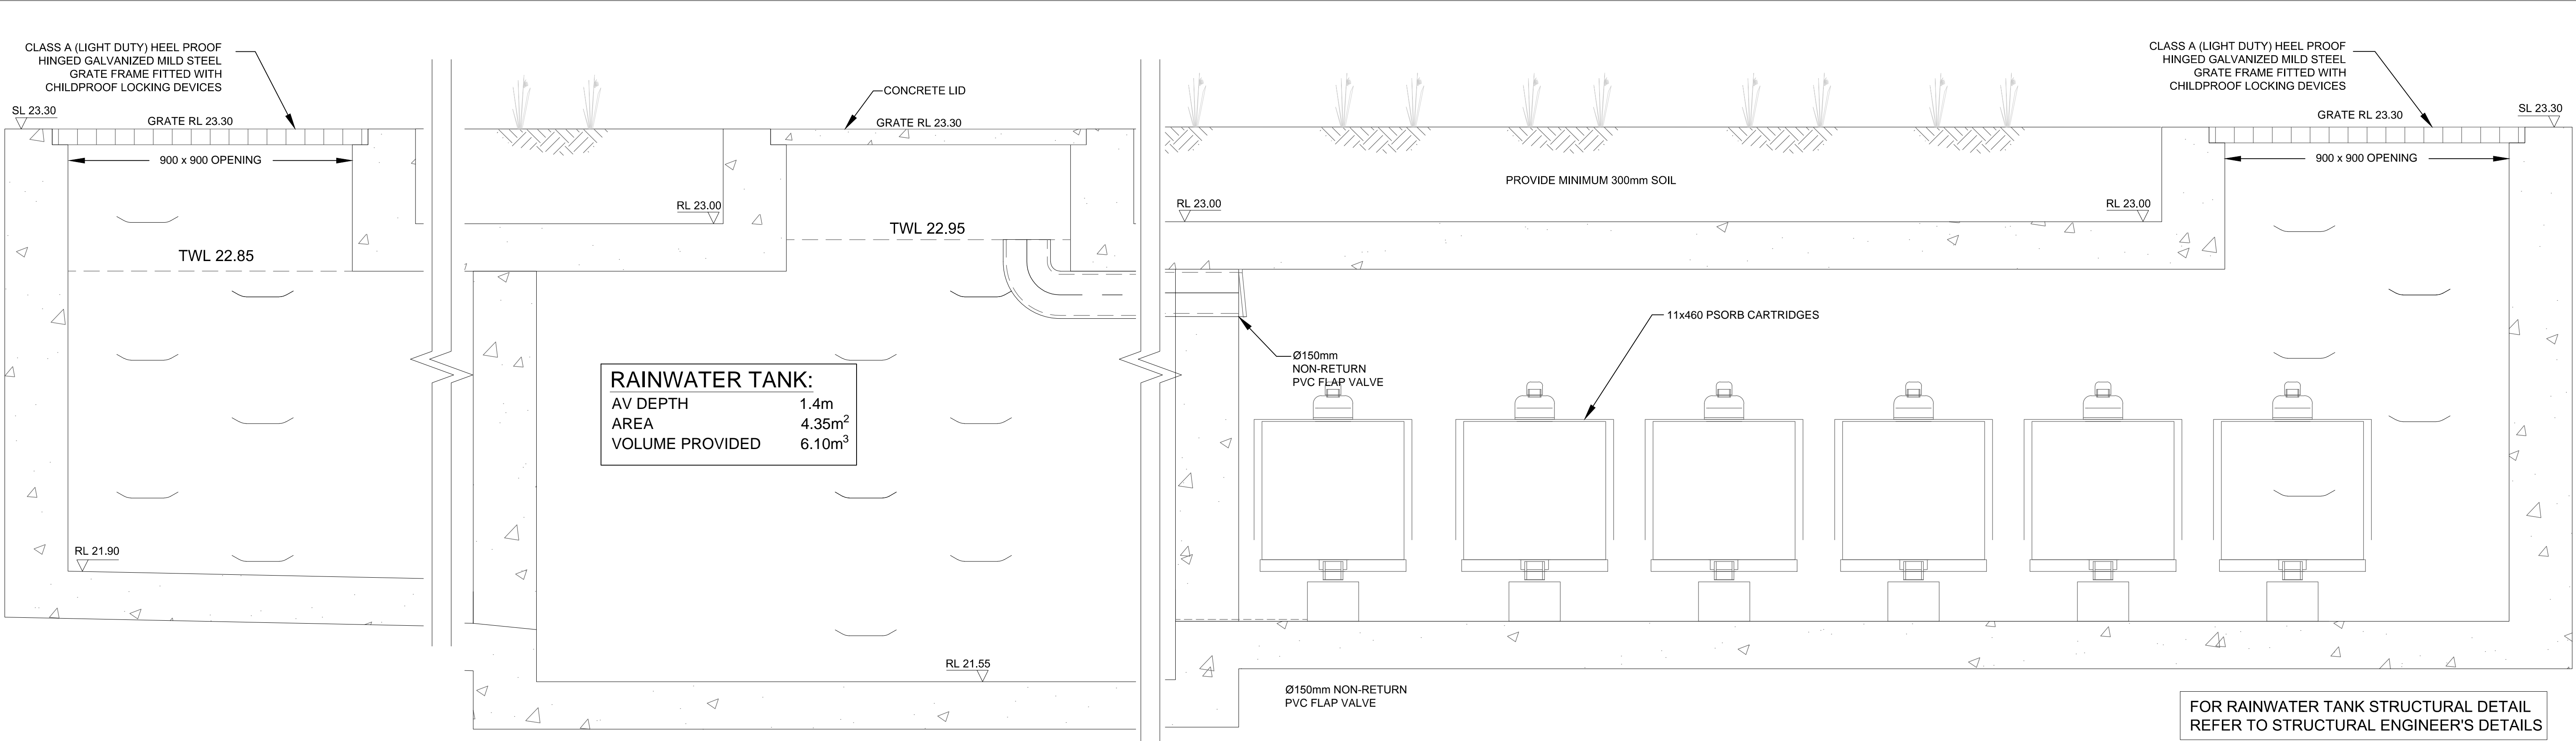
Council
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Scale
0 200 400 600mm
SCALE 1:10 @ A1
0 1 2 3 m
SCALE 1:50 @ A1

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STORMWATER MANAGEMENT PLAN
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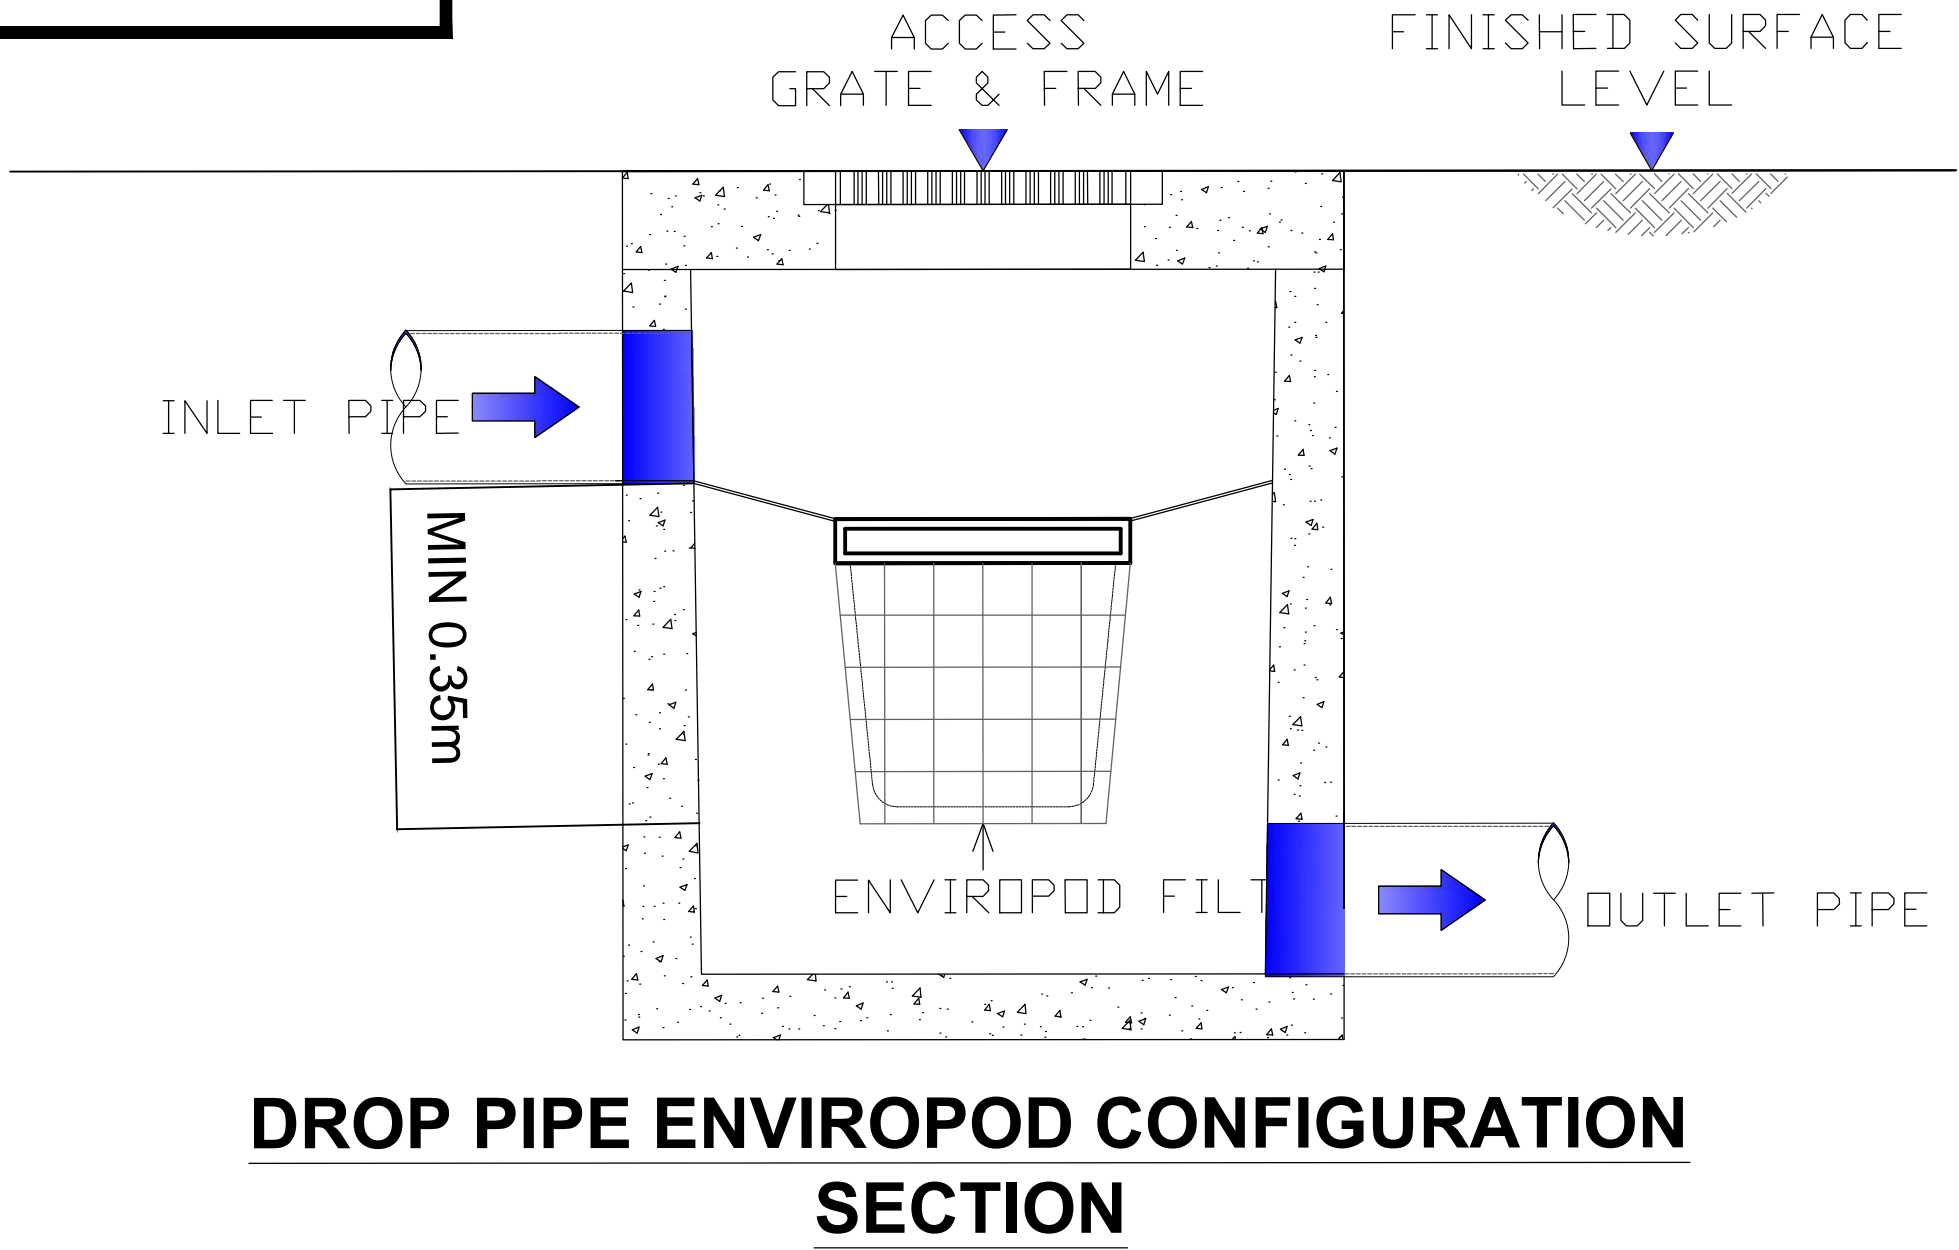
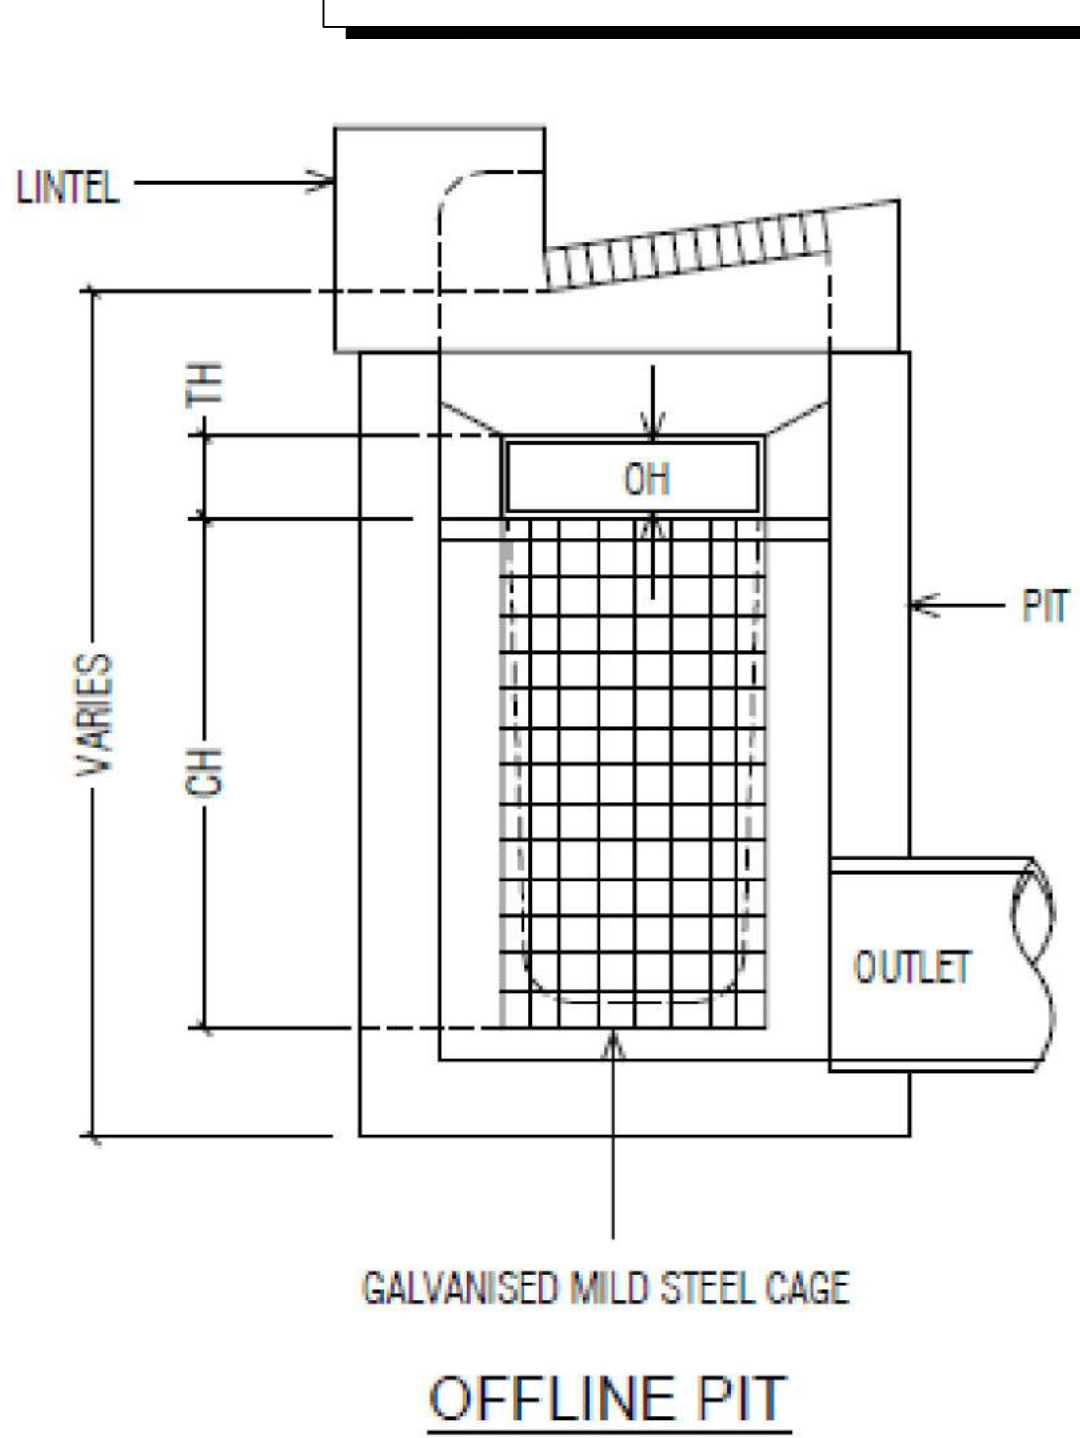
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Scale	A1	Project No.	171716		
As Shown					



SECTION A
COMBINED ABOVEGROUND OSD & RWT DETAIL
SCALE 1:10


ON-SITE DETENTION NOTE:
THE OSD BASIN / TANK IS TO BE BUILT TO THE CORRECT LEVELS & SIZE AS PER THIS DESIGN. ANY VARIATIONS ARE TO BE DONE UNDER CONSULTATION FROM OUR OFFICE ONLY. ANY AMENDMENTS WITHOUT OUR APPROVAL WOULD RESULT IN ADDITIONAL FEES FOR REDESIGN AT OC STAGE OR IF A SOLUTION CANNOT BE FOUND, RECONSTRUCTION IS REQUIRED UNDER THE CONTRACTOR'S EXPENSES.

DRAINAGE DESIGN SUMMARY			
PROJECT: Residential Development (OSD Tank)		LOCATION: 78-84 Bursill Street GUILDFORD	
DESIGNED BY: DR. ANTHONY HASHAM		COMPANY: AUSTRALIAN CONSULTING ENGINEERS	
		PHONE: (02) 9763 1500	
Area (Ha) =	0.2354	[A]	excluding footpath reservation
Storage Figure =	470.000		
Volume Figure =	0.08		
Basic Volume (m³) =	111	[B]	storage figure x [A]
Basic Discharge (m³/sec) =	0.019	[C]	volume figure x [A]
Area Drained to Storage (Ha) at least 85% =	0.230	[D]	
Percentage Area Drained to Storage [D]/[A] =	0.98	[E]	
Storage per ha. of Contributing Area [B]/[D] =	481.03	[F]	
Enter Volume/PSD. Adjustment chart (Fig. 5.1) using [F], and read new PSD in L/s/ha	78.19	[G]	[F] = 74.66xPSD ^{0.731}
Determine PSD (l/s) = [G] X [D]	17.98	[H]	
Weir flow to storage H(Weir) m		[I]	Q = CLH ^{1.5}
Maximum Head to Orifice Centre (m) =	0.92	[K]	Head includes HFD
Select Orifice Diameter (m) =	0.09	[J]	Use Final discharge PSD [H]
Maximum Discharge (m³) =	17.98	[L]	
Head for High Early Discharge	0.99	[M]	Q ₂ = CLH ^{1.5} , Q ₂ = (CIA/360 - Final PSD [H]), A = Area directed to storage by pits, H = Q ₂ /1.6x0.9xH ^{2/3}
High Early Discharge [L] x ([M]/[K]) ^{0.5}	18.66	[N]	
Approximate Mean Discharge	18.32	[P]	
Average Discharge/ha = [P]/[D]	79.65	[Q]	
Enter Volume/PSD. Adjustment Chart (Fig. 5.1) using [F], and read new PSD in l/s	474.57	[R]	
Determine Final SSR = [R]x[D]	109.15	[S]	
Primary storage proportion m³		[T]	[S] x %
Secondary storage proportion m³		[U]	[S] x %
Tertiary storage proportion m³		[V]	[S] x %
Check [T] + [U] + [V] = [S] m³	25.42		




SEDIMENT & EROSION NOTES

1. IMMEDIATELY FOLLOWING SETTING OUT OF THE WORKS, BUT PRIOR TO COMMENCEMENT OF ANY CLEARING OR EARTHWORKS, THE CONTRACTOR AND SUPERINTENDENT SHALL WALK THE SITE TO NOMINATE THE LOCATIONS AND TYPES OF SEDIMENT AND EROSION CONTROL MEASURES TO BE ADOPTED. THESE MEASURES SHALL BE IMPLEMENTED PRIOR TO ANY CLEARING OR EARTHWORKS AND MAINTAINED UNTIL THE WORKS ARE COMPLETED AND NO LONGER POSE AN EROSION HAZARD, UNLESS OTHERWISE APPROVED BY THE SUPERINTENDENT.
2. IMMEDIATELY FOLLOWING SETTING OUT OF THE WORKS, BUT PRIOR TO COMMENCEMENT OF ANY CLEARING OR EARTHWORKS, THE CONTRACTOR AND SUPERINTENDENT SHALL WALK THE SITE TO IDENTIFY AND MARK TREES WHICH ARE TO BE PRESERVED. NOTWITHSTANDING THE ABOVE, THE CONTRACTOR SHALL TAKE ALL REASONABLE PRECAUTIONS TO MINIMISE DISTURBANCE TO EXISTING VEGETATION AND GROUND COVER OUTSIDE THE MINIMUM AREAS REQUIRED TO COMPLETE THE WORKS AND SHALL BE RESPONSIBLE FOR RECTIFICATION, AT ITS OWN COST, OF ANY DISTURBANCE BEYOND THOSE AREAS.
3. PROVIDE GULLY GRATE INLET SEDIMENT TRAPS AT ALL GULLY PITS.
4. PROVIDE SILT FENCING ALONG PROPERTY LINE AS DIRECTED BY SUPERINTENDENT.
5. ADDITIONAL CONTROL DEVICES TO BE PLACED WHERE DIRECTED BY THE PRINCIPLE.
6. ALTERNATIVE DESIGNS TO BE APPROVED BY SUPERINTENDENT PRIOR TO CONSTRUCTION.
7. WASH DOWN/RUMBLE AREA TO BE CONSTRUCTED WITH PROVISIONS RESTRICTING ALL SILT AND TRAFFICKED DEBRIS FROM ENTERING THE STORMWATER SYSTEM.
8. NO WORK OR STOCKPILING OF MATERIALS TO BE PLACED OUTSIDE OF SITE WORK BOUNDARY.
9. APPROPRIATE EROSION AND SEDIMENT CONTROLS TO BE USED TO PROTECT STOCKPILES AND MAINTAINED THROUGH OUT CONSTRUCTION.
10. IT IS THE CONTRACTORS RESPONSIBILITY TO TAKE DUE CARE OF NATURAL VEGETATION. NO CLEARING IS TO BE UNDERTAKEN WITHOUT PRIOR APPROVAL FROM THE SUPERINTENDENT.
11. TO AVOID DISTURBANCE TO EXISTING TREES, EARTHWORKS WILL BE MODIFIED AS DIRECTED ON-SITE BY THE SUPERINTENDENT.
12. THE LOCATION OF EROSION AND SEDIMENTATION CONTROLS WILL BE DETERMINED ON SITE BY THE SUPERINTENDENT.
13. ACCESS TRACKS THROUGH THE SITE WILL BE LIMITED TO THOSE DETERMINED BY THE SUPERINTENDENT AND THE CONTRACTOR PRIOR TO ANY WORK COMMENCING.
14. ALL SETTING OUT IS THE RESPONSIBILITY OF THE CONTRACTOR PRIOR TO WORKS COMMENCING ON SITE. THE SUPERINTENDENT'S SURVEYOR SHALL PEG ALL ALLOTMENT BOUNDARIES, PROVIDE COORDINATE INFORMATION TO THESE PEGS AND PLACE BENCH MARKS. THE CONTRACTOR SHALL SET OUT THE WORKS FROM AND MAINTAIN THESE PEGS.
15. PLANS ARE MINIMUM REQUIREMENTS AND ARE TO BE USED AS A GUIDE ONLY. EXACT MEASURES USED SHALL BE DETERMINED ON SITE IN CONJUNCTION WITH PROGRAM OF CONTRACTORS WORKS etc.

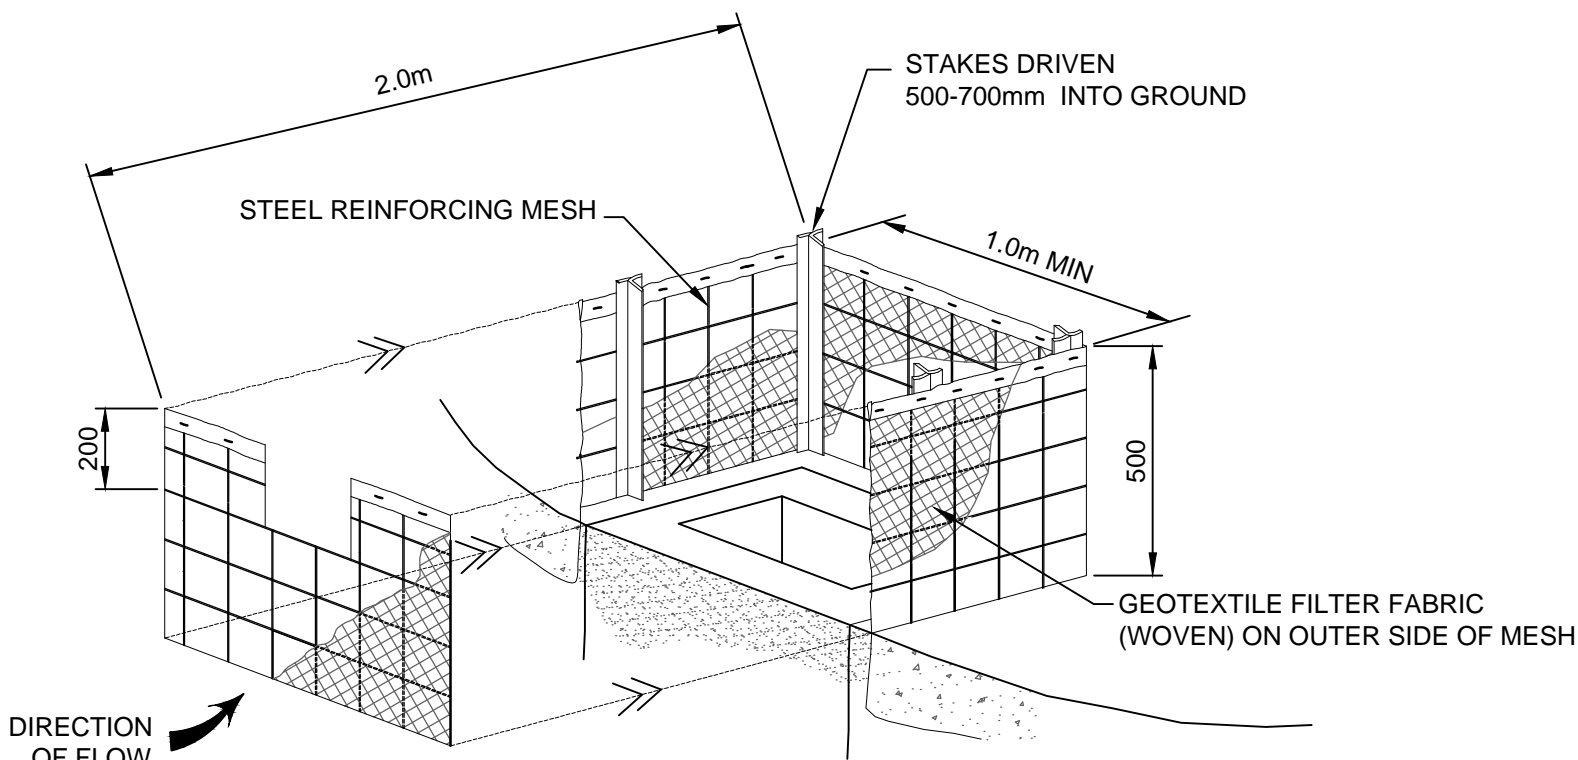


FIELD INLET SEDIMENT TRAP

N.T.S.

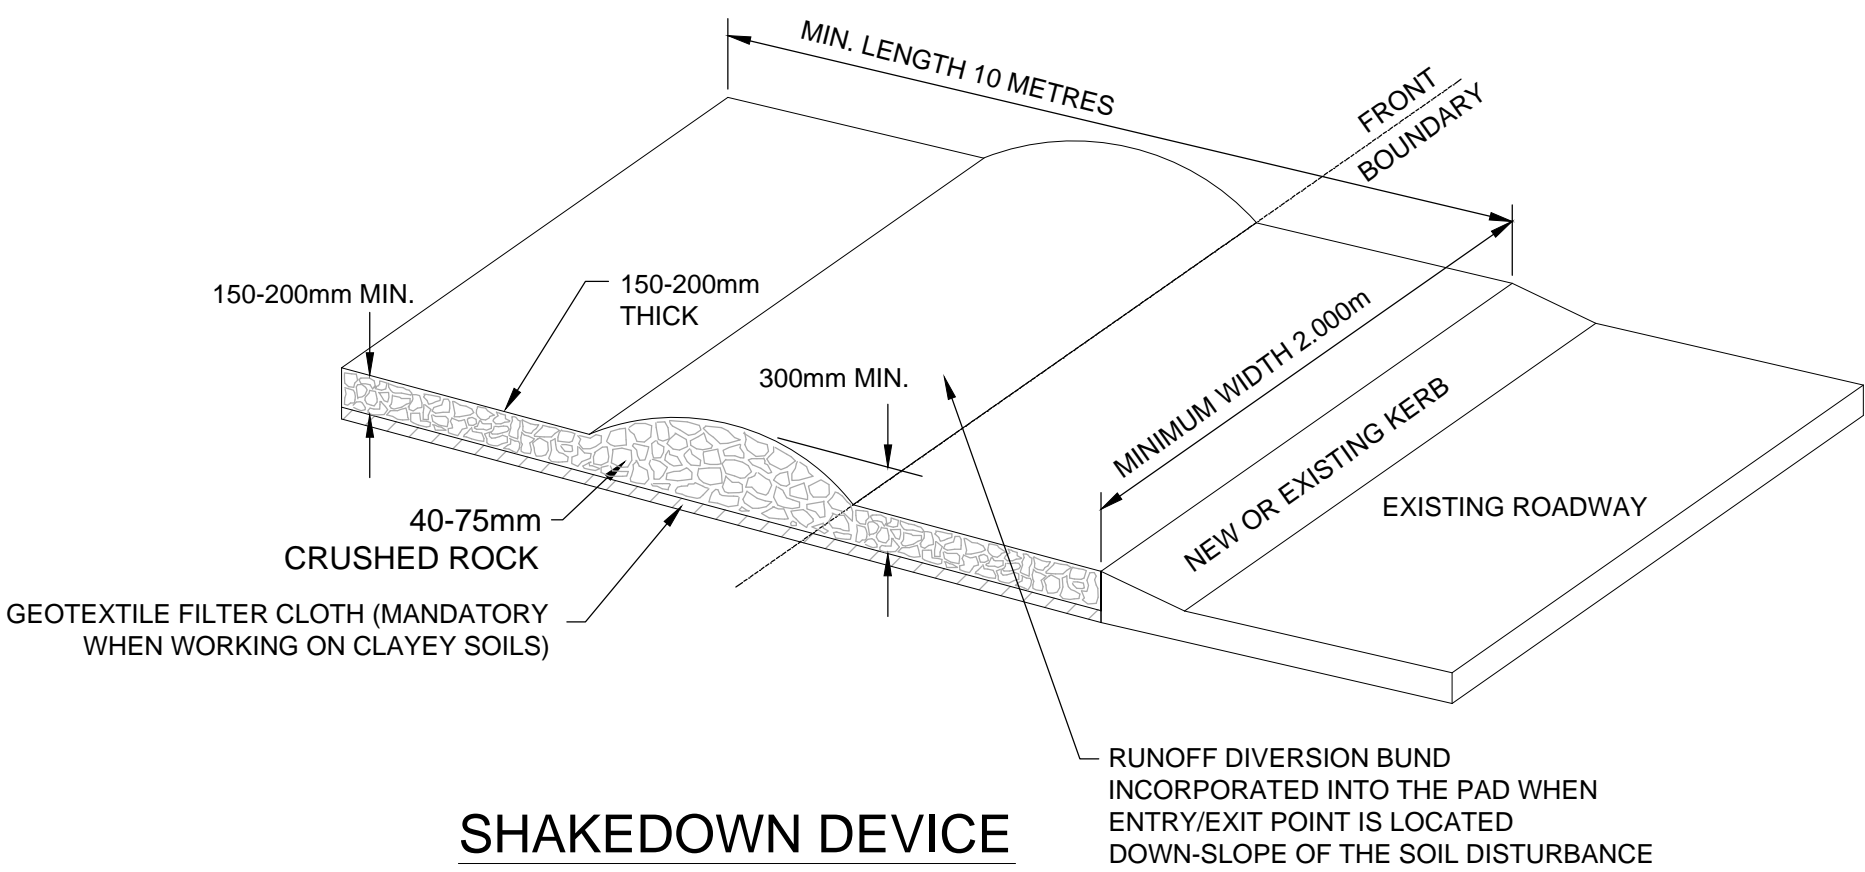


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N.T.S.

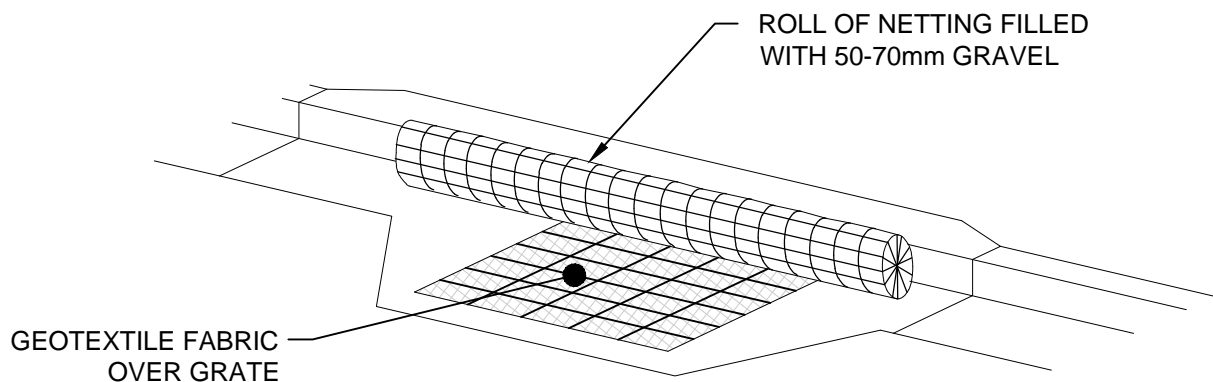


KERB INLET PROTECTION
SAG GULLIES

N.T.S.

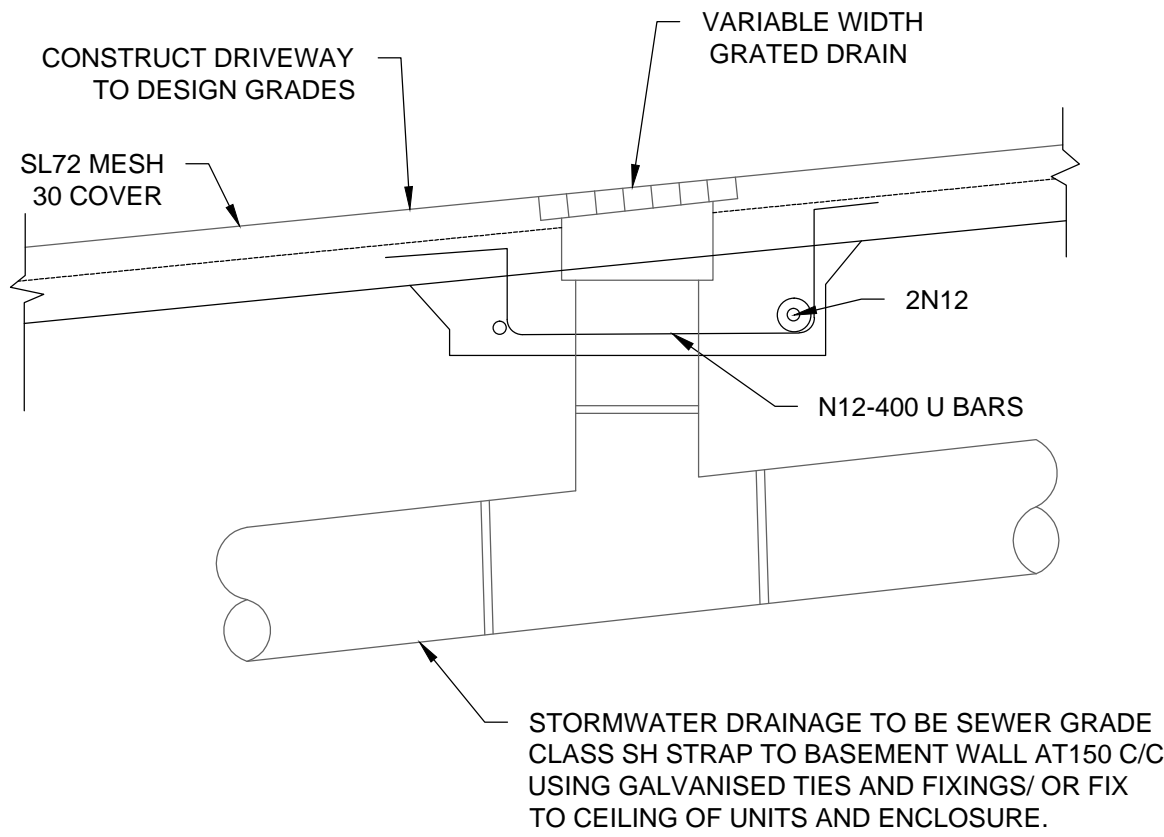


GRADED DRAIN DETAIL

N.T.S.

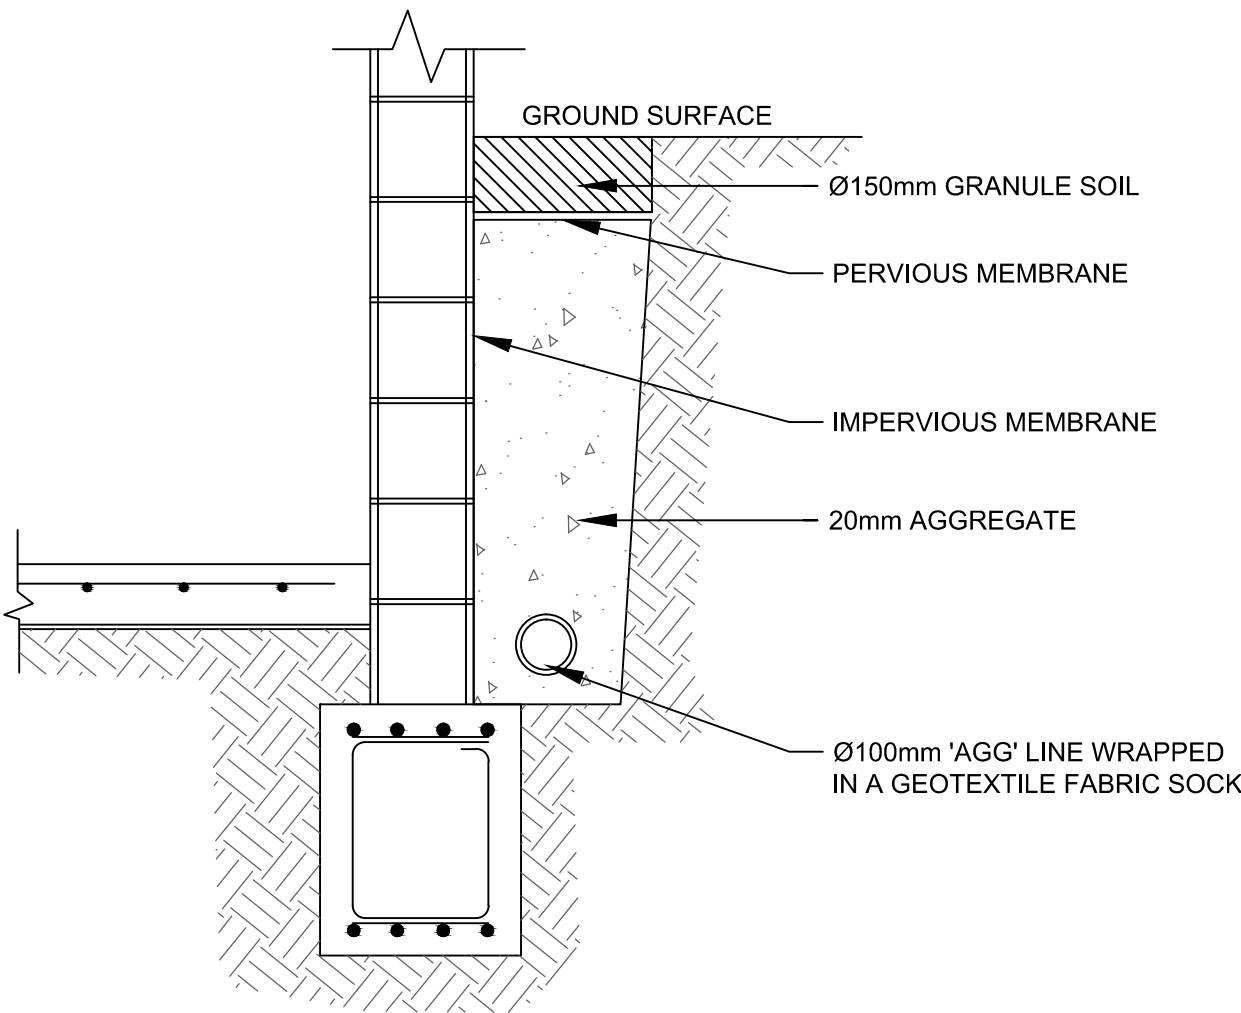


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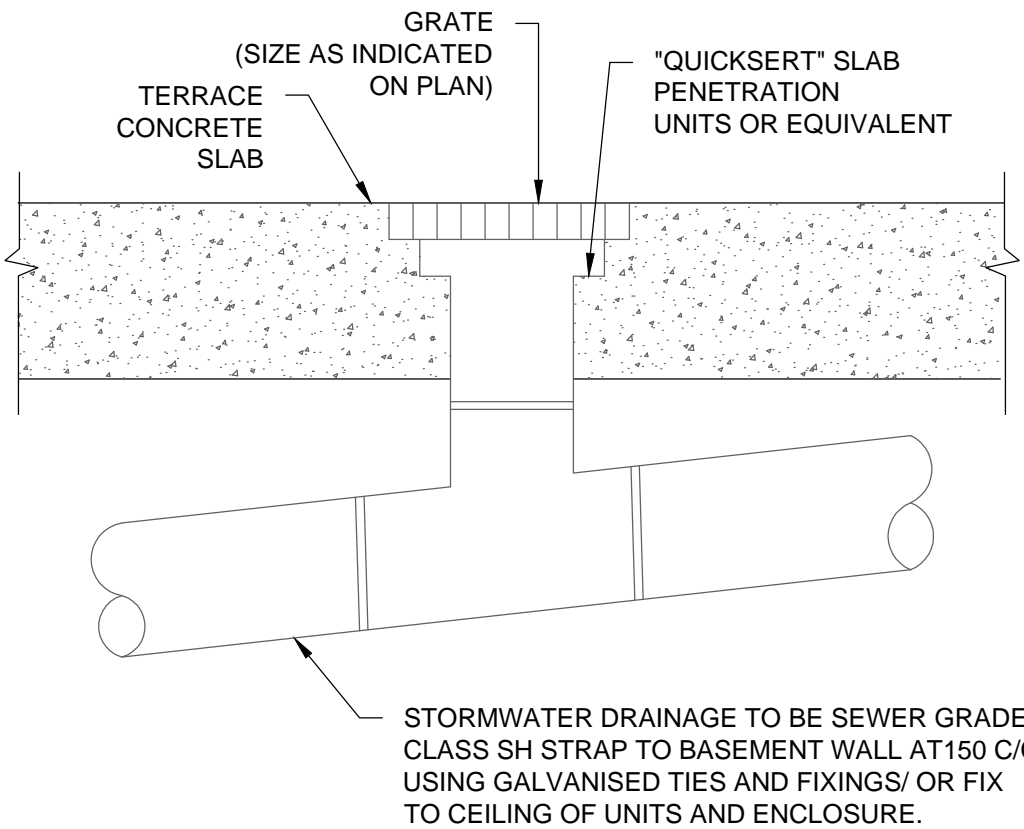
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INLET PIT DETAIL

N.T.S.

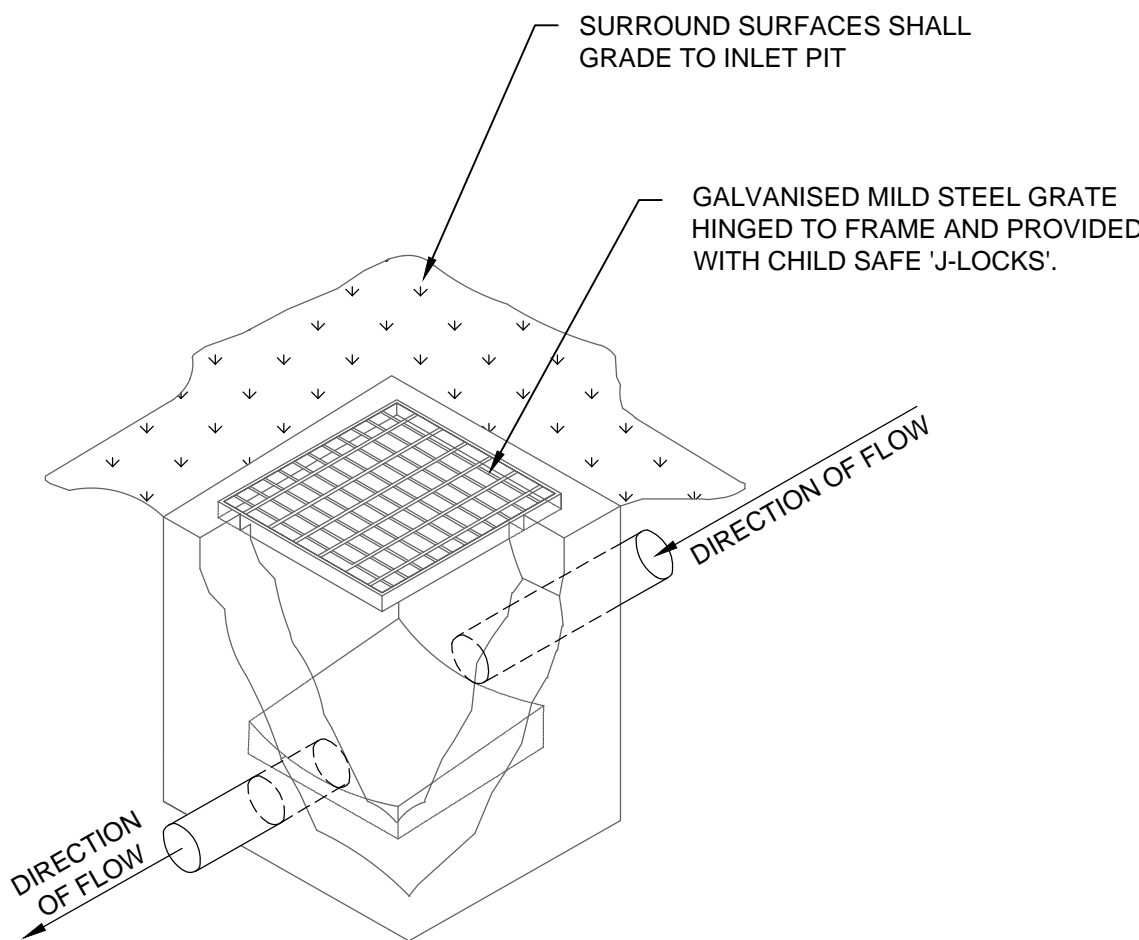


SPOON DRAIN SECTION DETAIL

SCALE 1:10

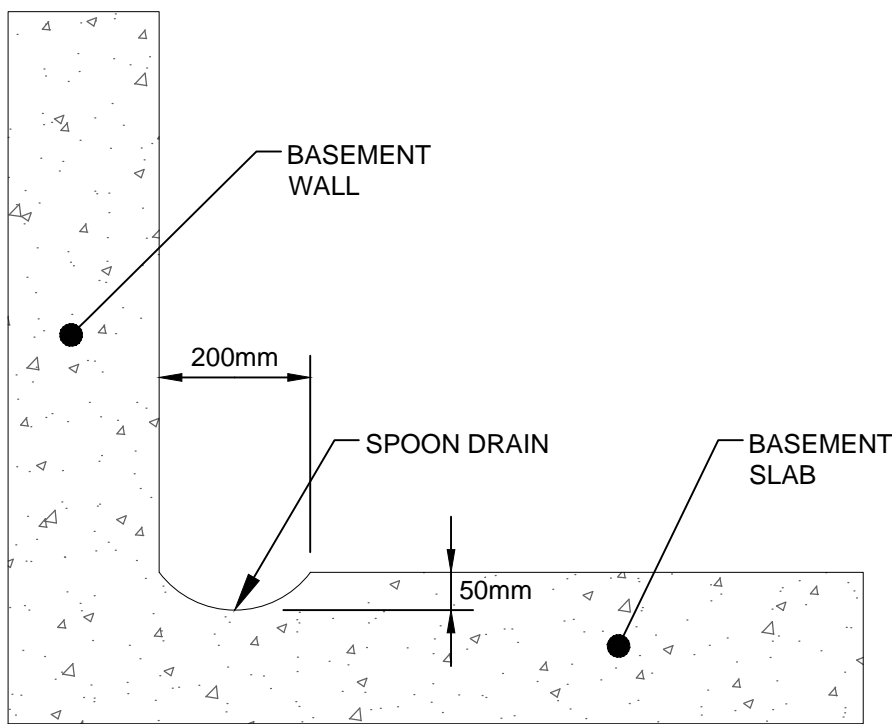


RAINWATER OUTLET DETAIL

N.T.S.

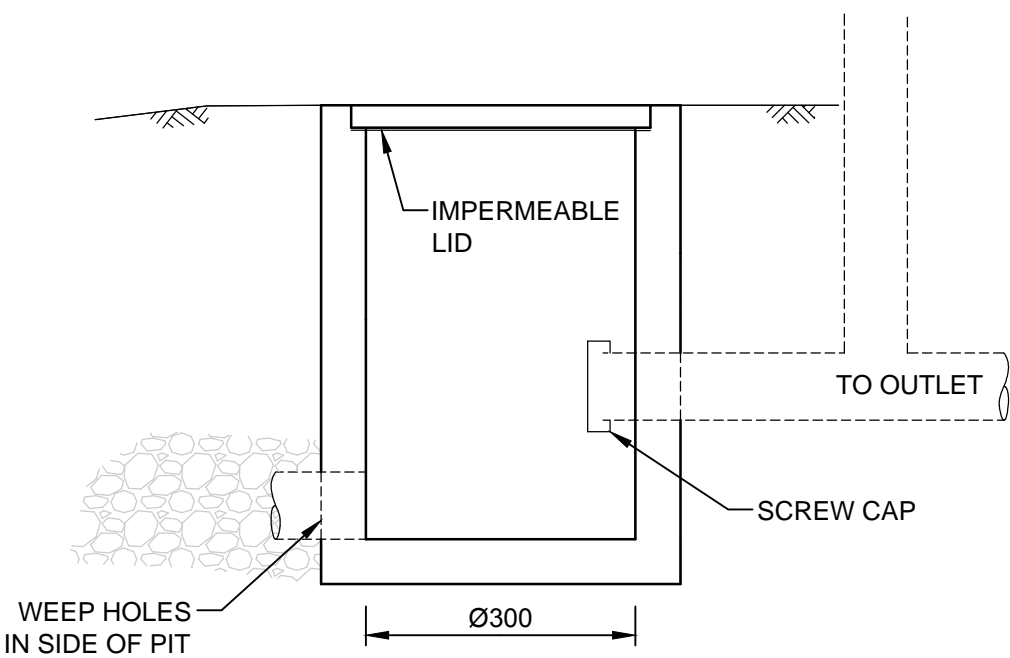


CLEANING EYE DETAIL

N.T.S.

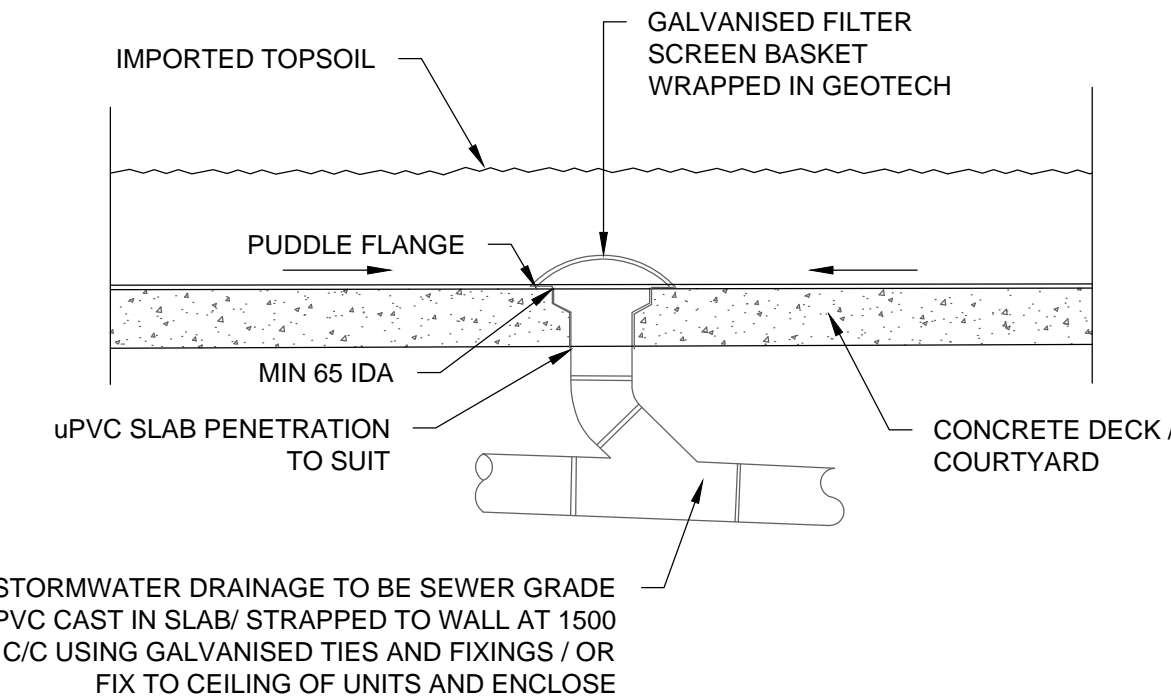

PLANTER GRATE DETAIL

N.T.S.

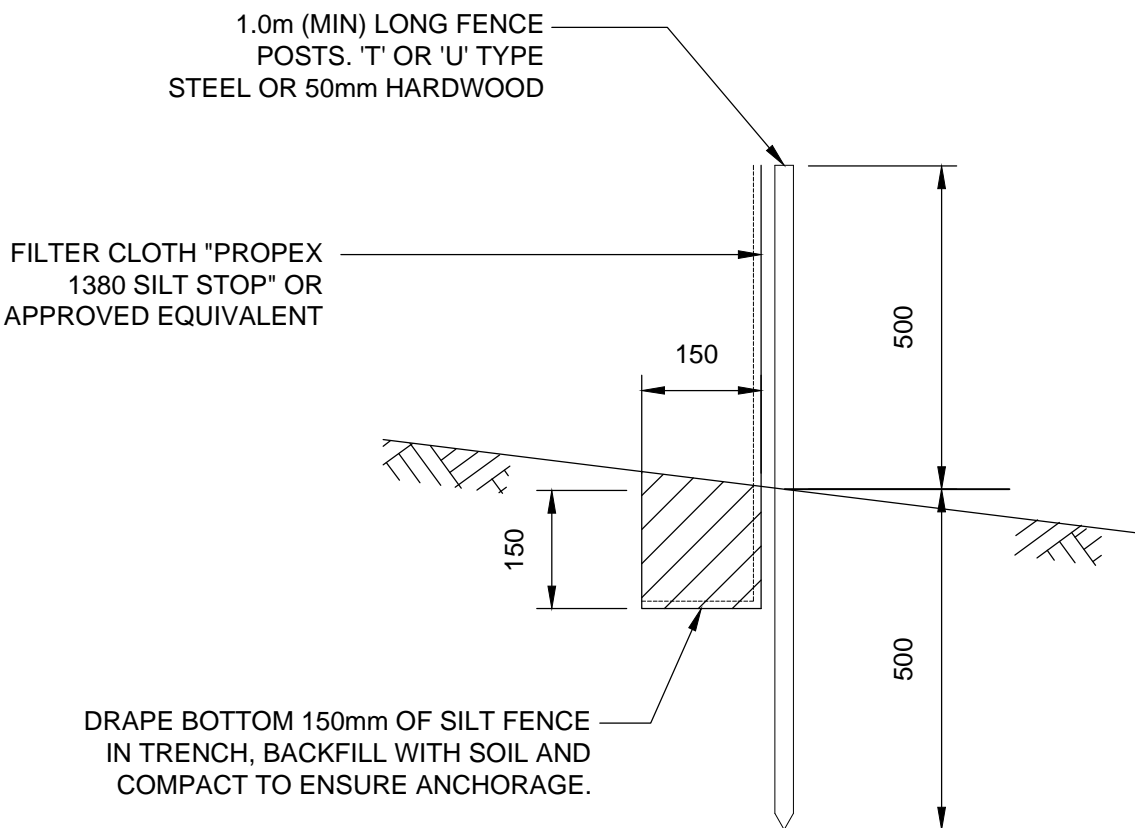

SILT FENCE DETAIL

N.T.S.

SILT FENCE NOTES:

1. FILTER CLOTH TO BE FASTENED SECURELY TO POSTS WITH GALVANISED WIRE TIES, STAPLES OR ATTACHMENT BELTS.
2. POSTS SHOULD NOT BE SPACED MORE THAN 3.0m APART.
3. WHEN TWO SECTIONS OF FILTER CLOTH ADJOIN EACH OTHER THEY SHALL BE OVERLAPPED BY 150mm AND FOLDED.
4. FOR EXTRA STRENGTH TO SILT FENCE, WOVEN WIRE (14mm GAUGE, 150mm MESH SPACING) TO BE FASTENED SECURELY BETWEEN FILTER CLOTH AND POSTS BY WIRE TIES OR STAPLES
5. INSPECTIONS SHALL BE PROVIDED ON A REGULAR BASIS, ESPECIALLY AFTER RAINFALL AND EXCESSIVE SILT DEPOSITS REMOVED WHEN "BULGES" DEVELOP IN SILT FENCE
6. SEDIMENT FENCES SHALL BE CONSTRUCTED WITH SEDIMENT TRAPS AND EMERGENCY SPILLWAYS AT SPACINGS NO GREATER THAN 40m ON FLAT TERRAIN DECREASING TO 20m SPACINGS ON STEEP TERRAIN.

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Issue	Description	Date	Design	Engineer
10m at full size				

Certification By:

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Council
Cumberland
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Scale
0 200 400 600mm
SCALE 1:10 @ A1

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Project
78 - 84 BURSILL STREET, GUILDFORD
PROPOSED RESIDENTIAL UNITS DEVELOPMENT
STORMWATER MANAGEMENT PLAN
CONSTRUCTION CERTIFICATE

Drawing Title MISCELLANEOUS DETAILS SHEET		Dwg. No. 108		Issue C
Scale As Shown	A1	Project No. 171716		

WSUD Treatment Proposal

78-84 Bursill St, Guildford, Australia

1st March 2019

Stormwater360 Australia

WATER SENSITIVE URBAN DESIGN TREATMENT PROPOSAL

WWW.STORMWATER360.COM.AU

This document was created by Stormwater360 Australia and outlines the methodology used to produce the accompanying MUSIC model which specifies the proposed treatment devices.

Job Reference: 05349 - 78-84 Bursill St, Guildford

Prepared For: Osman Chowdhury (Australian Consulting Engineers Pty Ltd)

1st March 2019

Contents

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2.1	Catchment Breakup	7
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3	Proposed WSUD Treatment	9
3.1	Summary of Proposed Systems	9

1. Site Overview & Requirements

1.1 Site Location



Figure 1.1: locality of site for the proposed WSUD treatment

1.2 Design Considerations

The following information has been assumed and adopted based on the information provided:

- Assumed sufficient physical and hydraulic depth for Standard (460) PSorb cartridges to be placed within the OSD tank.
- Pit-baskets are able to pre-treat the run-off from the driveway and some of the landscape.

1.3 Water Quality Objectives

The proposed system has been sized to meet the current NSW Best Management Practice water quality objectives. The water quality objectives require the following removal targets to be met;

- 85% of Total Suspended Solids
- 65% of Total Phosphorus
- 45% of Total Nitrogen
- 90% of Gross Pollutants

1.4 Location Based MUSIC Parameters

The site falls within the Local Government Authority of Cumberland. As a result the following MUSIC Parameters have been selected to adhere to any council and state requirements and recommendations

1.4.1 Rainfall Station

Rainfall Station 67035 Liverpool(Whitlam), 6 Minute Time Step From 1967 To 1976
Modified Specifically For Blacktown City Council

1.4.2 Source Nodes

Rainfall Runoff Parameters

In accordance with the recommendations of 'Sydney Catchment Management Authority (CMA)' the rainfall runoff parameters shown in Table 1.1 have been used.

Pollutant Export Parameters

Table 1.2 shows the pollutant export parameters used for each surface.

Parameter	Surface Type		
	Roof	Road	Ground
Rainfall Threshold (<i>mm</i>)	0.3	1.5	1
Soil Storage Capacity (<i>mm</i>)	120	120	120
Initial Storage (% Capacity)	30	30	30
Field Capacity (<i>mm</i>)	80	80	80
Infiltration Capacity co- efficient a	200	200	200
Infiltration Capacity co- efficient b	1	1	1
Initial depth (<i>mm</i>)	10	10	10
Daily recharge rate (%)	25	25	25
Daily base flow rate (%)	5	5	5
Daily deep seepage rate (%)	0	0	0

Table 1.1: Rainfall Run-off Parameters for ‘Sydney CMA’ Source Nodes

Flow Type	Surface Type	TSS Log ₁₀ Values		TP Log ₁₀ Values		TN Log ₁₀ Values	
		Mean	St. Dev	Mean	St. Dev	Mean	St. Dev
Baseflow	Roof	0.000	0.000	0.000	0.000	0.000	0.000
	Road	1.200	0.170	-0.850	0.190	0.110	0.120
	Ground	1.200	0.170	-0.850	0.190	0.110	0.120
Stormflow	Roof	1.300	0.320	-0.890	0.250	0.300	0.190
	Road	2.430	0.320	-0.300	0.250	0.340	0.190
	Ground	2.150	0.320	-0.600	0.250	0.300	0.190

Table 1.2: Pollutant Export Parameters for ‘Sydney CMA’ Source Nodes

2. Design Methodology

2.1 Catchment Breakup

In order to model a site correctly within the MUSIC software, a catchment breakup is required. The 'catchment breakup' separates catchment areas into groups based on the treatment devices they will drain to. These catchments are further split into sub-catchments based on the pollutant loading concentrations relative to that surface type. Typically *Roof*, *Road*, and *Ground* (Impervious & Pervious) areas are separated based on the pollutants they produce.

Table 2.1 summarises the site area breakup used by Stormwater360 for the design of the proposed treatment devices within MUSIC.

Description	Pollutant Type	Impervious %	Area (m ²)
Roof	Roof	100	1070
Driveway	Road	100	78
Footpath	Ground	100	110
Landscape	Ground	0	403
Paved	Ground	100	238
Paved	Ground	100	6
Landscape to C	Ground	0	28
Landscape	Ground	0	20
Landscape	Ground	0	137
Landscape Bypass	Ground	0	104
Landscape Bypass	Ground	0	124

Table 2.1: MUSIC Model Site Area Breakup

2.2 MUSIC Model Results

Description	Pollutant Removals (%)			
	TSS	TP	TN	GP
Required Targets	85.0	65.0	45.0	90.0
Proposed System	85.0	78.2	55.8	100.0

Table 2.2: MUSIC Model Receiving Node Results

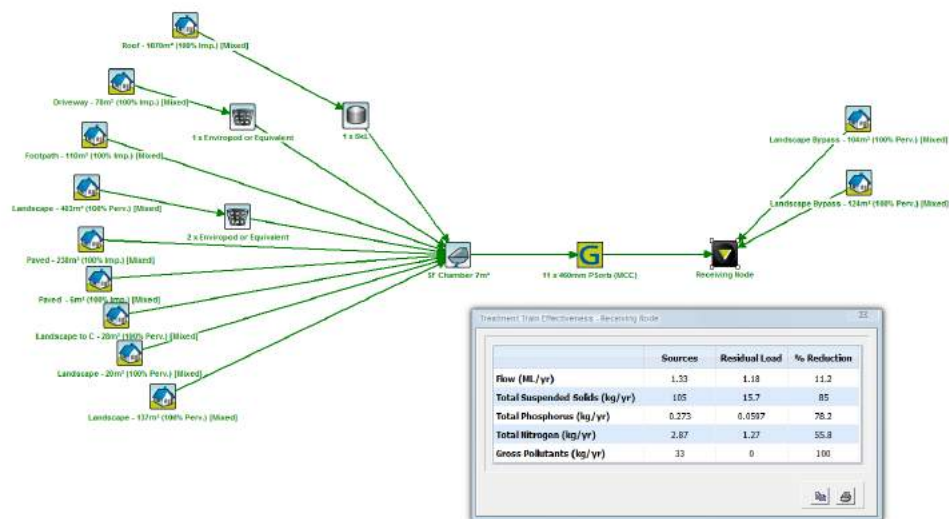


Figure 2.1: Screenshot of MUSIC Model Results

3. Proposed WSUD Treatment

3.1 Summary of Proposed Systems

As per the MUSIC design the following Stormwater360 products are required for the project. These are;

- A 11xStandard(460) PSorb cartridge StormFilter system within a 7m² StormFilter chamber, inside the OSD tank
- 3 EnviroPod Series 200 Filter Baskets or Equivalent by Stormwater360