PROPOSED CHILD CARE FACILITY

22 AUSTRAL AVENUE, WESTMEAD 2145

LOT / PLAN NO. - 2 / DP35155; CUMBERLAND CITY COUNCIL

COMPLIANCE TABLE

	ITEM	PROPOSED	STANDARD	COMPLIANCE
A	SITE AREA	793.45 m²	_	-
В	Setback			
	FRONT	6 m	5 m	YES
	REAR	11.6 m	-	YES
	SIDE	1 m	0.9 m	YES
С	GROSS FLOOR AREA			
	BASEMENT	467 m²	-	
	GROUND FLOOR	245 m²	-	
	FIRST FLOOR	145 m²	-	
	TOTAL GROSS FLOOR AREA	390 m ²	396.725 m²	YES
D	FSR	0.50 : 1	0.5 : 1	YES
Е	HEIGHT	8 m	9.0 m	YES
F	LANDSCAPE AREA	_	-	YES
G	DEEP SOIL	-	-	
Н	CHILDCARE			
	NUMBER OF CHILDREN			
	0-2 YEARS	8 KIDS	-	YES
	2-3 YEARS	15 KIDS	-	YES
	3-5 YEARS	20 KIDS	-	YES
	TOTAL NO.	43 KIDS	-	YES
	NUMBER OF TEACHERS			
	0-2 YEARS	2 TEACHERS	1:4 KIDS	YES
	2-3 YEARS	3 TEACHERS	1:5 KIDS	YES
	3-5 YEARS	2 TEACHERS	1:10 KIDS	YES
	TOTAL NO.	7 TEACHERS	-	YES
	INDOOR PLAY AREA			
	0-2 YEARS	39 m²	3.25 m² / KID	YES
	2-3 YEARS	55 m²	3.25 m² / KID	YES
	3-5 YEARS	67 m²	3.25 m² / KID	YES
	TOTAL AREA	161 m²	3.25 m² / KID	YES
	OUTDOOR PLAY AREA			
	TOTAL AREA	329 m²	7 m² / KID	YES
Н	CAR PARKING			
	STAFF	8 SPACE	-	
	DISABLED	1 SPACE	-	
	VISITORS	8 SPACES	-	
	TOTAL CAR SPACES	16 SPACES	15 SPACES	YES
К	WASTE MANAGEMENT			
	TOTAL BINS	8 BINS	-	YES

REV	DESCRIPTION	DATE	BY
A	DEVELOPMENT APPLICATION	25/06/18	СВ
В	Amendments as per council request	05/02/19	СВ

	Sheet List		
Sheet			
Number	Sheet Name		
00	NOTIFICATION PLAN		
01	COMPLIANCE TABLE		
02	DEMOLITION PLAN		
03	SITE PLAN		
04	SITE ANALYSIS PLAN		
05	BASEMENT PLAN		
06	GROUND FLOOR PLAN		
07	FIRST FLOOR PLAN		
08	ELEVATIONS		



CONSULTANTS

SPECIALITY	COMPANY	NAME	PHONE	EMAIL
HYDRAULICS STORMWATER	AUSTRALIAN CONSULTING ENGINEERS PTY LTD	JOE BACHA	(02) 9763 1500	joeb@aceeng.com .au
TOWN PLANNER	THINK PLANNERS	JONATHAN WOOD	(02) 9890 8543	jonathon@thinkplanners.com.au
LANDSCAPE ARCHITECT	OUTSIDE IN DESIGN GROUP PTY LTD	REBECCA SURIAN	0413 448 447	rebecca@outsideindesign.com.au
ACOUSTIC	RODNEY STEVENS ACOUSTIC PTY LTD	PENNY EDNEY	0419 606 192	penny@rodneystevensacoustics.com.au
TRAFFIC MANAGEMENT	STANBURY TRAFFIC PLANNING	MORGAN STANBURY	0410 561 848	morgan@stanburytraffic.com.au
ACCESS	J SQUARED ENGINEERING PTY LTD	MARK SADGROVE	0401 140 781	mark.sadgrove@jsquared.com.au



18102

	Sheet List		
Sheet	Sheet		
Number	Number Sheet Name		
09	CALLOUT ELEVATIONS & SECTIONS		
10	SHADOW DIAGRAM WINTER SOLSTICE		
11	3D PERSPECTIVE / AXONOMETRIC VIEWS		
12	STREETSCAPE ELEVATION /SCHEDULE OF FINISHES		
13	0-2 INDOOR PLAY AREA CALCULATION PLAN		
14	2-3 & 3-5 INDOOR PLAY AREA CALCULATION PLAN		
15	EVACUATION PLAN		
16	SOLAR STUDY		
17	SECTIONS		

FOR DA APPROVAL

BAINI DESIGN ABN 51 068 732 593 1B Villiers street Parramatta, NSW 2150 Sydney, Australia Phone + 61 2 9188 8250 info@bainidesign.com.au www.bainidesign.com.au

PROPOSED CHILD CARE FACILITY 22 AUSTRAL AVENUE, WESTMEAD 2145 DRAWING TITLE COMPLIANCE TABLE

 PROJECT NUMBER
 DRAWING NUMBER
 DATE
 REVISION

 01
 05/02/19
 B

 SCALE @ A1
 DRAWN BY

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ACOUSTIC NOTES

The following measures are recommended to be incorporated in the design of the proposed centre in order for the child care centre to operate in an acoustically compliant manner.

- Precise type and location of proposed mechanical plant is currently unknown. It is recommended a mechanical plant noise assessment for the proposed air conditioning system(s) and site specific plant equipment should be carried out for the proposed development before the issuing of a Construction Certificate.

The accumulative noise impact of all mechanical plant operating at one time cannot exceed the criteria level of **51 dB(A)** @ the boundary of the proposed development site.

- The mechanical plant should not be used, or left on, after the centre's hours of operation (excluding a window period before and after opening hours) in order to minimise any adverse impacts to nearby sensitive receivers.

- A 1.8m barrier should be constructed around the proposed external play area. The barrier(s) should be of solid continuous construction (ie free of gaps) and of masonry or SlimWall type construction. The location of the proposed wall is shown in green below.

- Windows to be closed to control noise emissions from the centre to nearby sensitive receivers when centre is at capacity.

- The following rules should be incorporated into the centre's management plan in order to achieve acoustic compliance:


- A contact phone number for the centre's director should be made available to parents and neighbours.

- Crying children should be taken inside the centre and comforted.

- The behaviour of children should be monitored and modified as required by adequately trained child care workers.

- Parents and guardians should be informed of the importance of noise minimisation when entering the site, dropping off or picking up children.

1.8m barrier

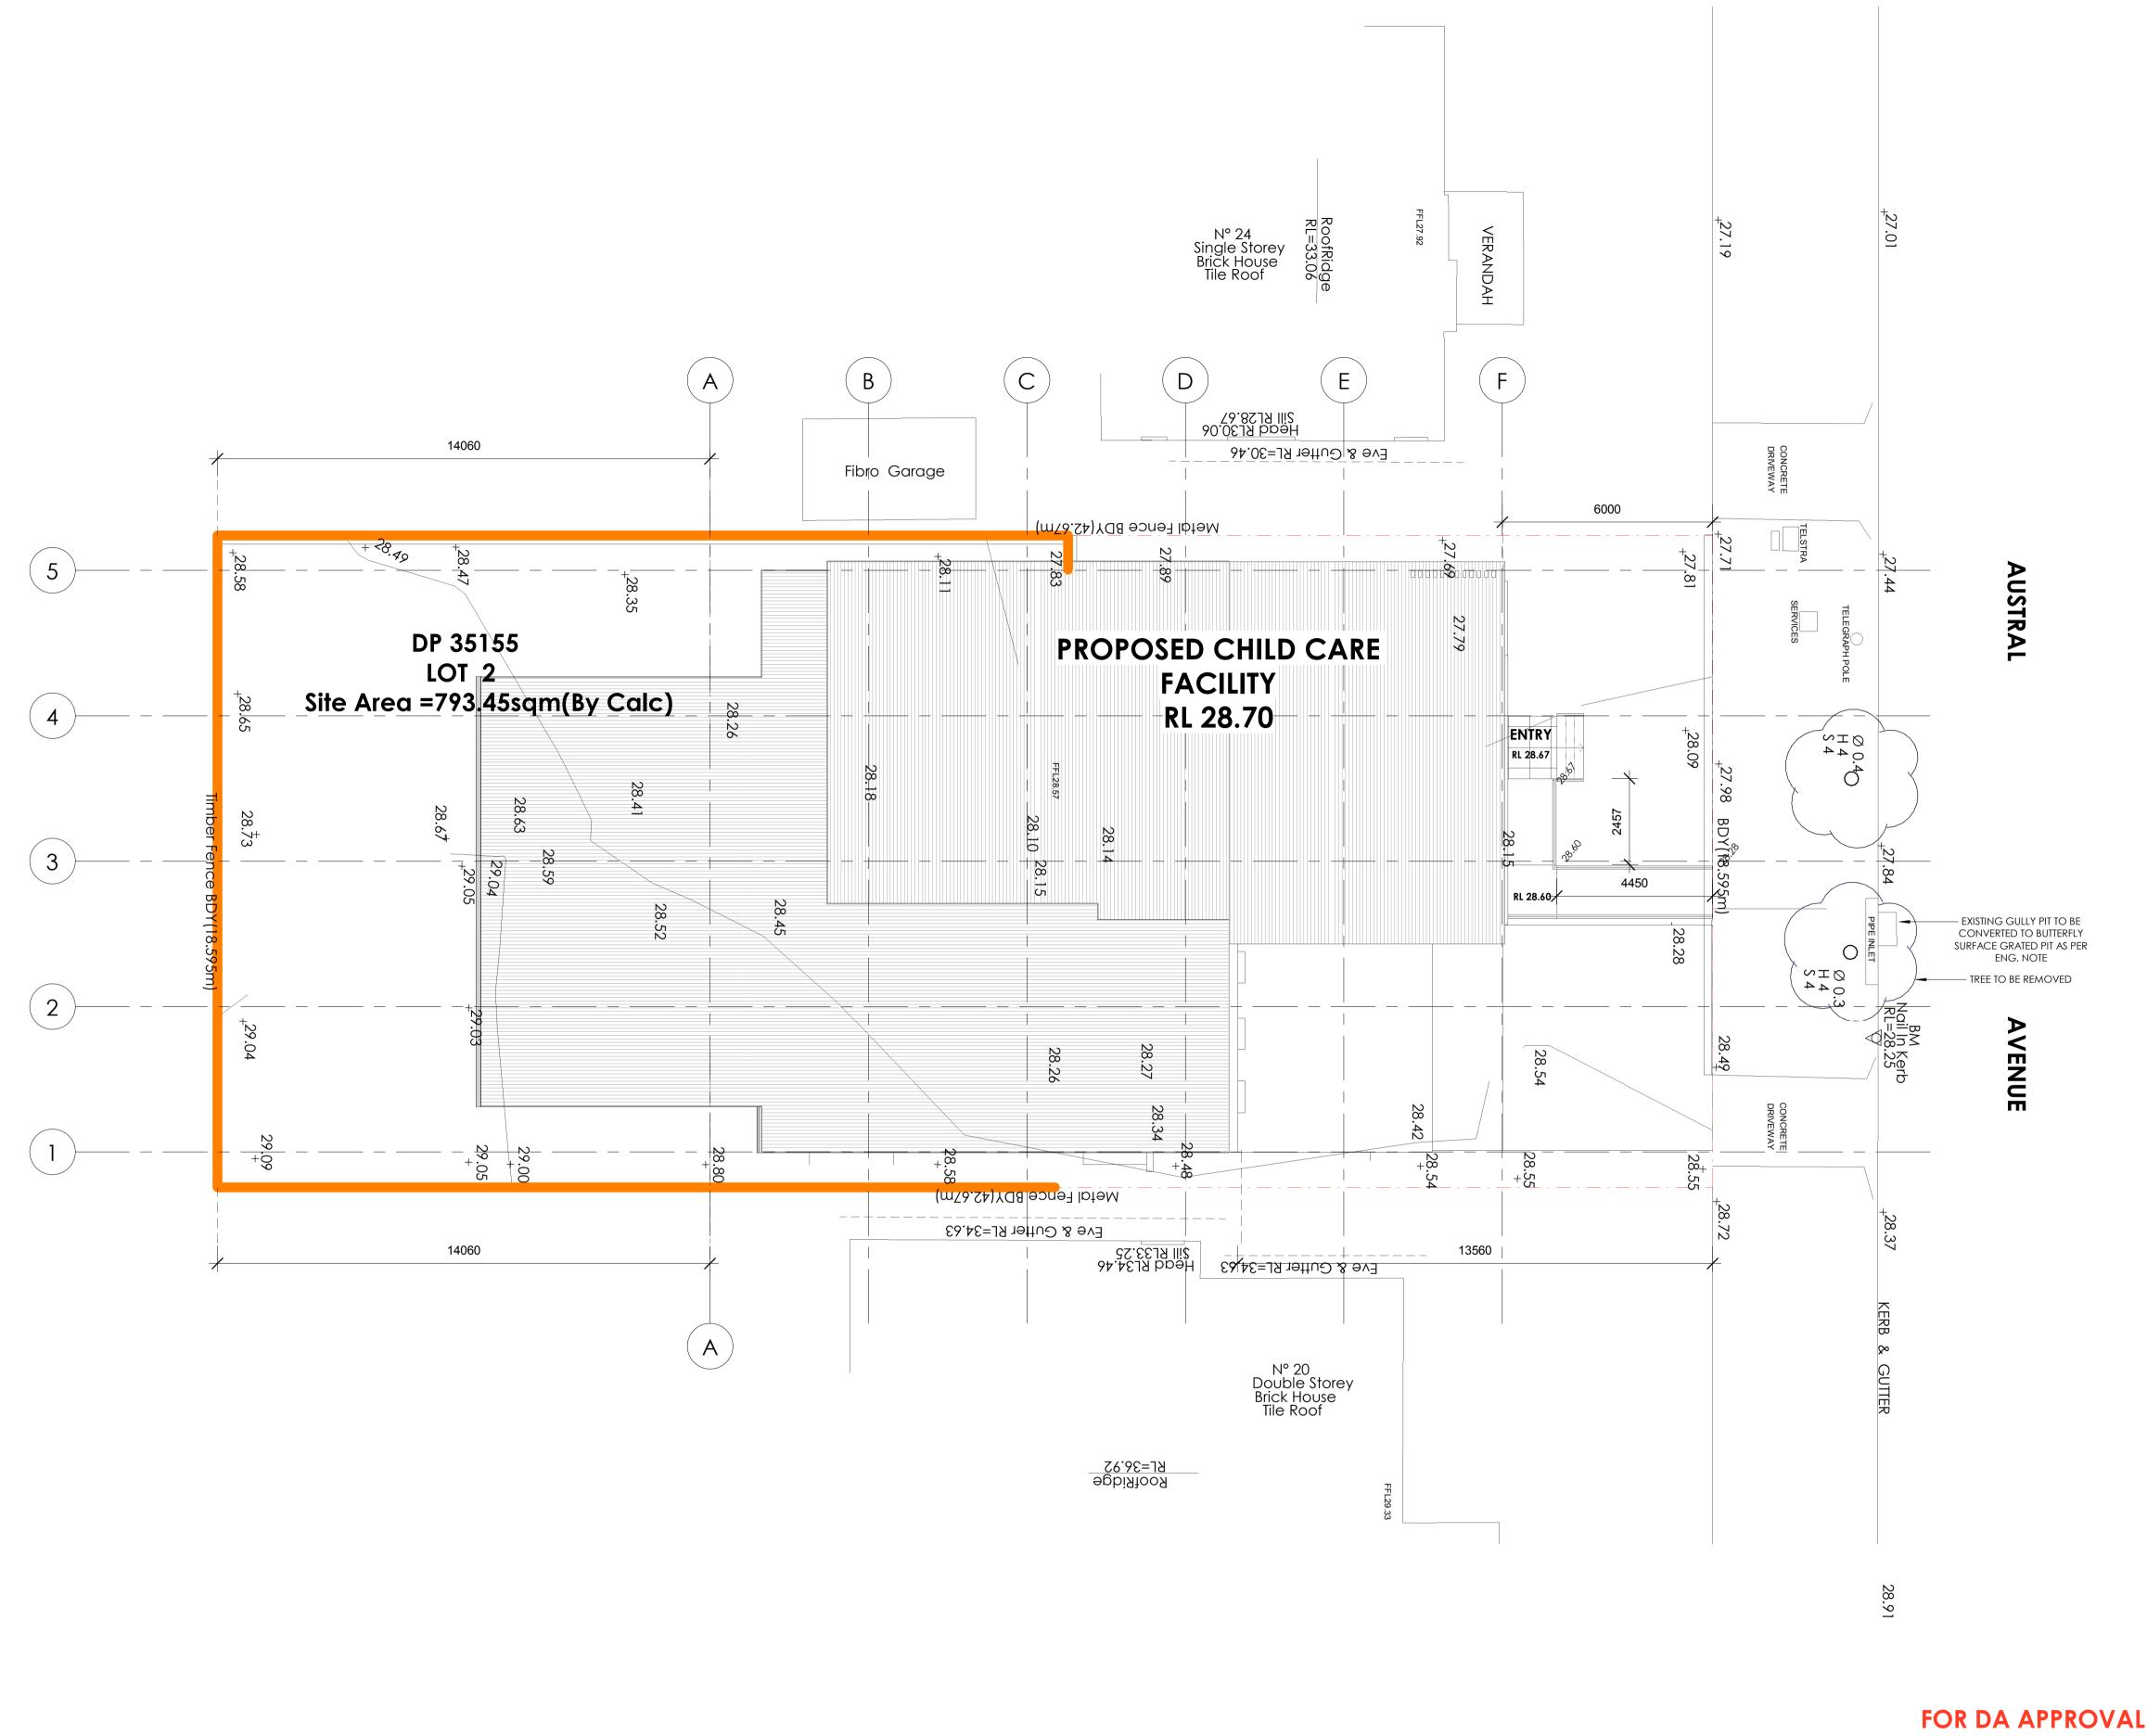




REV	DESCRIPTION	DATE	ΒY
А	DEVELOPMENT APPLICATION	25/06/18	СВ
В	AMENDMENTS AS PER COUNCIL REQUEST	05/02/19	СВ



PROJECT TITLE **baini**desigr PROPOSED CHILD CARE FACILITY 22 AUSTRAL AVENUE, WESTMEAD 2145 **BAINI DESIGN** Abn 51 068 732 593 DRAWING TITLE SITE PLAN 1B Villiers street Parramatta, NSW 2150 PROJECT NUMBER DRAWING NUMBER DATE REVISION Sydney, Australia 05/02/19 В 03 Phone + 61 2 9188 8250 18102 info@bainidesign.com.au SCALE @ A1 DRAWN BY CHECKED BY www.bainidesign.com.au 1:100

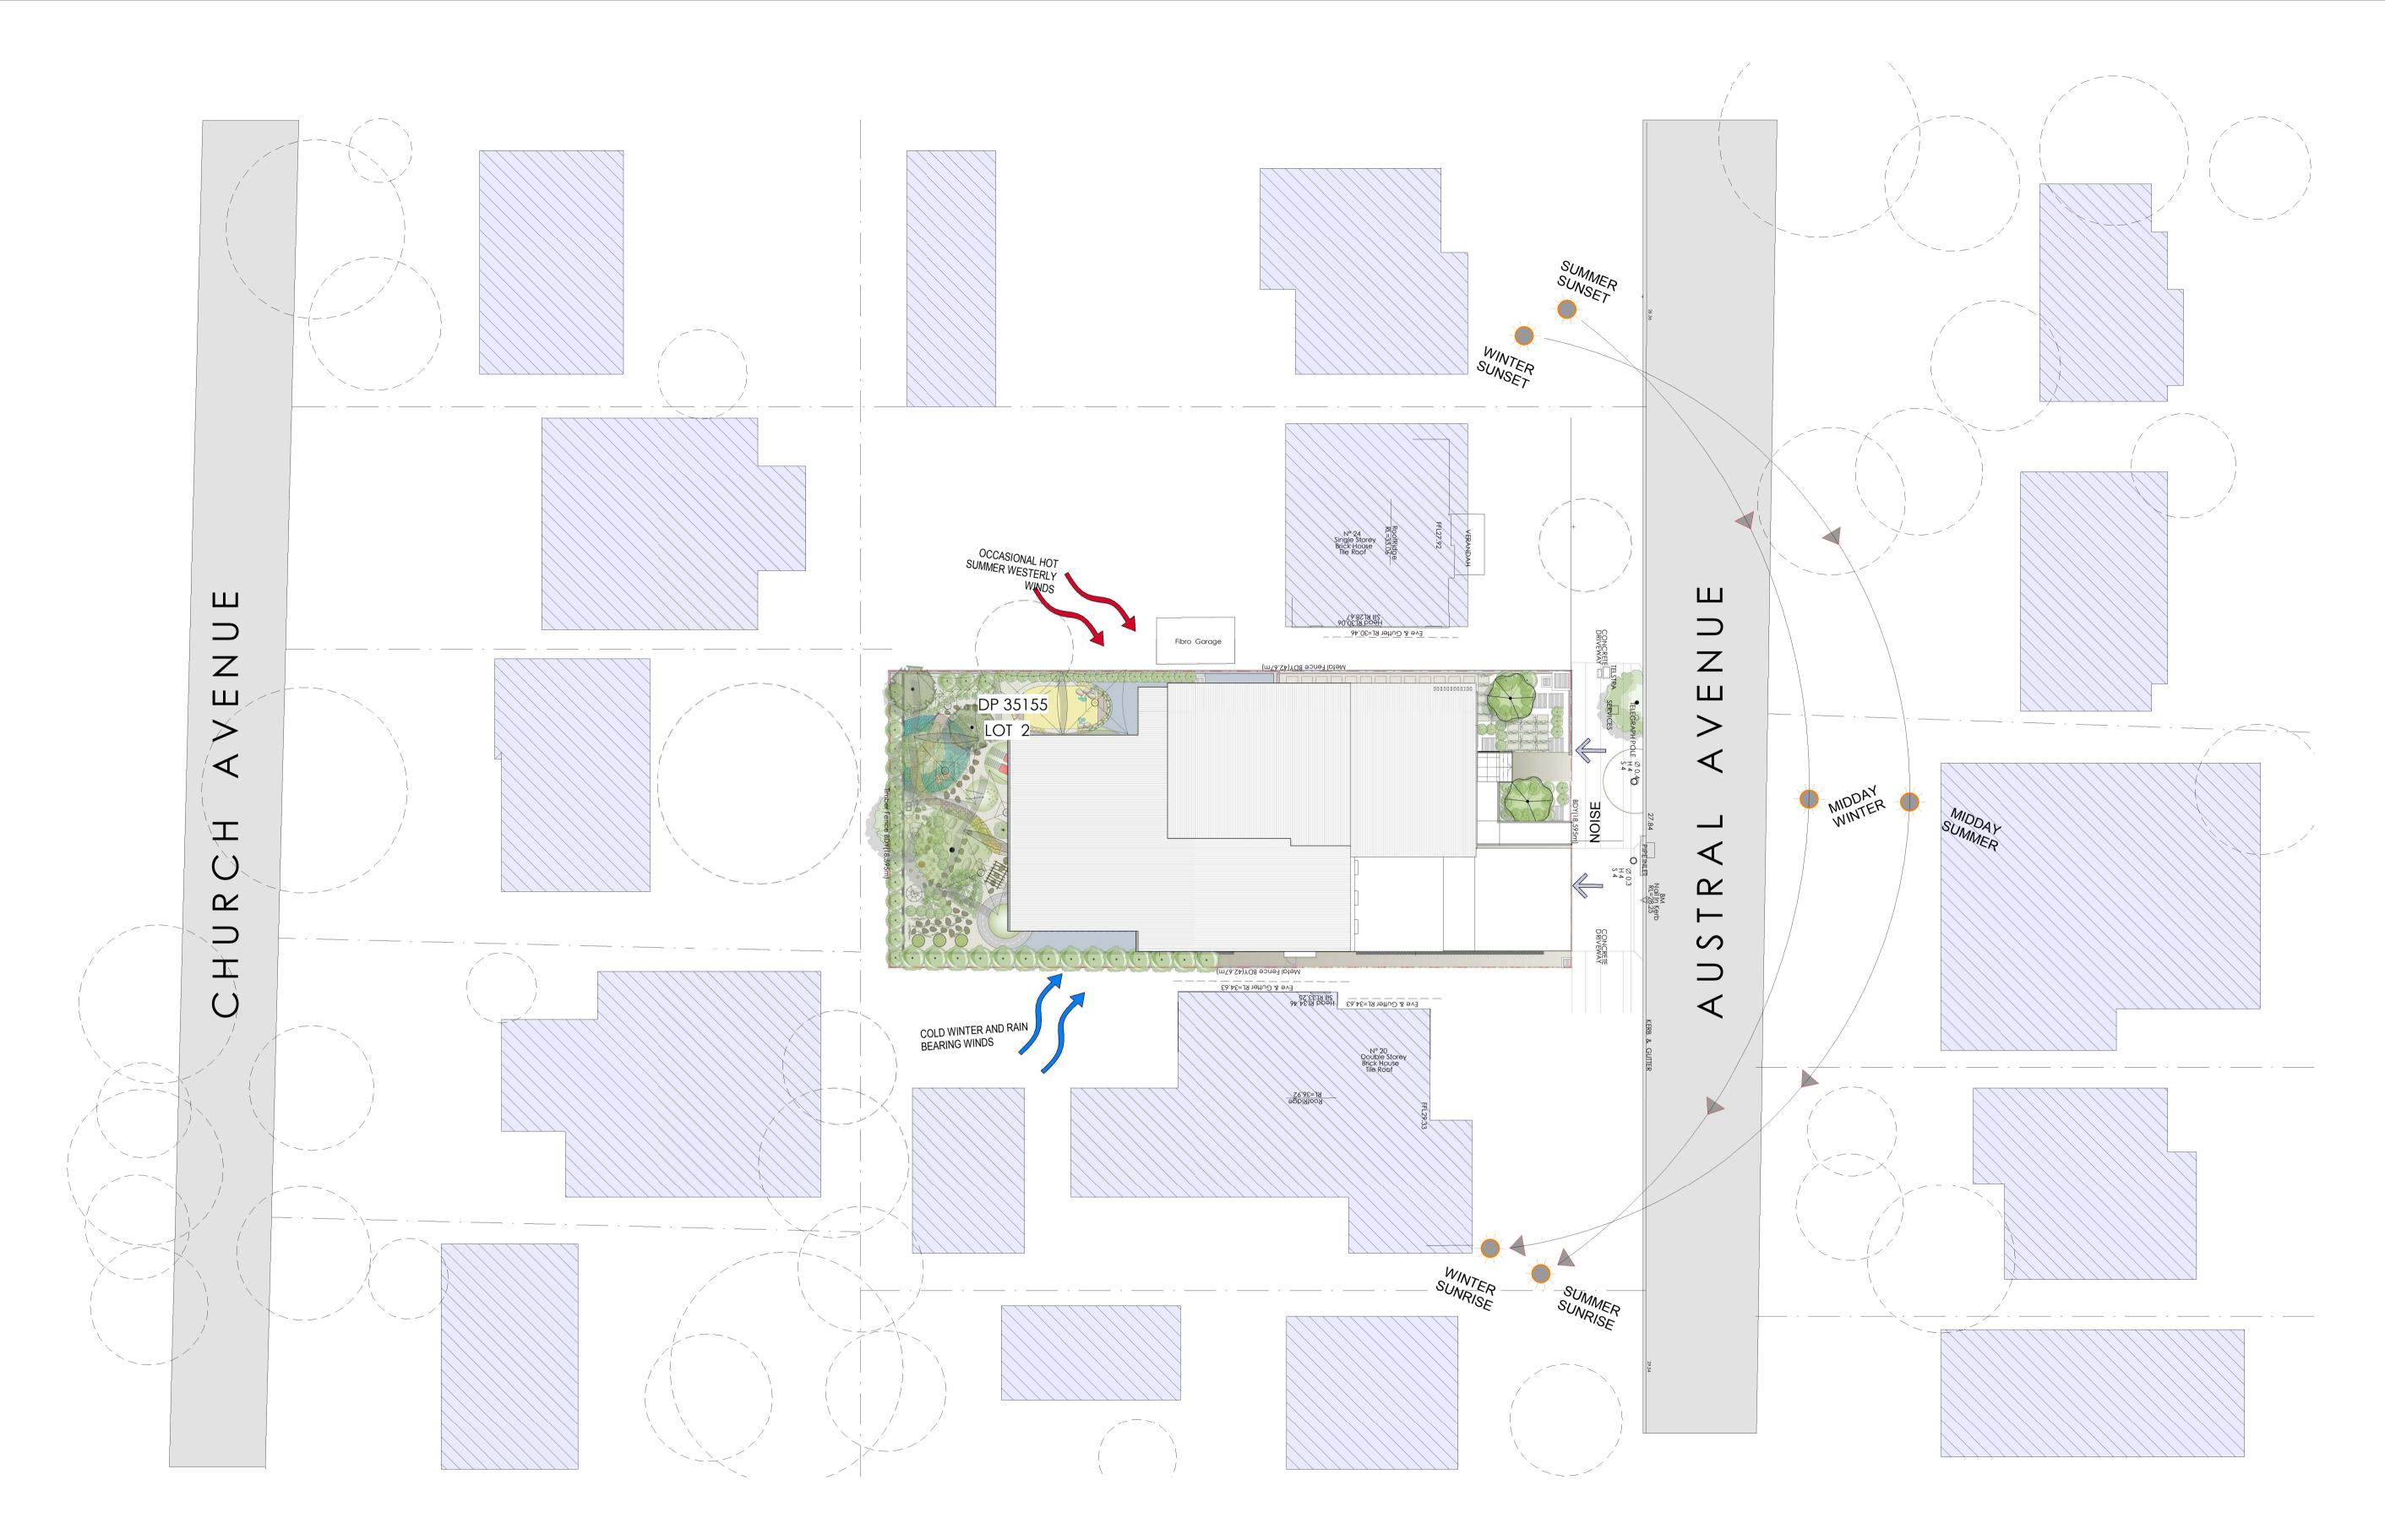



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 05/02/19
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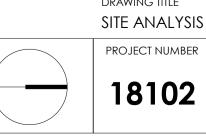
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 PROPOSED CHILD CARE FACILITY

 22 AUSTRAL AVENUE, WESTMEAD 2145


 DRAWING TITLE

 SITE ANALYSIS PLAN

 PROJECT NUMBER
 DRAWING NUMBER

_			
	DRAWING NUMBER	DATE	REVISION
	04	05/02/19	В
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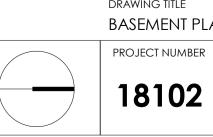
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В	AMENDMENTS AS PER COUNCIL REQUEST	05/02/19	СВ

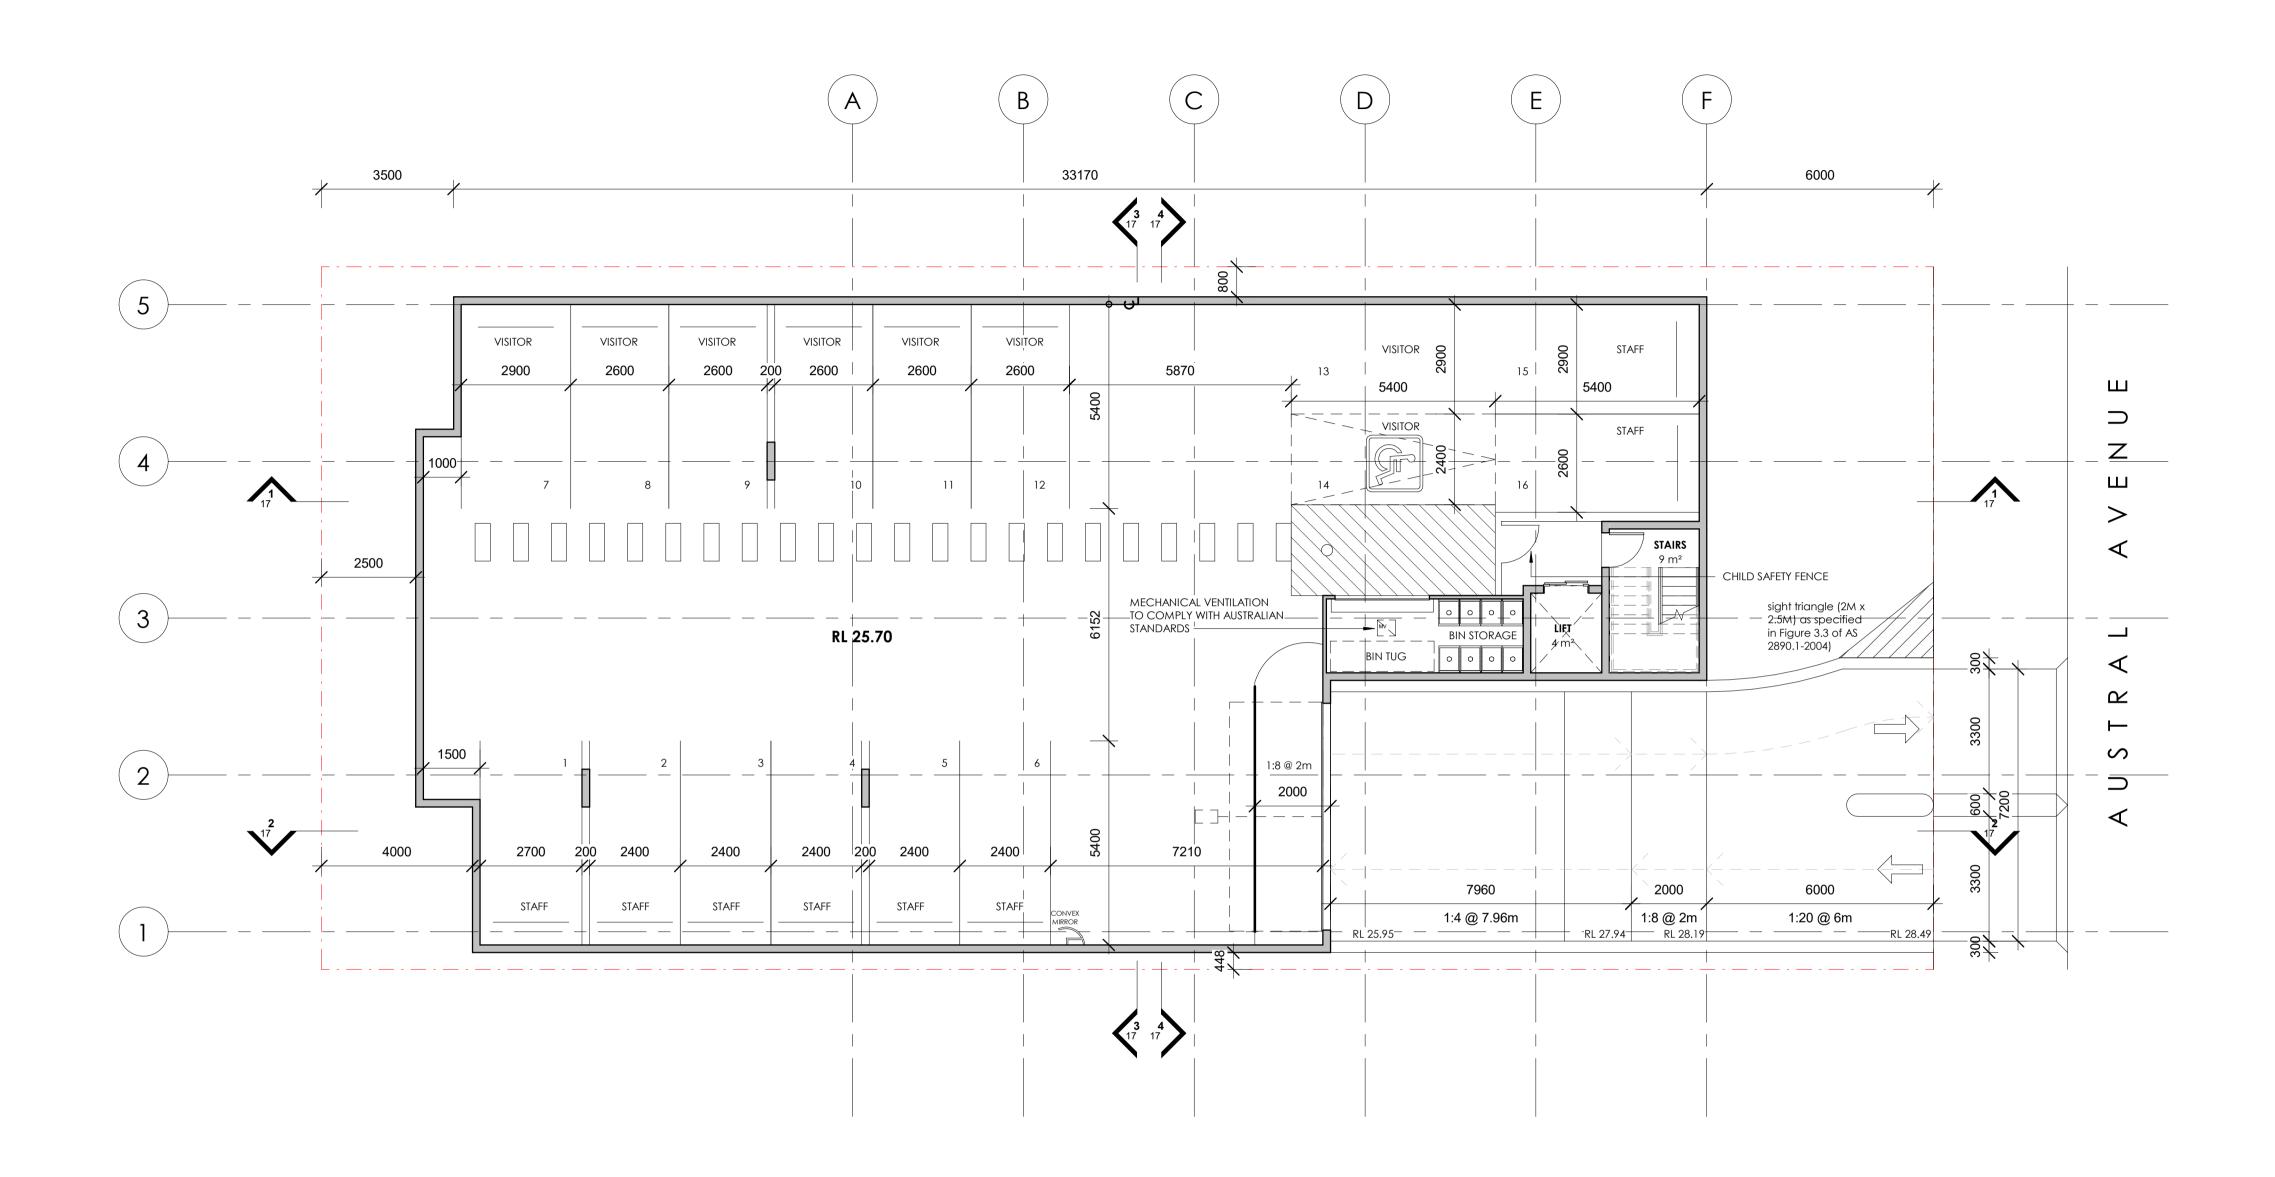

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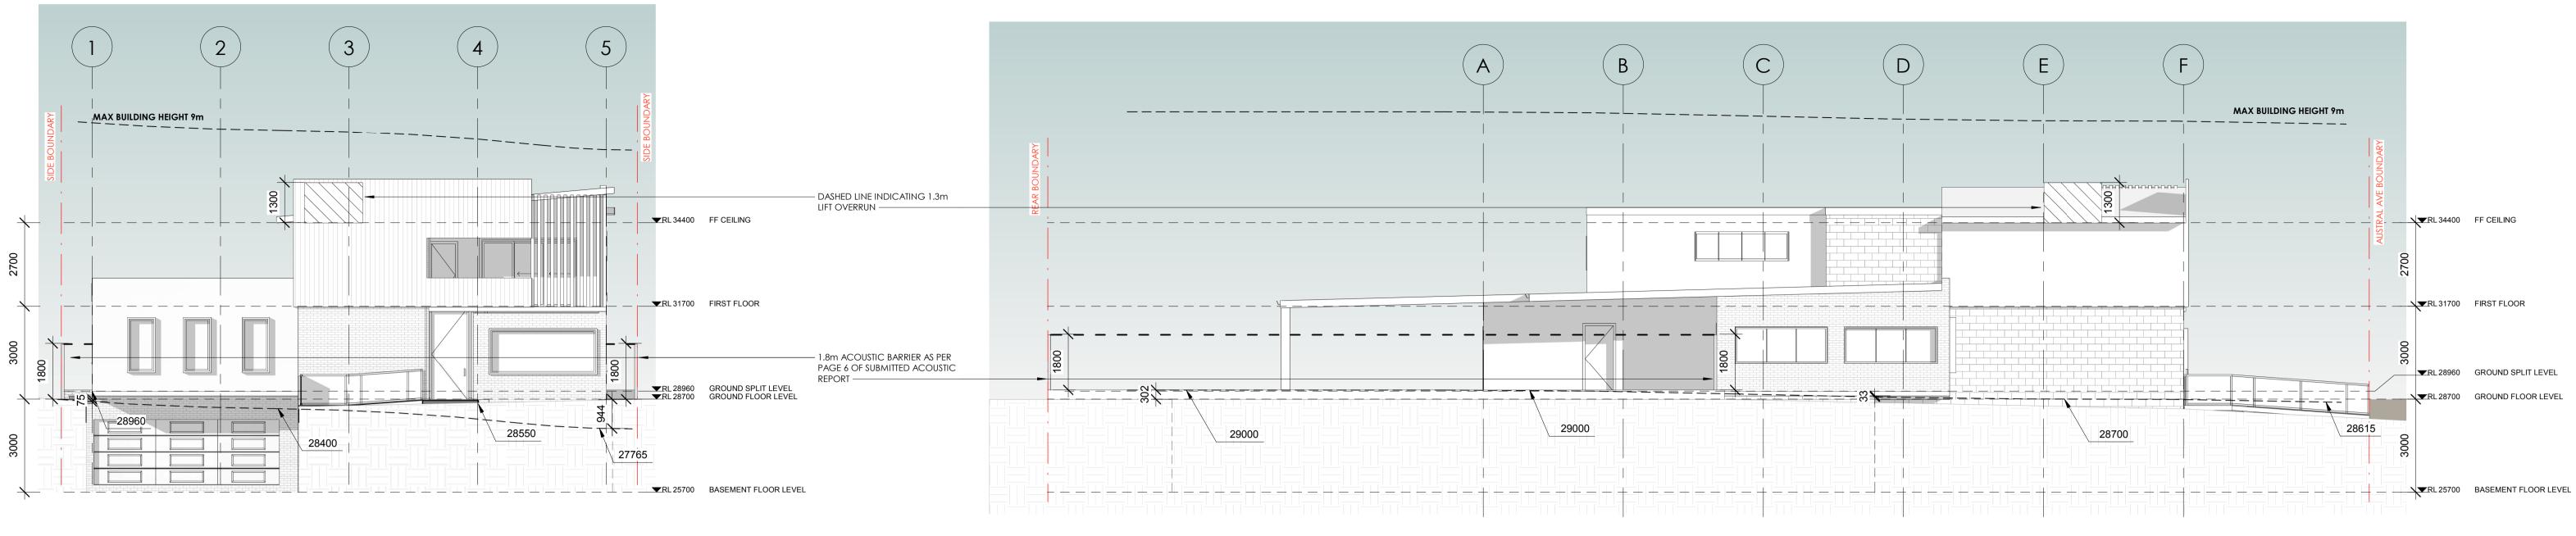


PROPOSED CHILD CARE FACILITY 22 AUSTRAL AVENUE, WESTMEAD 2145 DRAWING TITLE


BASEMENT PLAN

PROJECT NUMBER DRAWING NUMBER DATE REVISION 05/02/19 В 05 DRAWN BY CHECKED BY SCALE @ A1 1:100

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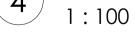




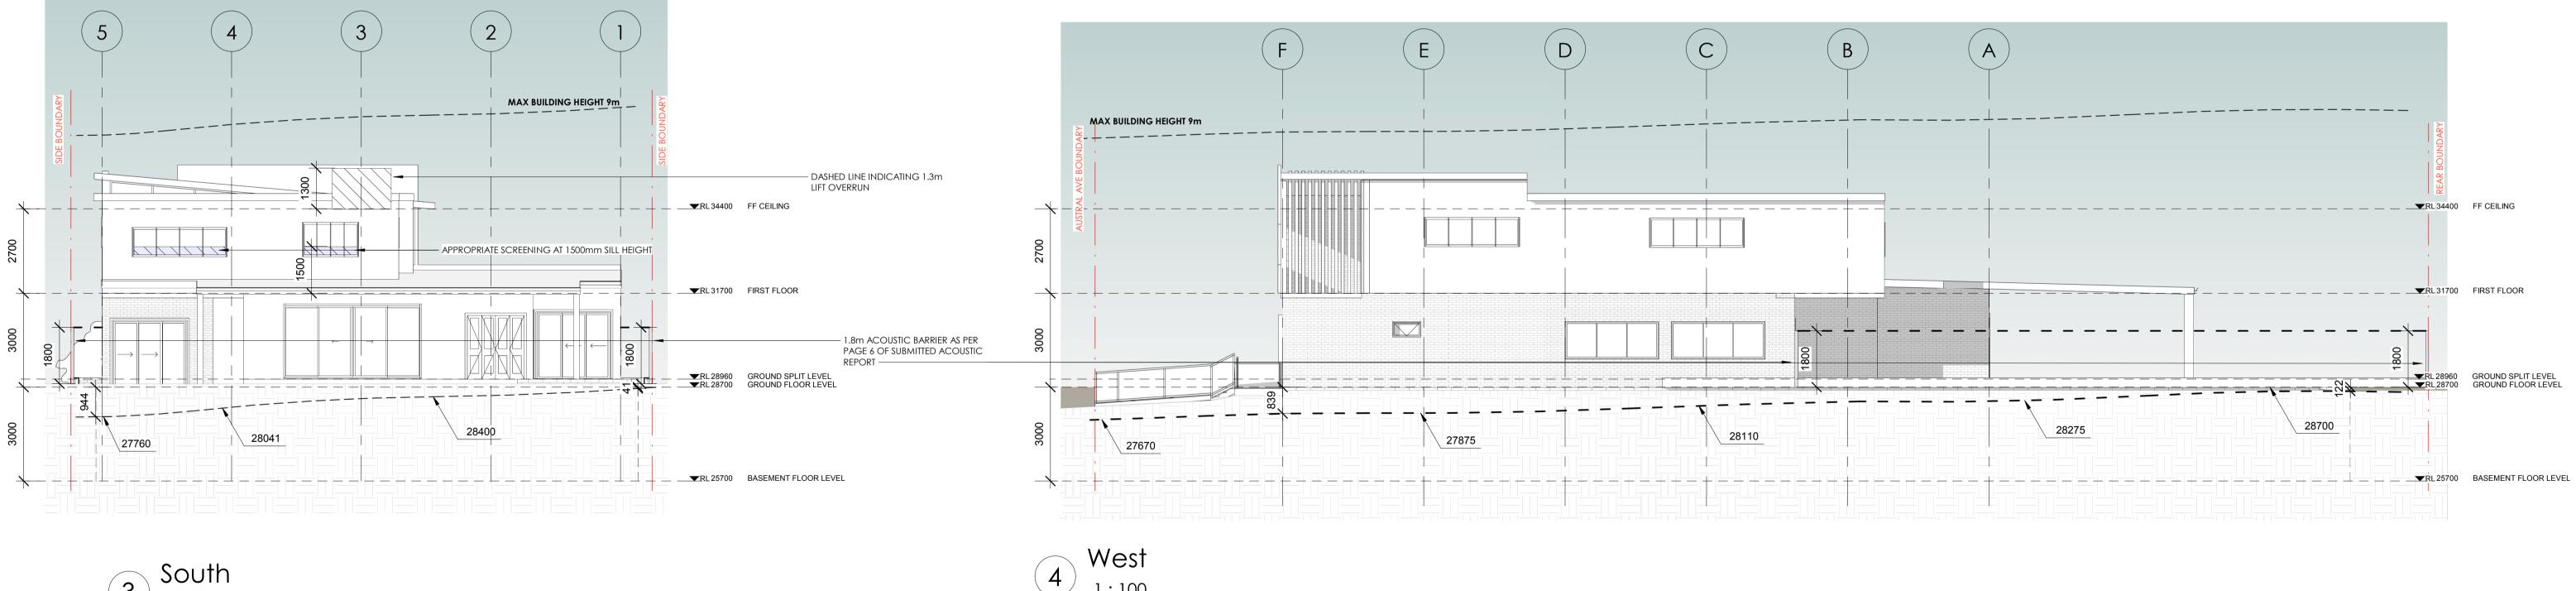

REV	DESCRIPTION	DATE	ΒY
Α	DEVELOPMENT APPLICATION	25/06/18	СВ
В	AMENDMENTS AS PER COUNCIL REQUEST	05/02/19	СВ


East 1:100 2.






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bainidesign PROJECT TITLE PROPOSED CHILD CARE FACILITY 22 AUSTRAL AVENUE, WESTMEAD 2145 **BAINI DESIGN** ABN 51 068 732 593 1B Villiers street DRAWING TITLE ELEVATIONS Parramatta, NSW 2150 Sydney, Australia PROJECT NUMBER DRAWING NUMBER REVISION DATE 05/02/19 В 08 Phone + 61 2 9188 8250 18102 info@bainidesign.com.au DRAWN BY CHECKED BY SCALE @ A1 www.bainidesign.com.au 1:100



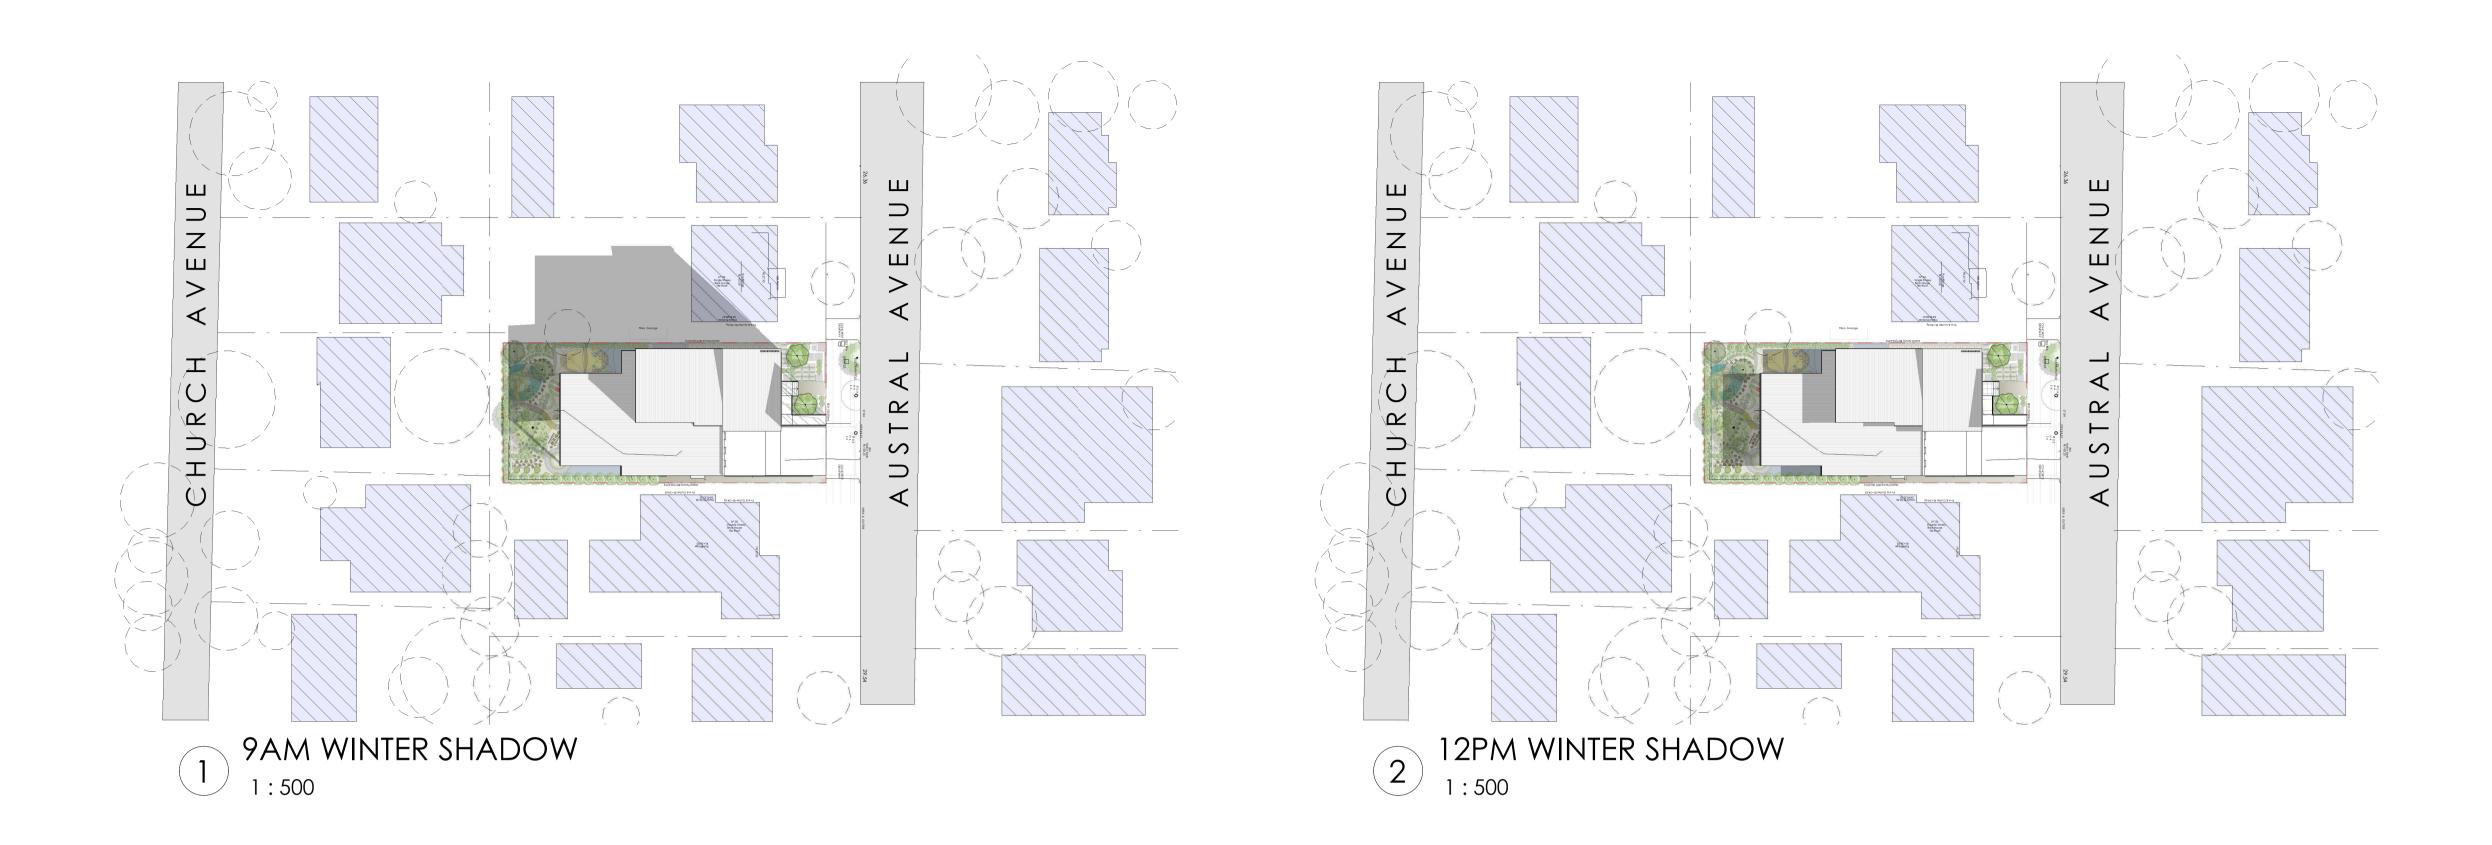

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A	DEVELOPMENT APPLICATION	25/06/18	СВ
В	Amendments as per council request	05/02/19	СВ



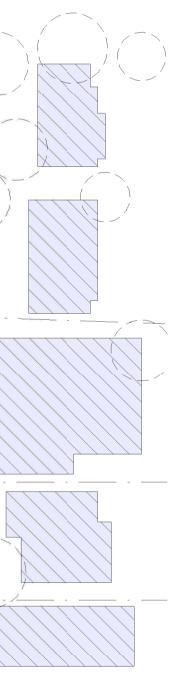


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PROJECT TITLE PROPOSED CHILD CARE FACILITY 22 AUSTRAL AVENUE, WESTMEAD 2145

Shadow diagram winter solstice


SHADOW DIAGRAM WINTER SOLSTICE					
PROJECT NUMBER	DRAWING NUMBER	DATE	REVISION		
		05/02/19	В		
18102	SCALE @ A1	DRAWN BY	CHECKED BY		
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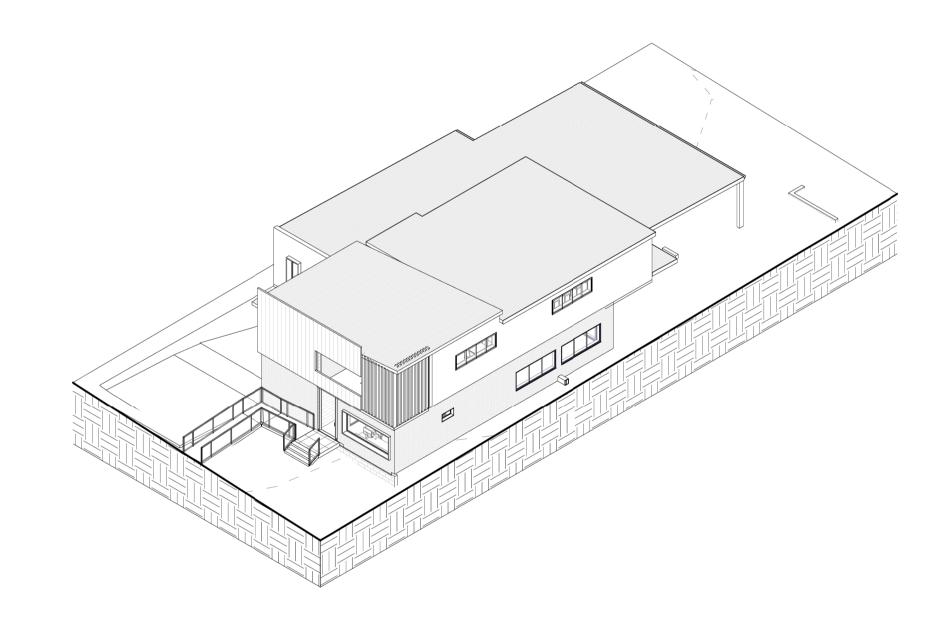




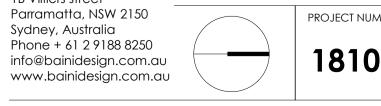

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Α	DEVELOPMENT APPLICATION	25/06/18	СВ
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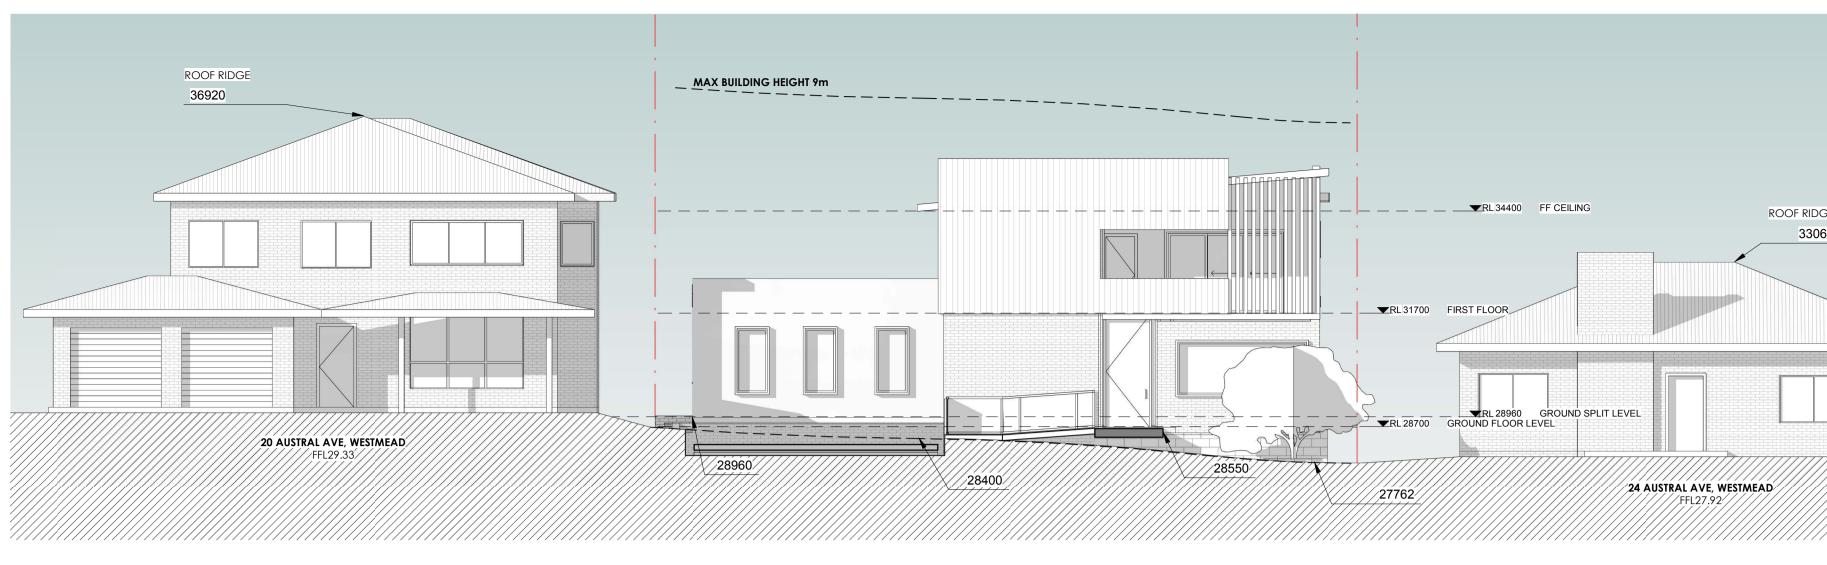
PROPOSED CHILD CARE FACILITY 22 AUSTRAL AVENUE, WESTMEAD 2145 DRAWING TITLE

3D PERSPECTIVE / AXONOMETRIC VIEWS

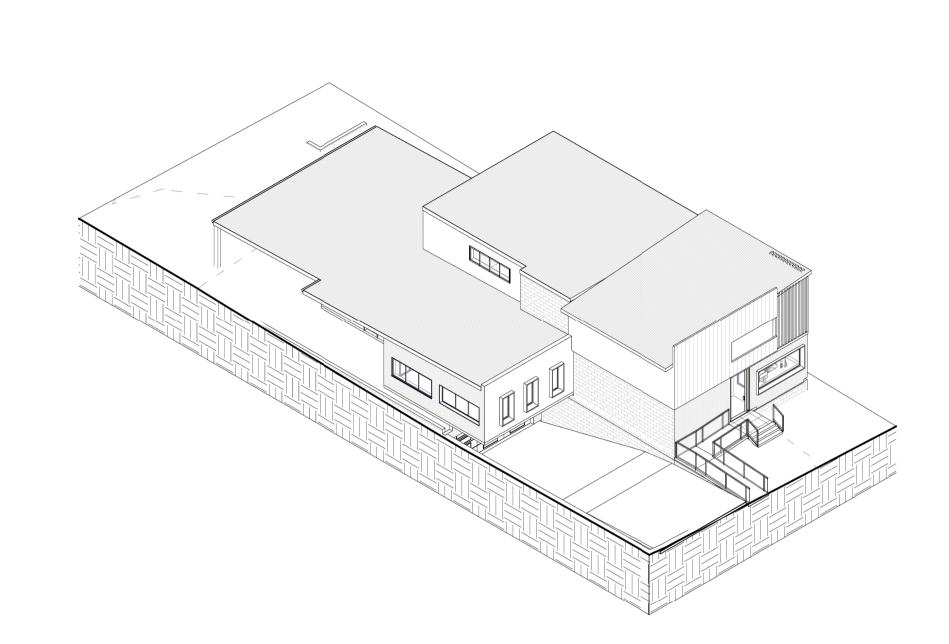
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REV	DESCRIPTION	DATE	BY
Α	DEVELOPMENT APPLICATION	25/06/18	СВ
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SCHEDULE OF MATERIALS AND FINISHES

REFERENCE		ELEMENT	MATERIAL	FINISH / SPECIFICATION
01	RW-01	EXTERNAL WALL	RENDER AND PAINT	DULUX B12 VIVID WHITE OR SIMILAR / CLADDING
02	BW-01	EXTERNAL WALL	BRICK	AUSTRAL SYMMETRY / ASPHALT
03	CW-01	EXTERNAL WALL	CLADDING	TIMBER CLADDING
04	PL-01	ARCHITECTURAL FEATURE	CLADDING	INTAGLIO PRO-FIT MODERA LEDGESTONE
05	SD-01	SLIDING DOOR	GLASS SET IN POWDER COATED ALUMINIUM FRAME	DULUX DURATEC X15 "ZEUS SILVER GREY" OR SIMILA
06	AF-01	PRIVACY SCREEN FENCE	TIMBER FENCE	TIMBER
07	RO-01	ROOF	COLORBOND ROOF	WHITE / SIGNATURE
08	BA-01	BALUSTRADE	GLASS SET IN POWDER COATED ALUMINUM FRAME	DULUX DURATEC X15 "ZEUS SILVER GREY" OR SIMILA
09	DR-01	DRIVEWAY	CONCRETE	COLORED DRIVEWAY / DUNE




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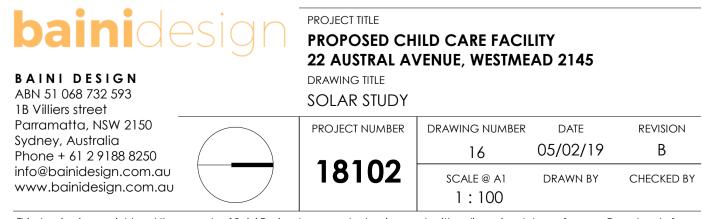
SHADING DEVICES	
OUTDOOR SHADED AREA FROM PERGOLA:	78 m²
OUTDOOR ROOF AREA:	122 m²
TOTAL AREA OF OUTDOOR PLAY AREA:	329 m²
TOTAL SHADING AREA:	200 m²
PERCENTAGE OF SHADE/OUTDOOR:	60%




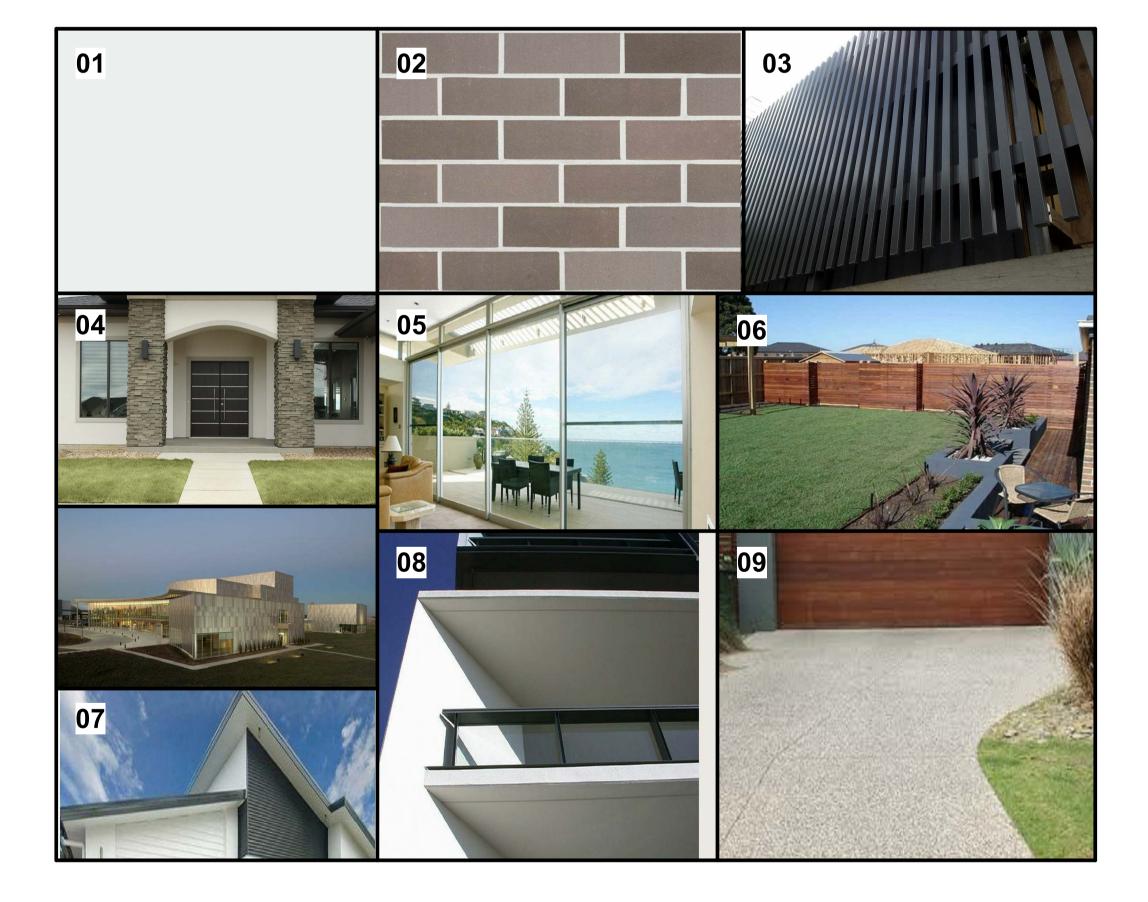


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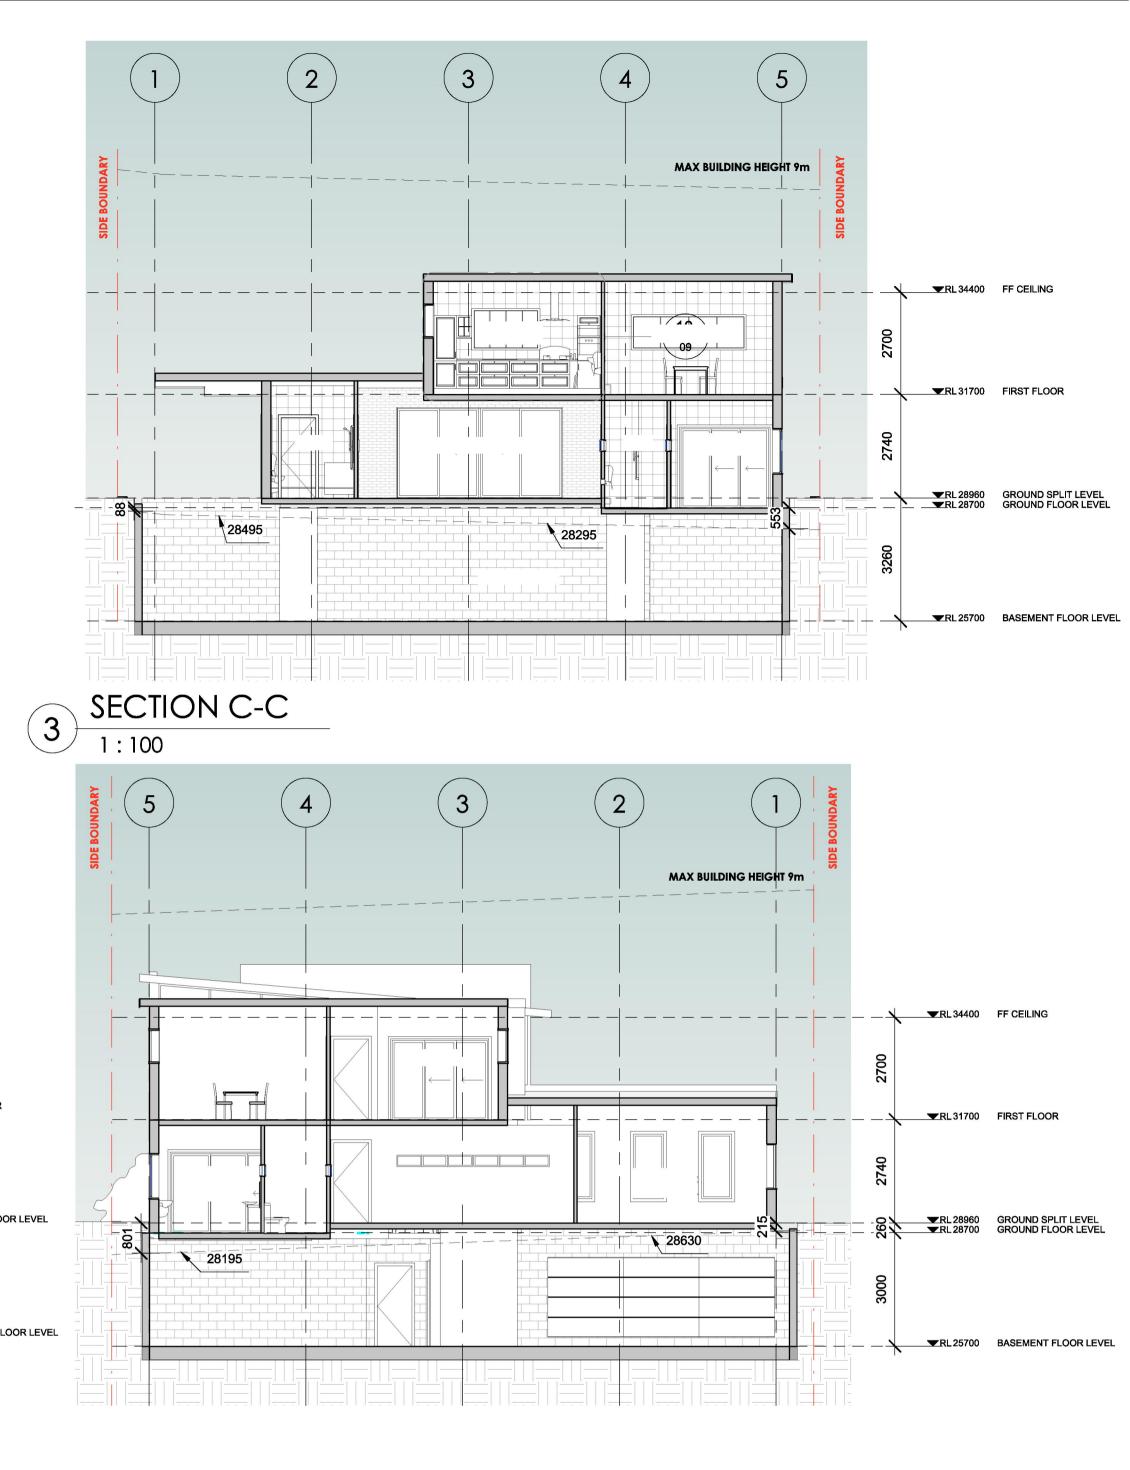


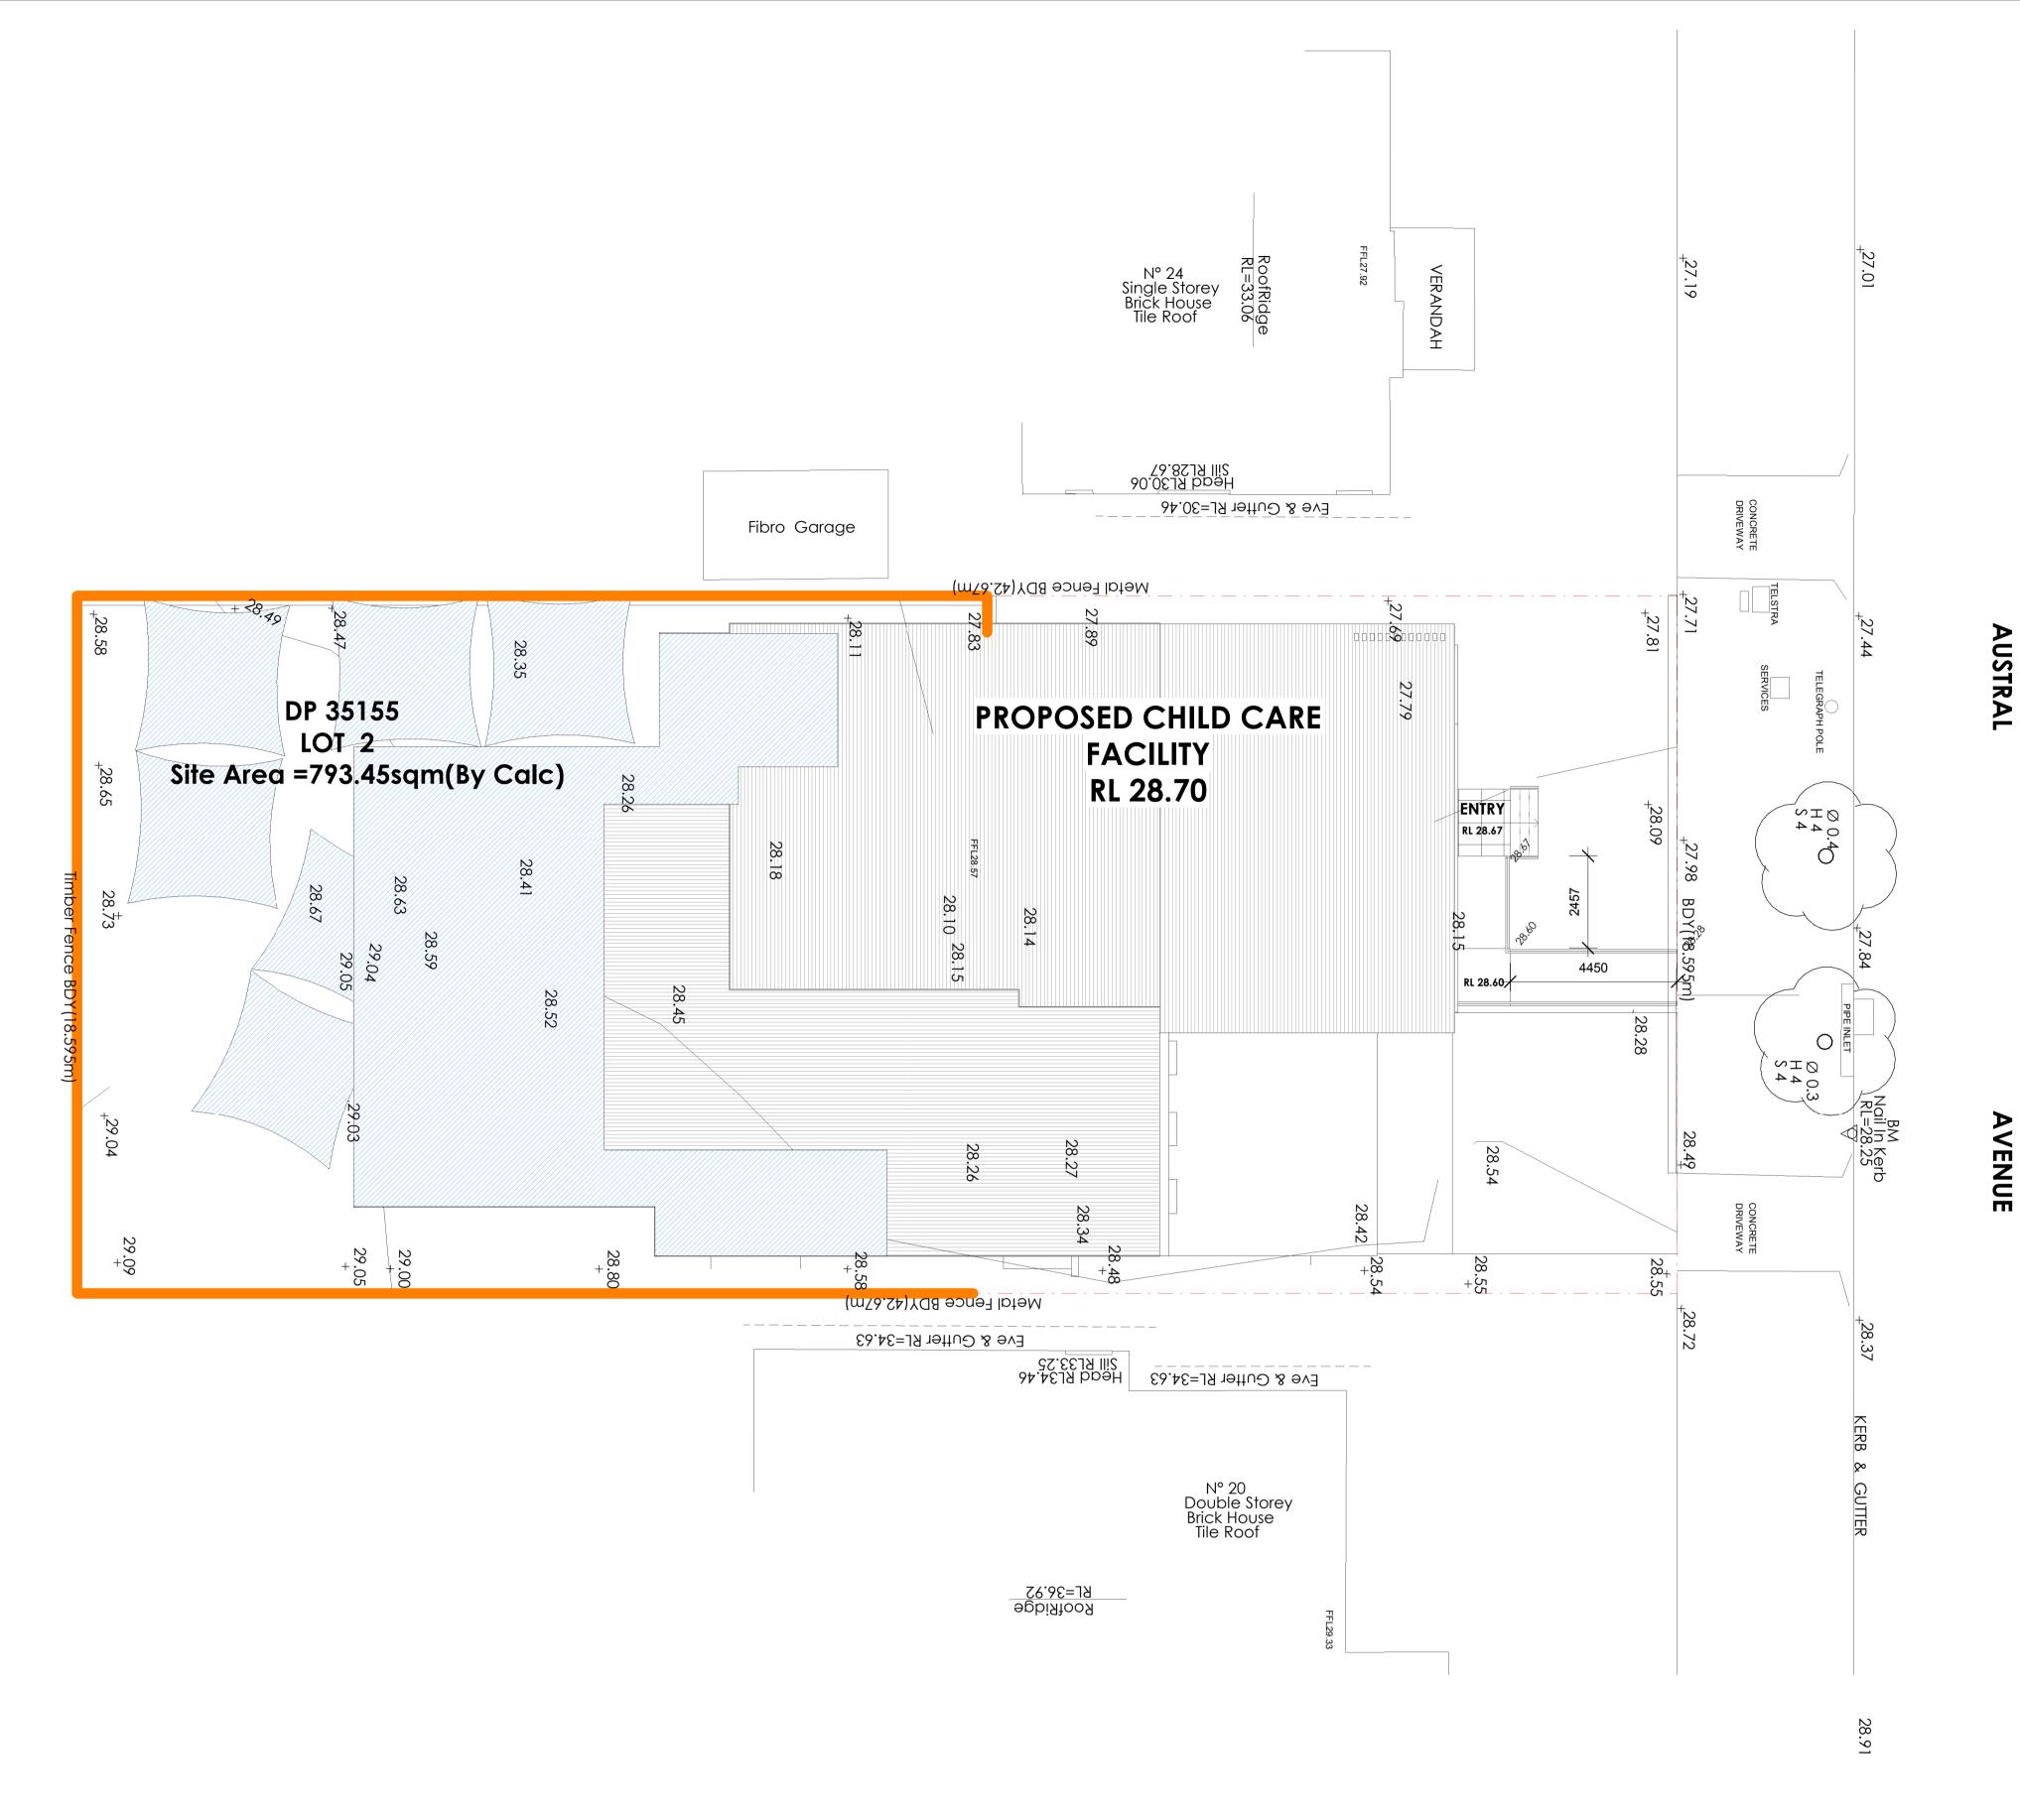

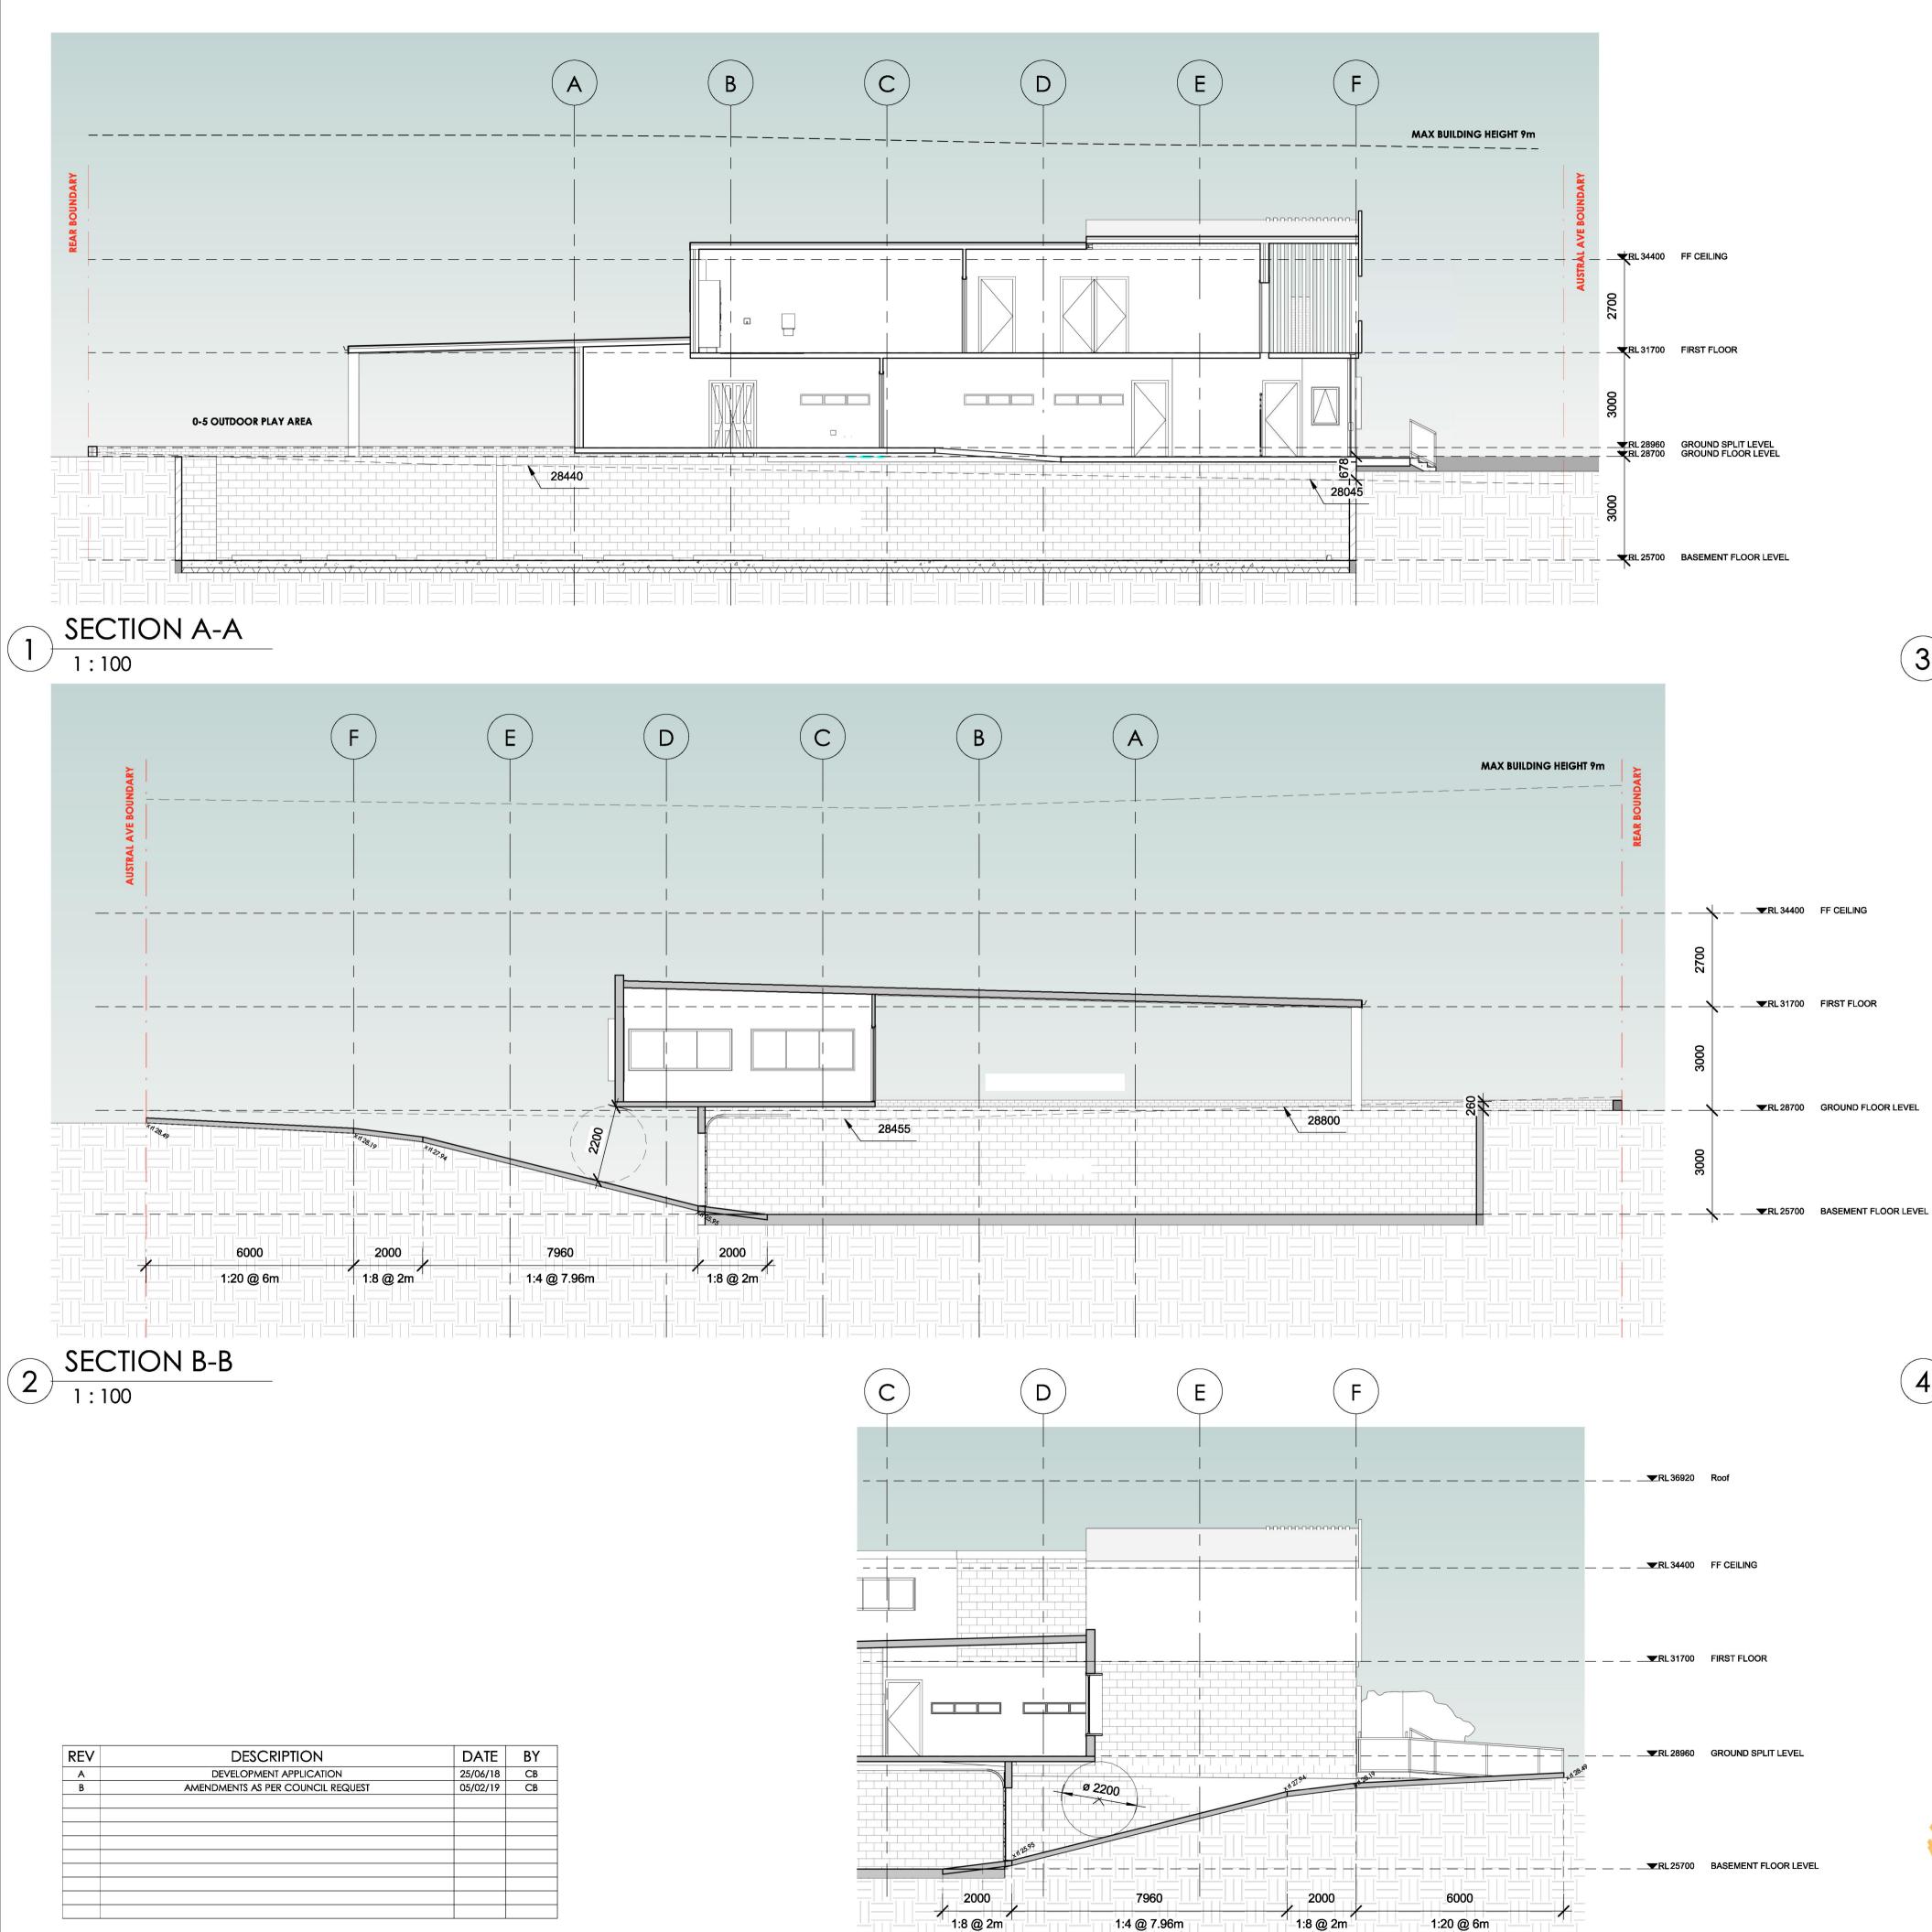

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PROJECT NUMBER DRAWING NUMBER DATE REVISION 05/02/19 17 В 18102 SCALE @ A1 DRAWN BY CHECKED BY 1:100

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22 AUSTRAL AVENUE, WESTMEAD PROPOSED CHILD CARE CENTRE STORMWATER MANAGEMENT PLANS

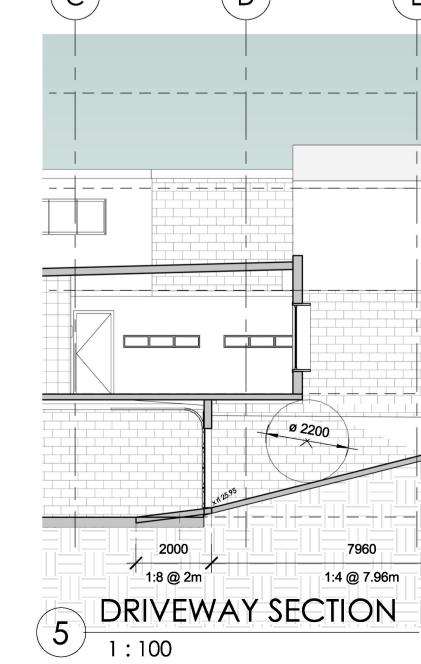

					Certification By Dr. Anthony Hasham (NPER):	Architect
					The	Baini Design Off 2, Level 4,
В	COUNCIL COMMENTS	08/02/2019	JMH	JAB		25-33 Old Northern Road,
А	ISSUE FOR DEVELOPMENT APPLICATION	12/07/2018	JMH	JAB		Baulkham Hills, NSW 2153
Issue	Description	Date	Design	Checked	Mart	EMAIL : info@bainidesign.com.au PHONE : +61 2 9639 1674
0 10	m at full size			20cm	1 20	

LOCALITY PLAN N.T.S


DRAWING INDEX					
Drawing No.	DESCRIPTION				
000	COVER SHEET PLAN				
101	STORMWATER LAYOUT PLAN BASEMENT LEVEL SHEET 1 OF 2				
102	STORMWATER LAYOUT PLAN BASEMENT LEVEL SHEET 2 OF 2				
103	STORMWATER LAYOUT PLAN				
104	ON-SITE DETENTION DETAILS AND CALCULATION SHEET SHEET 1 OF 4				
105	ON-SITE DETENTION DETAILS AND CALCULATION SHEET SHEET 2 OF 4				
106	ON-SITE DETENTION DETAILS AND CALCULATION SHEET SHEET 3 OF 4				
107	ON-SITE DETENTION DETAILS AND CALCULATION SHEET SHEET 4 OF 4				
108	MISCELLANEOUS DETAILS SHEET				








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L AVENUE, WESTMEAD O CHILD CARE CENTRE ER MANAGEMENT PLANS		R SHEET PLAN		
PMENT APPLICATION	Scale A1 N.T.S.	Project No. 180371	Dwg. No. 000	lssue B

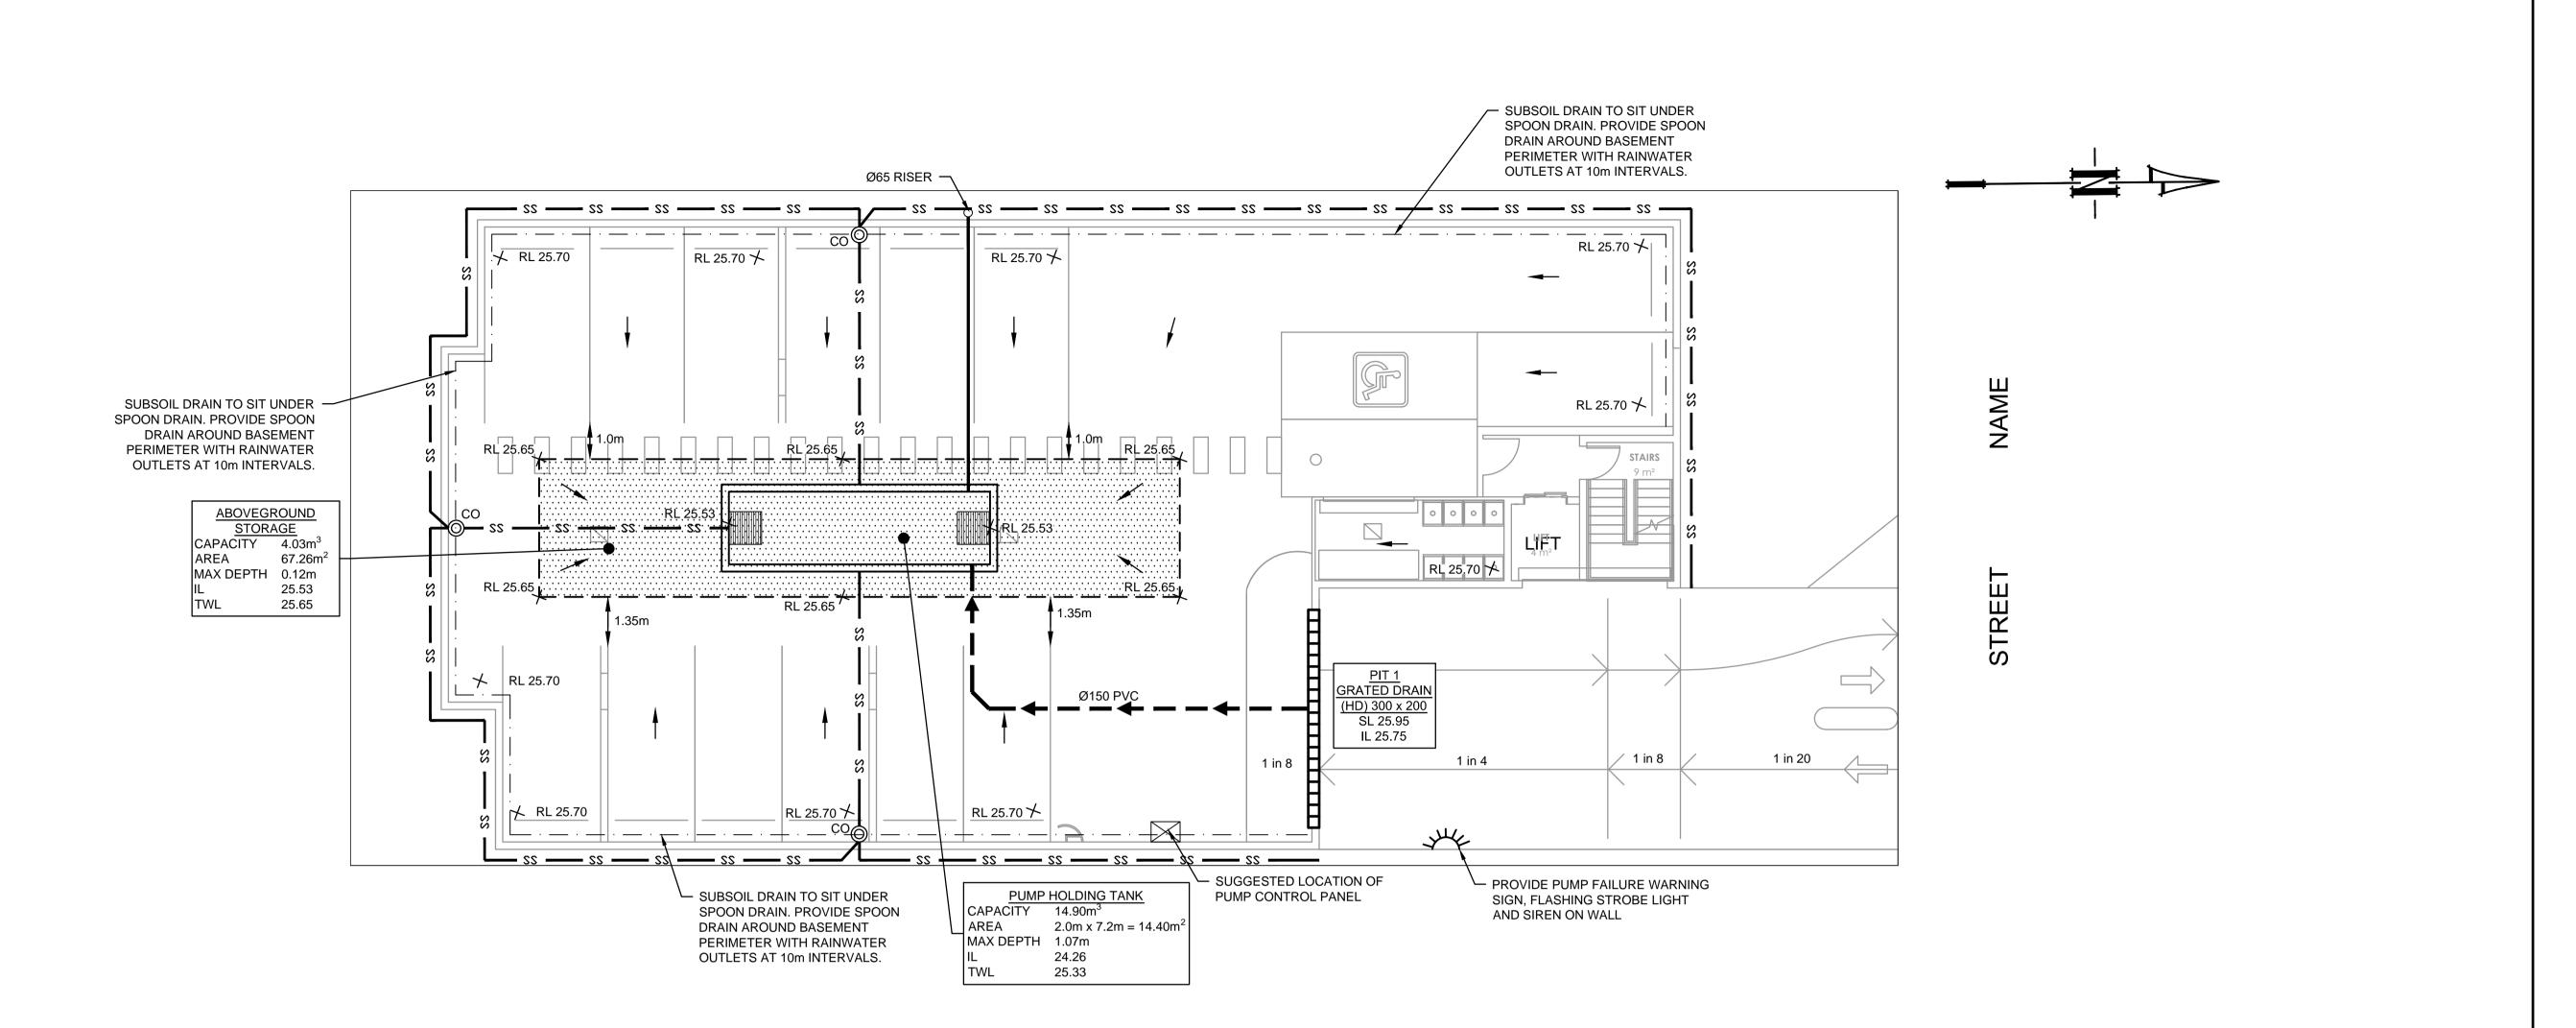

LEGEND

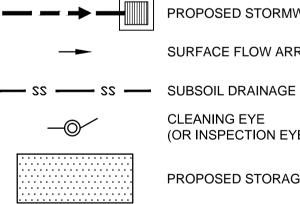

× RL 27.56

PROPOSED STORMWATER

SURFACE FLOW ARROWS

CLEANING EYE

(OR INSPECTION EYE)

PROPOSED STORAGE AREA

FINISHED SURFACE LEVEL

GRATED DRAIN

STANDARD PUMP OUT DESIGN NOTES

THE PUMP OUT SYSTEM SHALL BE DESIGN TO BE OPERATED IN THE FOLLOWING MANNER: 1 - THE PUMP SHALL BE PROGRAMMED TO WORK ALTERNATELY TO ALLOW BOTH PUMPS TO HAVE AN EQUAL OPERATION LOAD AND PUMP LIFE.

- 2 A FLOAT SHALL BE PROVIDED TO ENSURE OF THE MINIMUM REQUIRED WATER LEVEL IS MAINTAINED WITHIN THE SUMP AREA OF THE BELOW GROUND TANK. IN THIS REGARD THIS FLOAT WILL FUNCTION AS AN OFF SWITCH FOR THE PUMPS AT THE MINIMUM WATER LEVEL. THE SAME FLOAT SHALL BE SET TO TURN ONE OF THE PUMPS ON UPON THE WATER LEVEL IN THE TANK RISING TO APPROXIMATELY 300mm ABOVE THE MINIMUM WATER LEVEL. THE PUMP SHALL OPERATE UNTIL THE TANK IS DRAINED TO THE MINIMUM WATER LEVEL.
- 3 A SECOND FLOAT SHALL BE PROVIDE AT A HIGH LEVEL, WHICH IS APPROXIMATELY THE ROOF LEVEL OF THE BELOW GROUND TANK. THIS FLOAT SHALL START THE OTHER PUMP THAT IS NOT OPERATING AND ACTIVATE THE ALARM.
- 4 AN ALARM SYSTEM SHALL BE PROVIDE WITH A FLASHING STROBE LIGHT AND A PUMP FAILURE WARNING SIGN WHICH ARE TO BE LOCATED AT THE DRIVEWAY ENTRANCE TO THE BASEMENT LEVEL THE ALARM SYSTEM SHALL BE PROVIDED WITH A BATTERY BACK-UP IN CASE OF POWER FAILURE.
- 5 A CONFINED SPACE DANGER SIGN SHALL BE PROVIDED AT ALL ACCESS POINT TO THE PUMP-OUT STORAGE TANK IN ACCORDANCE WITH THE UPPER PARRAMATA RIVER CATCHMENT TRUST OSD HANDBOOK.

					Certification By Dr. Anthony Hasham (NPER):	Architect
			<u> </u>		The	Baini Design
В	COUNCIL COMMENTS	08/02/2019	JMH	JAB		25-33 Old Northern Road,
Α	ISSUE FOR DEVELOPMENT APPLICATION	12/07/2018	JMH	JAB		Baulkham Hills, NSW 2153
Issue	Description	Date	Design	Checked		EMAIL : info@bainidesign.com.a PHONE : +61 2 9639 1674
0 1	m at full size10cm			20cm		





Cumberland City Council

4 SCALE 1:100 @ A1



AUSTRALIAN CONSULTING JENGINEERS. AUSTRALIAN PTY LTD - A.C.N. 084 059 941 CONSULTING SHOP 2-141 CONCORD RD NORTH STRATHFIELD NSW 2137 PH: (02) 9763 I500 FX: (02) 9763 I5I5 EMAIL: info@aceeng.com.au





CONFINED SPACE DANGER SIGN

A) A CONFINED SPACE DANGER SIGN SHALL BE POSITIONED IN A LOCATION AT ALL ACCESS POINTS, SUCH THAT IT IS CLEARLY VISIBLE TO PERSONS PROPOSING TO ENTER THE BELOW GROUND TANK/S CONFINED SPACE.

B) MINIMUM DIMENSIONS OF THE SIGN - 300mm x 450mm (LARGE ENTRIES, SUCH AS DOORS) -250mm x 180mm (SMALL ENTRIES SUCH AS GRATES & MANHOLES)


C) THE SIGN SHALL BE MANUFACTURED FROM COLOUR BONDED ALUMINUM OR POLYPROPYLENE

D) SIGN SHALL BE AFFIXED USING SCREWS AT EACH CORNER OF THE SIGN

<u>COLOURS:</u> "DANGER" & BACKGROUND = WHITE ELLIPTICAL AREA = RED RECTANGLE CONTAINING ELLIPSE = BLACK BORDER AND OTHER LETTERING = BLACK

NOT FOR CONSTRUCTION


	BASEM	IWATER LAYO IENT LEVEL 1 OF 2	UT PLAN	
MENT APPLICATION	Scale A1 1:100	Project No. 180371	Dwg. No. 101	lssue B

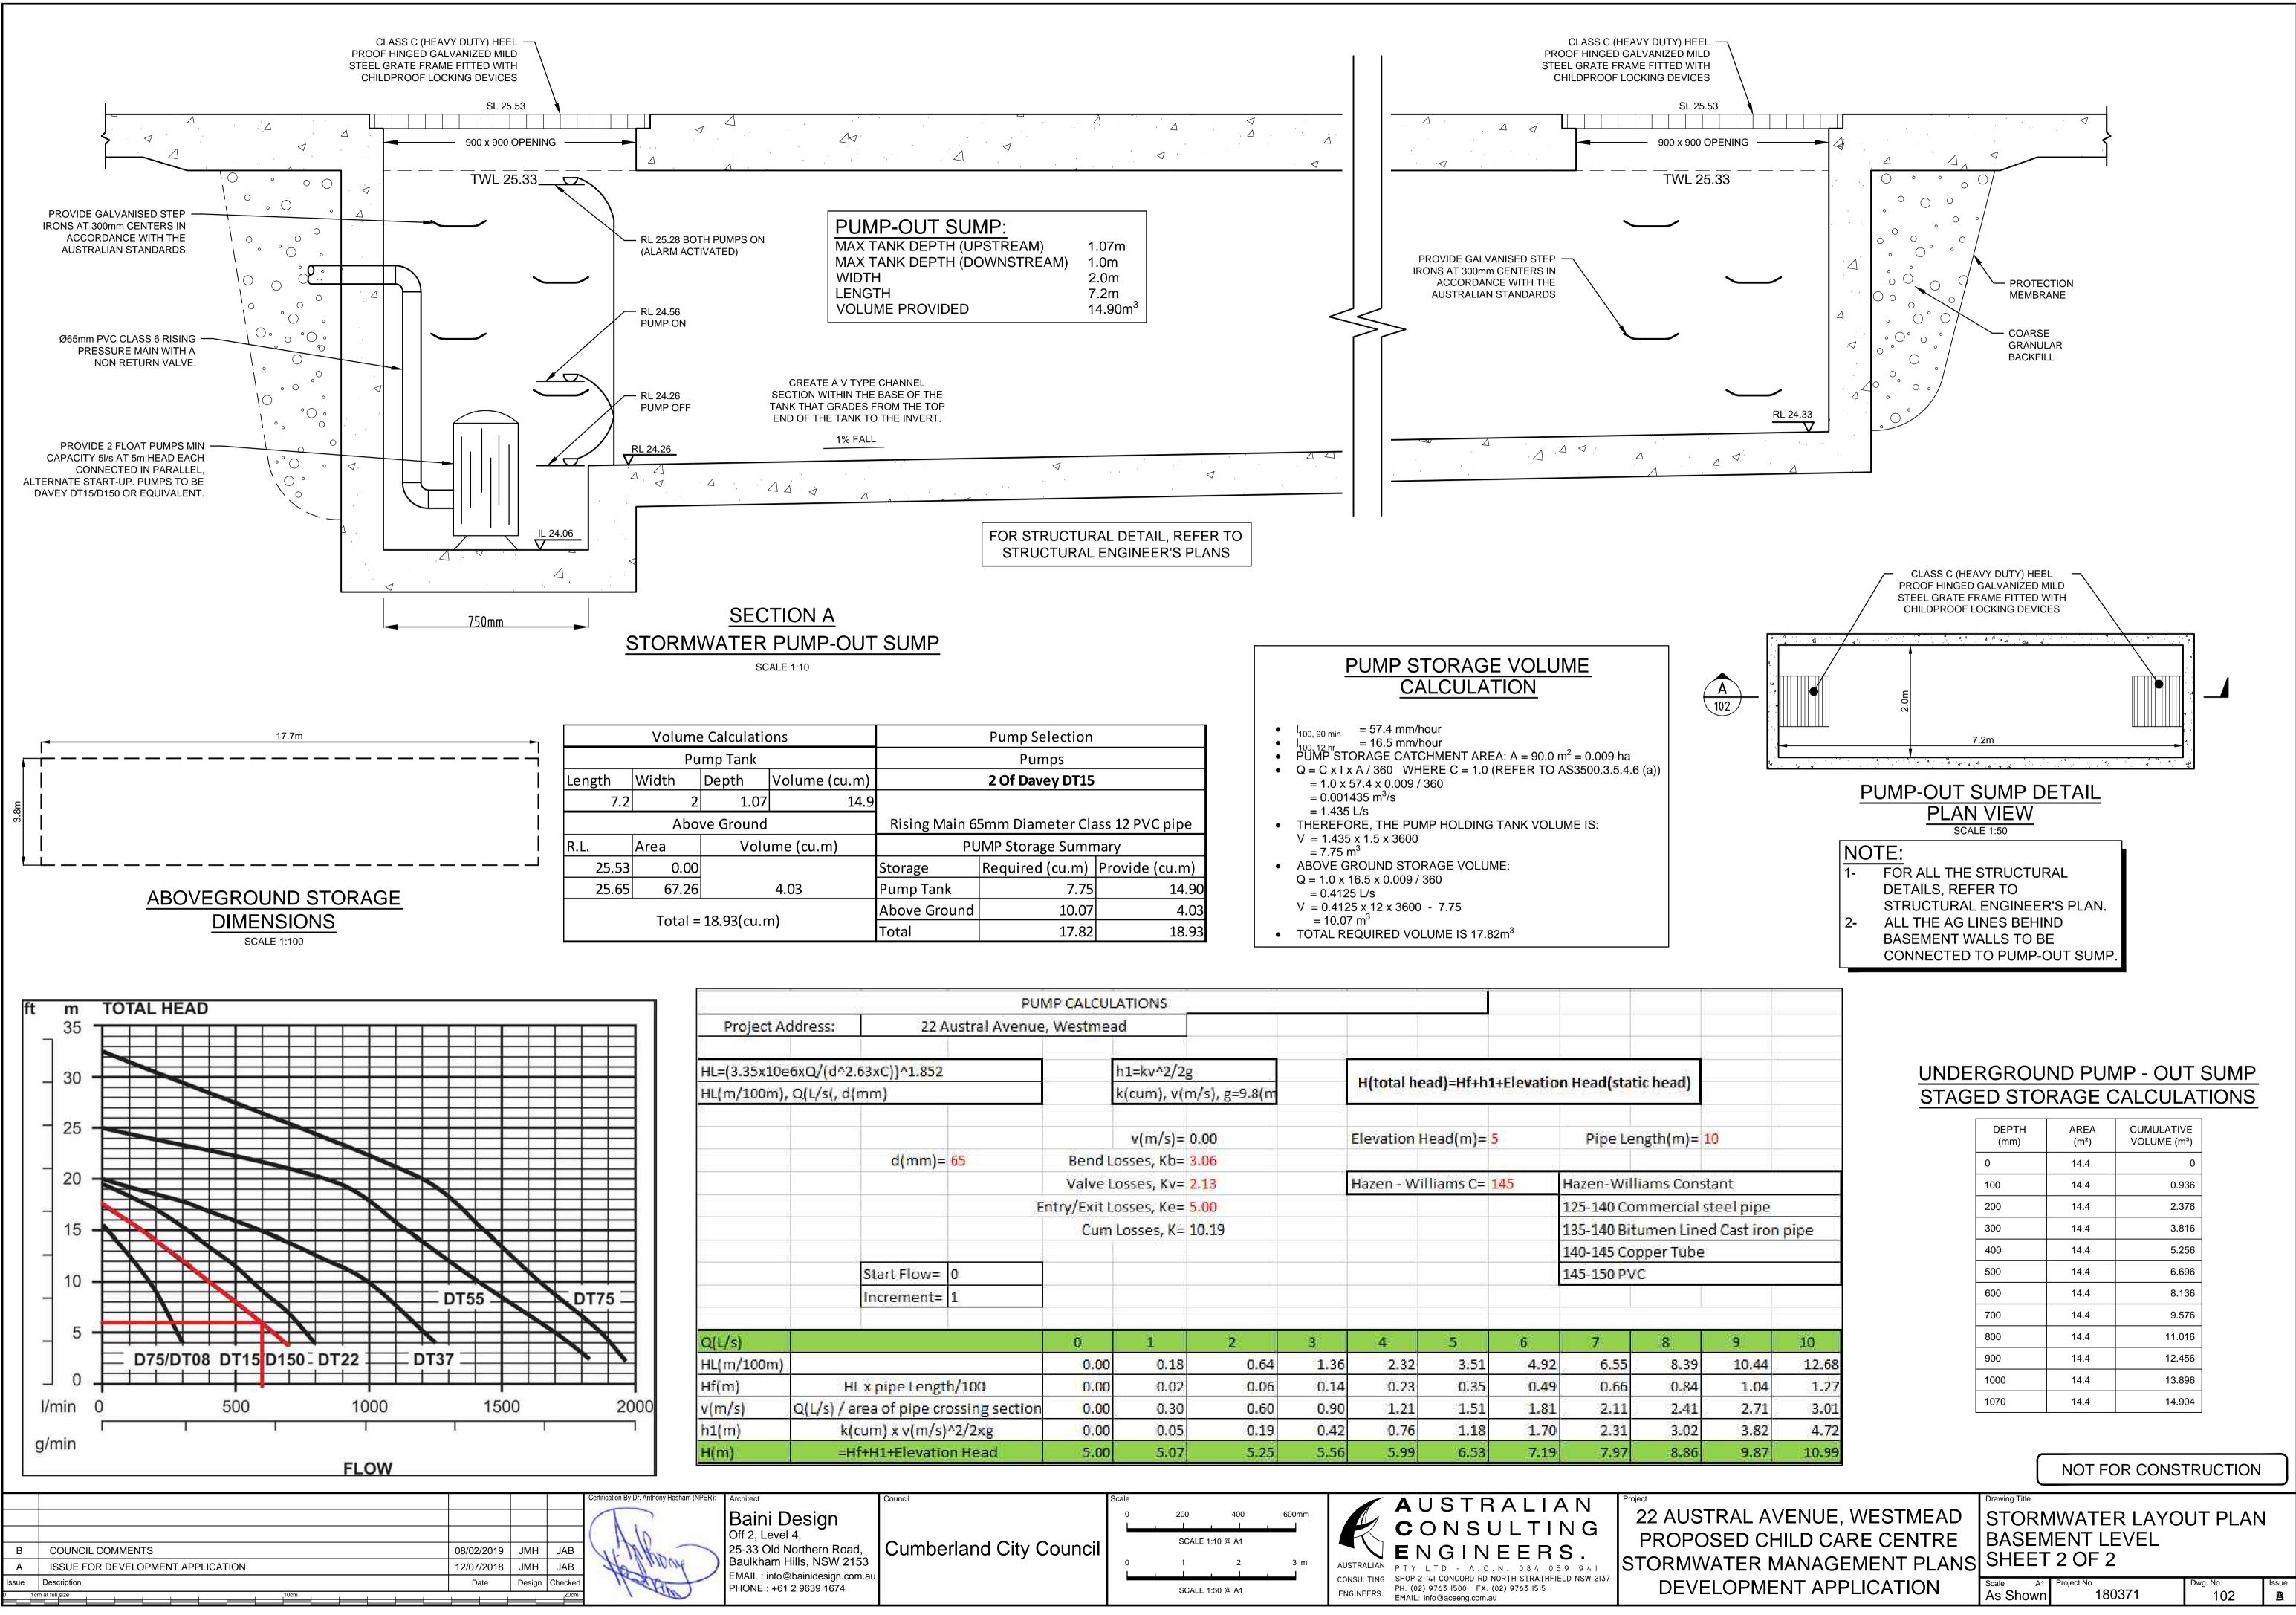

	Pump Selection						
		Pumps					
m)		2 Of Davey DT15					
4.9							
	Rising Main 65mm Diameter Class 12 PVC pipe						
	PUMP Storage Summary						
	Storage Required (cu.m) Provide (cu.m)						
	Pump Tank	7.75	14.90				
	Above Ground	10.07	4.03				
	Total	17.82	18.93				


	PUN	MP CALCUL	ATIONS	:							
22 A	ustral Avenue	, Westmea	be								
2.63xC))^1.852			h1=kv^2/2	σ		52 23C4	560 (F. 54	32 82	122	- 	
(mm)				¤ m/s), g=9.8(m		H(total he	ead) <mark>=</mark> Hf+h1	+Elevatio	n Head(stat	ic head)	
			v(m/s)=	0.00		Flevation	Head(m)= 5	5	Pinele	ngth(m)= 1	0
d(mm)=	65	Bend L	osses, Kb=			Licitation					
		A DAMAGE STREAM AND A DAMAGE STREAM	.osses, Kv=	A STREET		Hazen - W	illiams C= 1	45	Hazen-Will	iams Const	tant
	E	ntry/Exit L	osses, Ke=	5.00					125-140 Commercial steel pi		
		Cum	Losses, K=	10.19					135-140 Bit	umen Line	d Cast i
									140-145 Co	pper Tube	
Start Flow=	0								145-150 PV	c	
Increment=	1							74.			
		0	1	2	3	4	5	6	7	8	9
		0.00	0.18	0.64	1.36	2.32	3.51	4.92	6.55	8.39	10.4
IL x pipe Lengt	h/100	0.00	0.02	0.06	0.14	0.23	0.35	0.49	0.66	0.84	1.0
area of pipe crossing section		0.00	0.30	0.60	0.90	1.21	1.51	1.81	2.11	2.41	2.5
(cum) x v(m/s)^2/2xg		- 0.00	0.05	0.19	0.42	0.76	1.18	1.70	2.31	3.02	3.8
Hf+H1+Elevatic	on Head	5.00	5.07	5.25	5.56	5.99	6.53	7.19	7.97	8.86	9.8


, 53 n.au	Scale 0 200 400 600mm SCALE 1:10 @ A1 0 1 2 3 m SCALE 1:50 @ A1	AUSTRALIAN AUSTRALIAN CONSULTING ENGINEERS. AUSTRALIAN CONSULTING ENGINEERS. AUSTRALIAN CONSULTING ENGINEERS. AUSTRALIAN CONSULTING ENGINEERS. AUSTRALIAN CONSULTING ENGINEERS. AUSTRALIAN CONSULTING ENGINEERS. AUSTRALIAN CONSULTING ENGINEERS. AUSTRALIAN CONSULTING ENGINEERS. AUSTRALIAN CONSULTING ENGINEERS. AUSTRALIAN CONSULTING ENGINEERS. AUSTRALIAN CONSULTING ENGINEERS. AUSTRALIAN CONSULTING ENGINEERS. AUSTRALIAN CONSULTING ENGINEERS. AUSTRALIAN CONSULTING ENGINEERS. CONSULTING ENGINERS. CONSULTING ENGINERS. CONSULTING ENGINERS. CONSULTING ENGINERS. CONSULTING ENGINERS. CONSULTING ENGINERS. CONSULTING ENGINERS. CONSULTING ENGINERS. CONSULTING ENGINERS. CONSULTING ENGINERS. CONSULTING ENGINERS. CONSULTING ENGINERS. CONSULTING ENGINERS. CONSULT	Project 22 AUSTRAI PROPOSED STORMWATE DEVELOF
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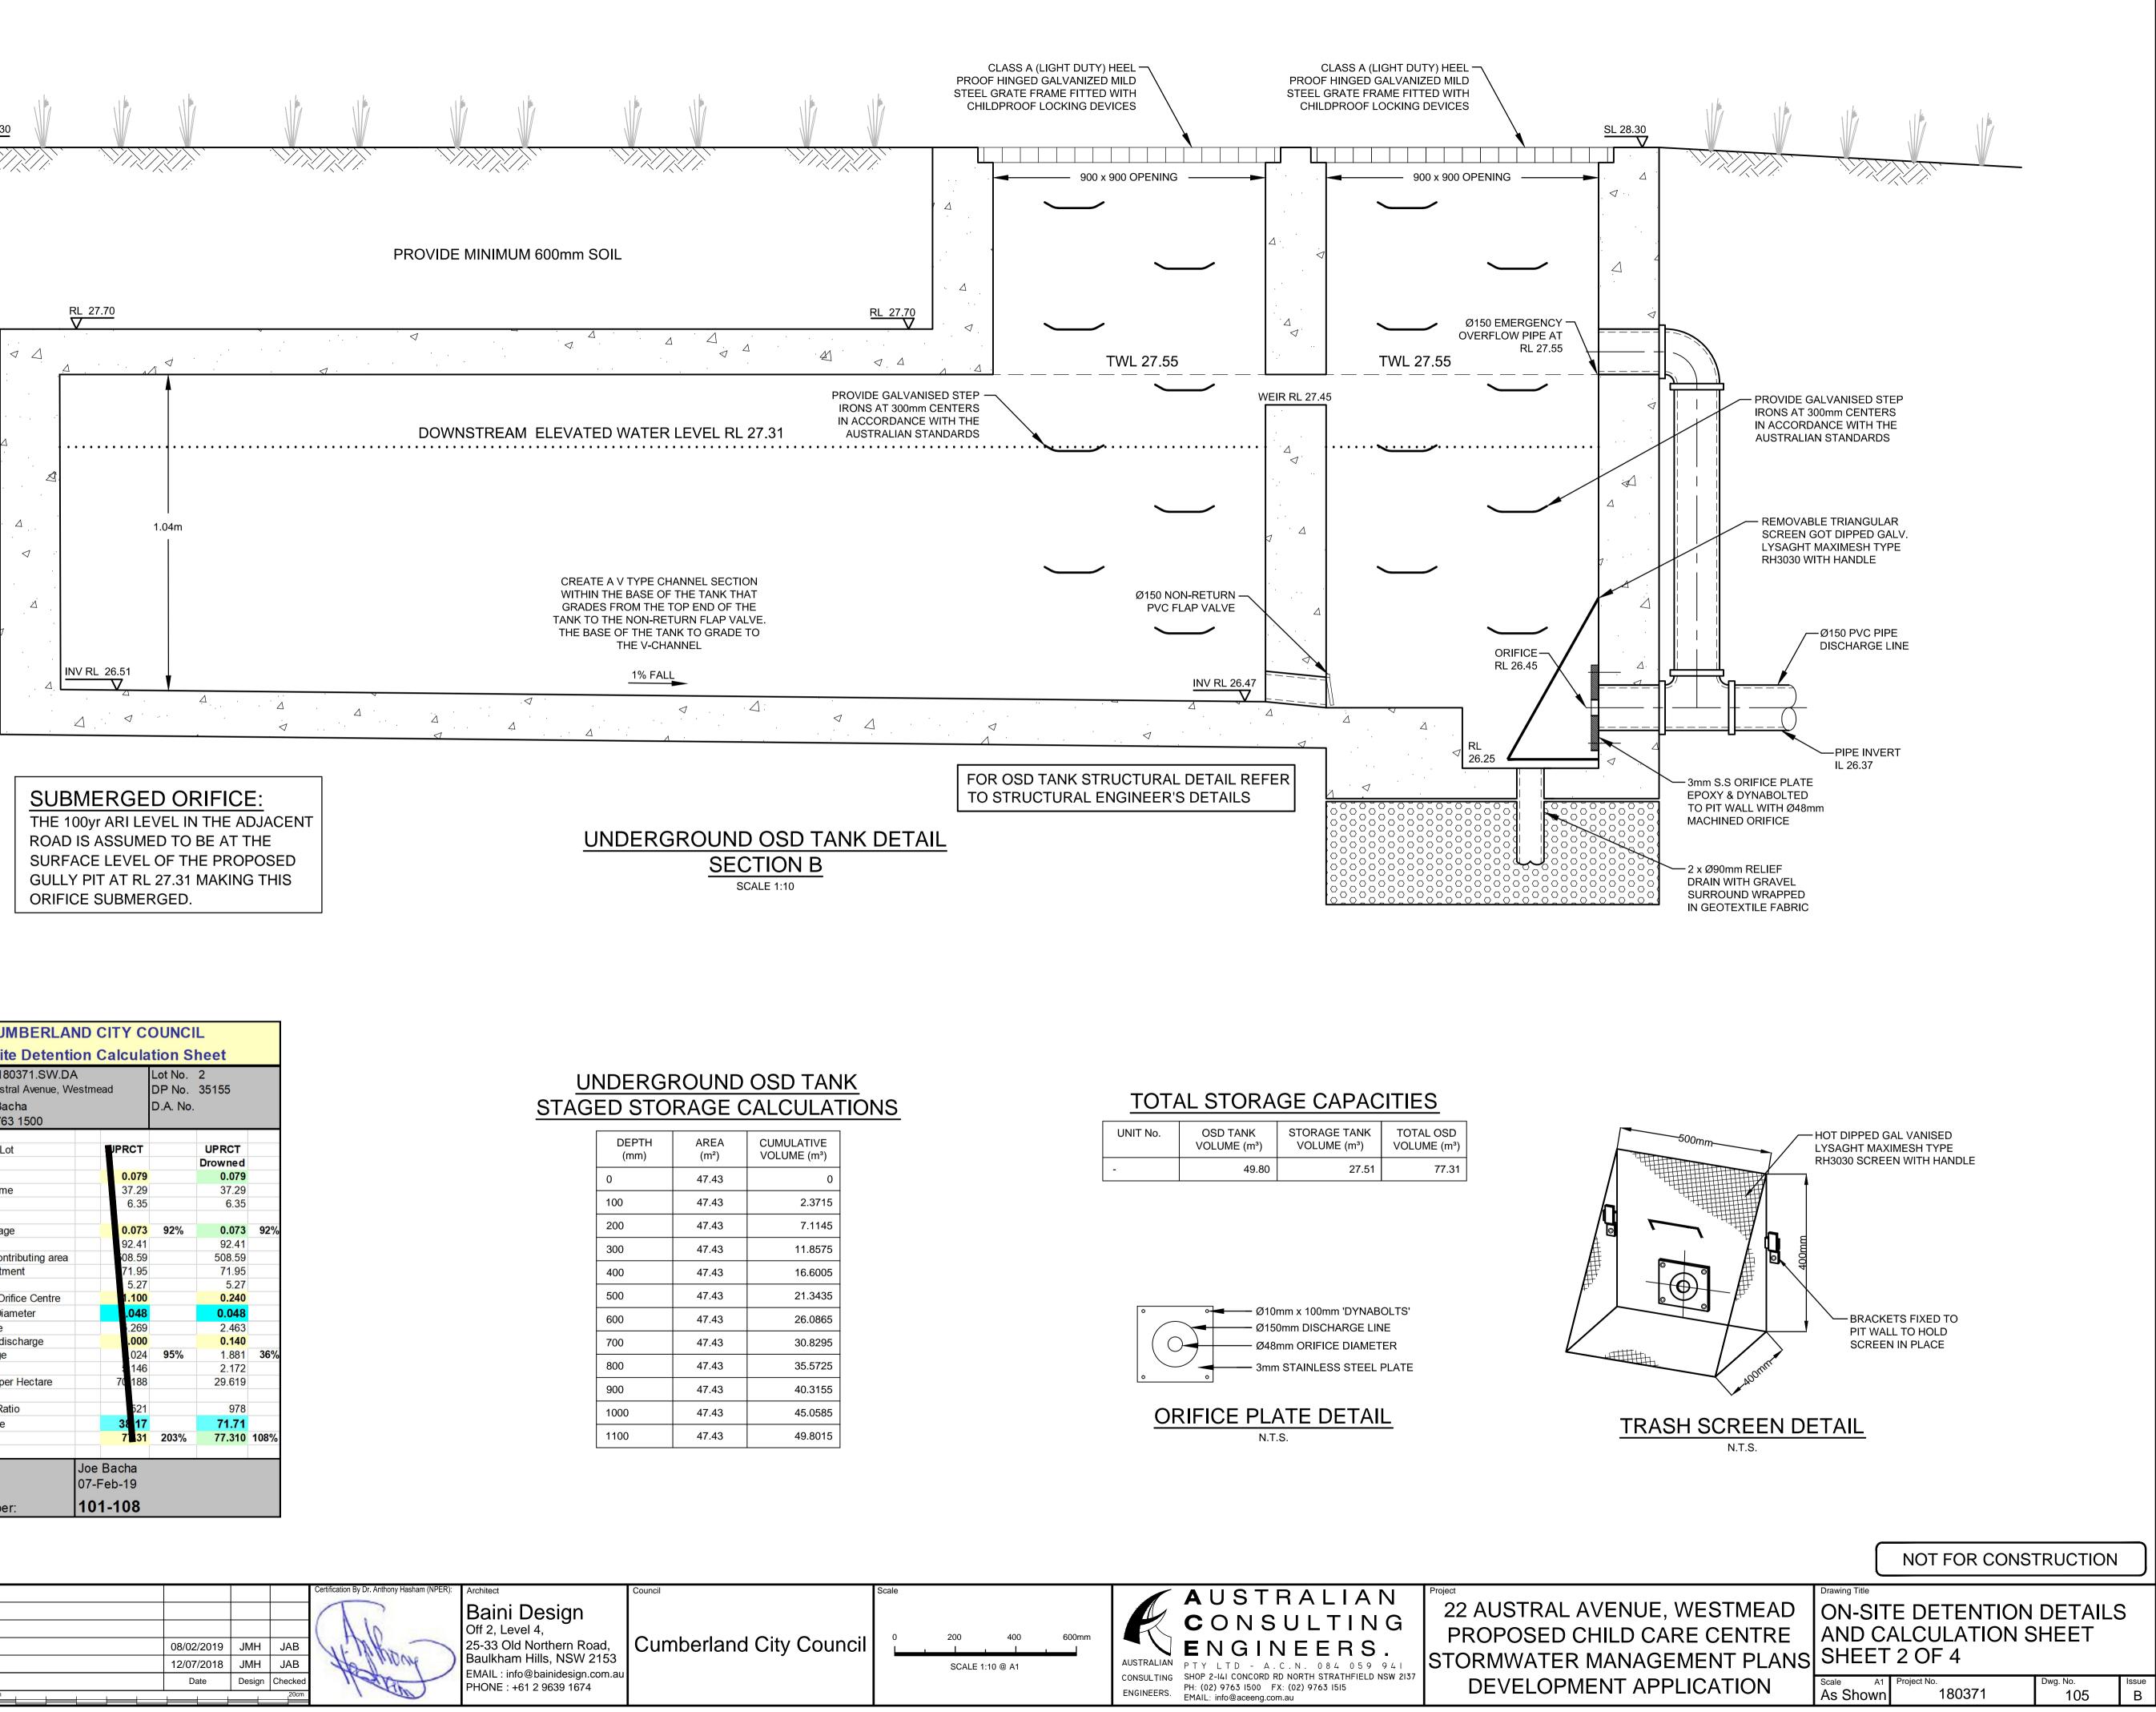

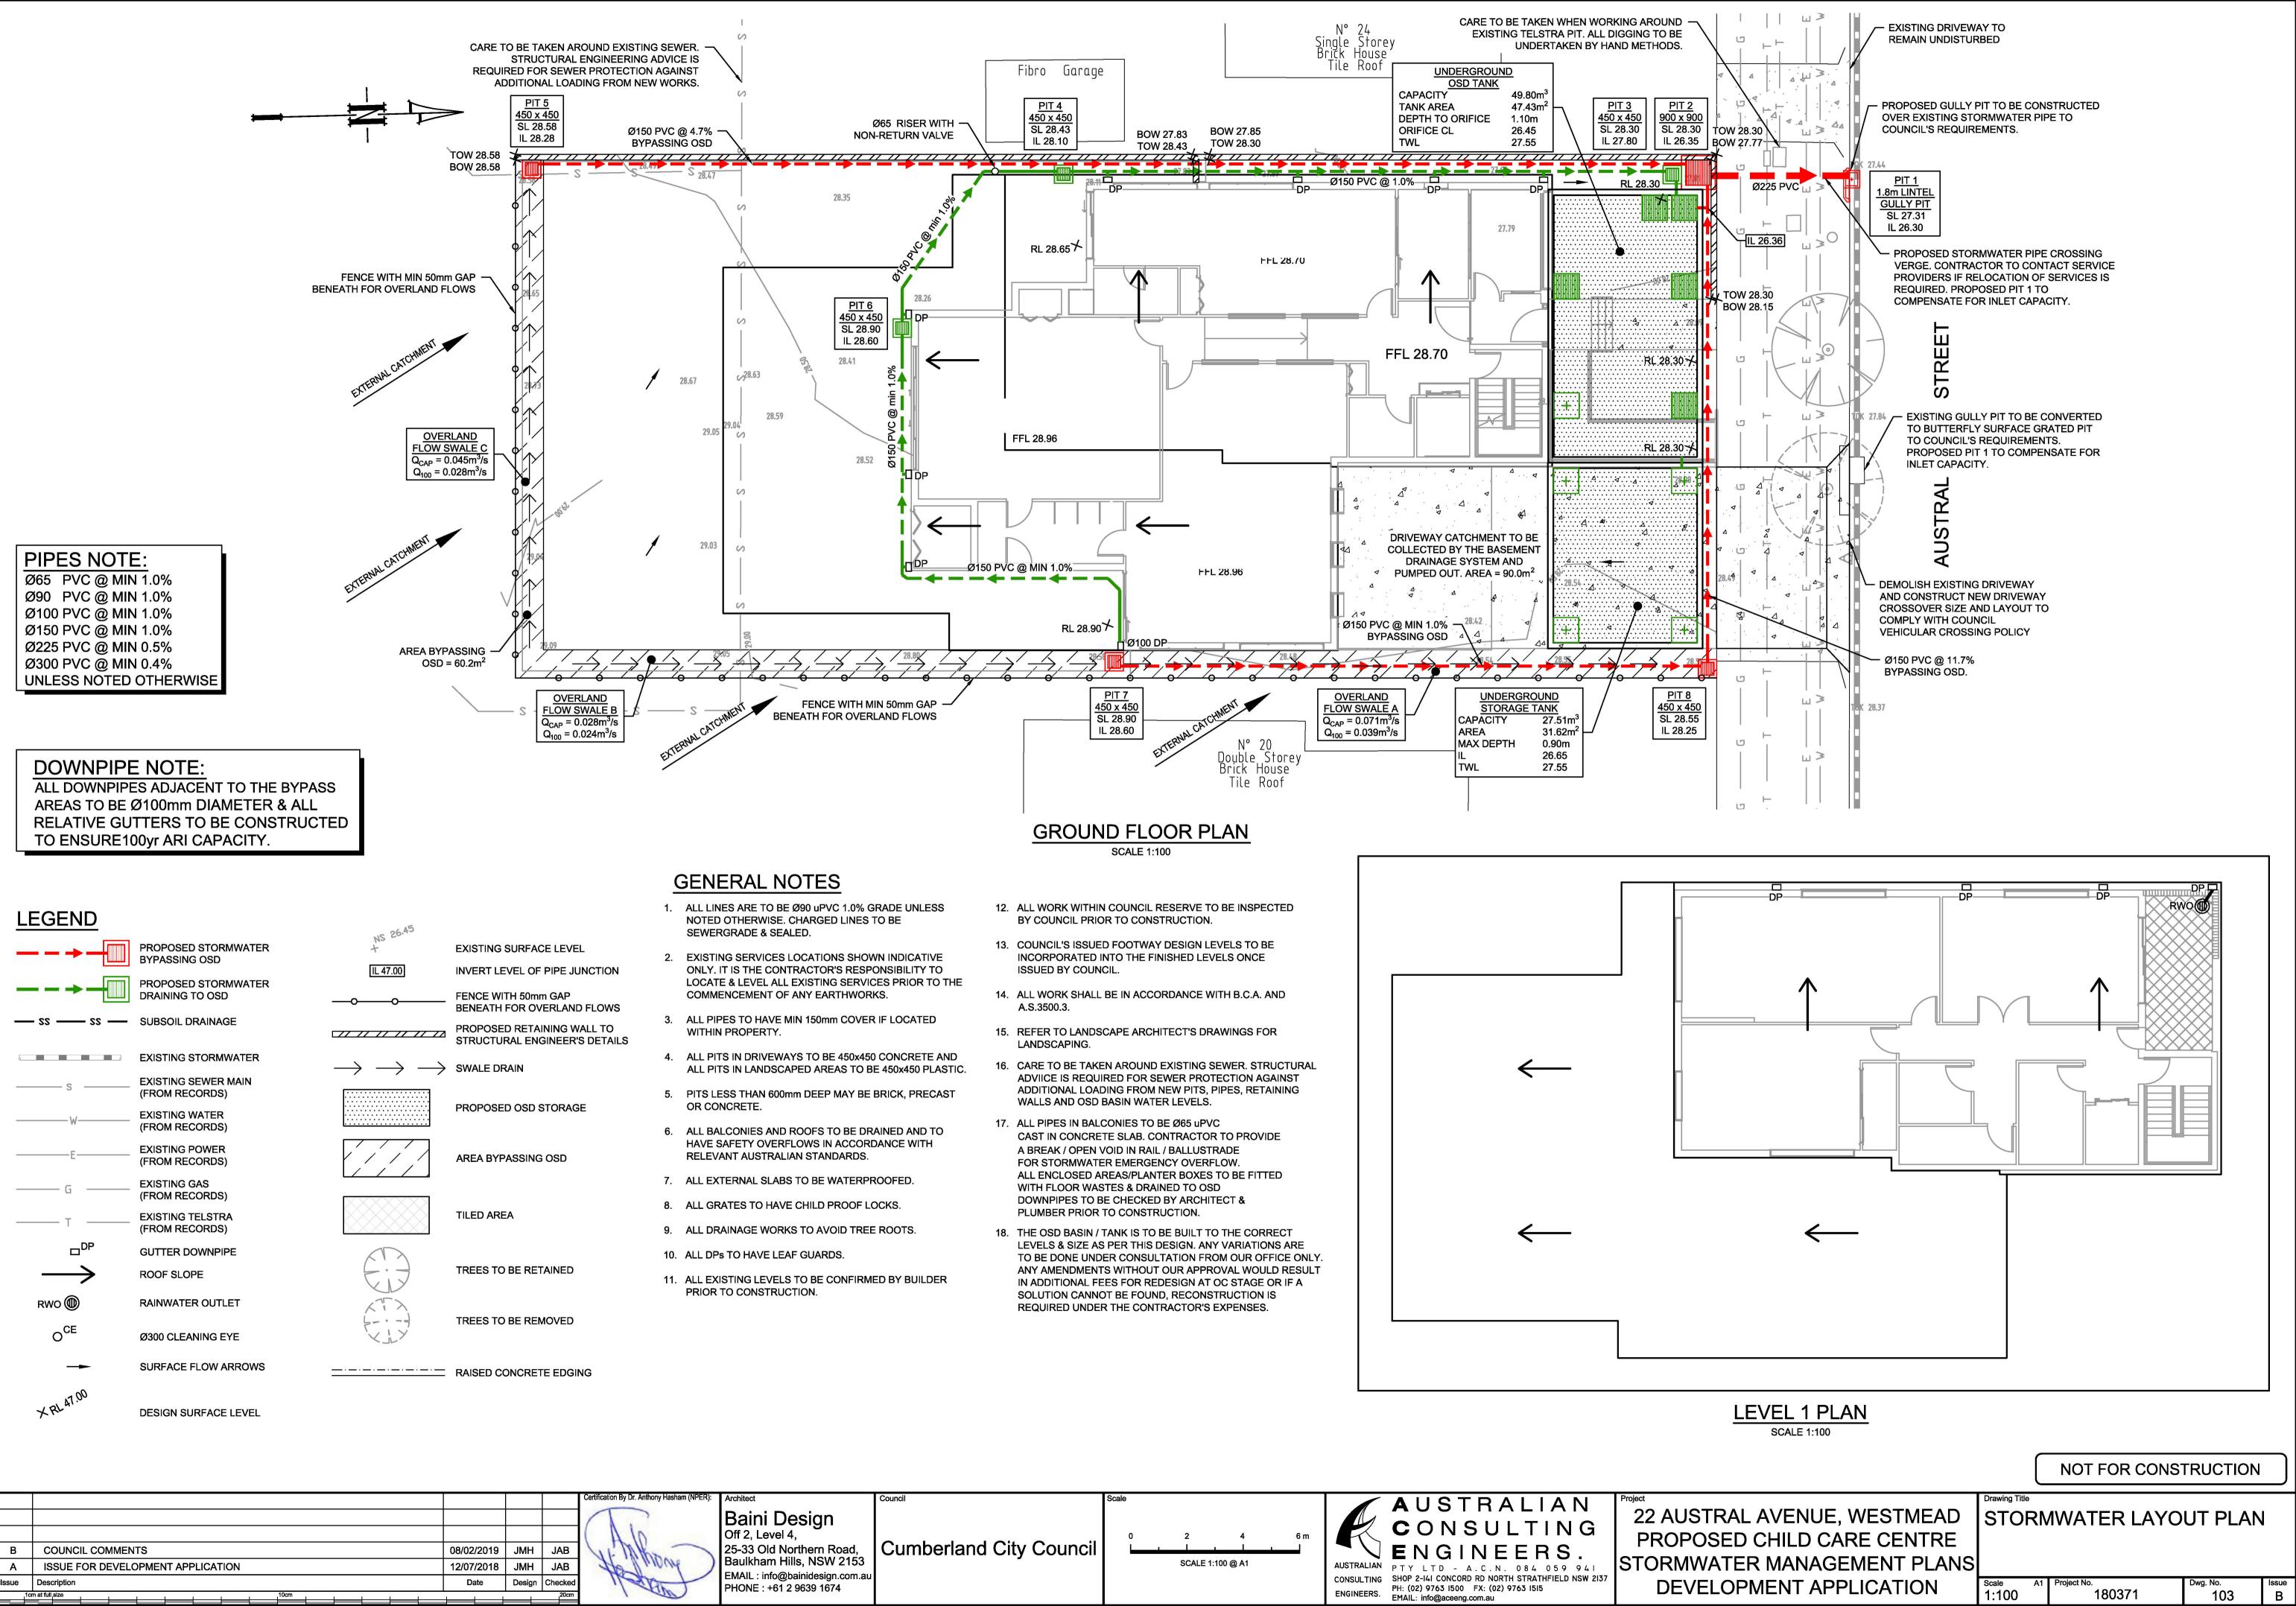
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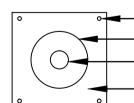



CUMBERLAND CITY COUNCIL On-Site Detention Calculation Sheet									
Project: ACE180371.SW.DA Lot No. 2									
Location:	22 Austral Avenue, W	estme	ead	DP No.	35155				
Designer:	Joe Bacha			D.A. No.					
Phone:	02 9763 1500								
OSD Area:	Front Lot		JPRCT		UPRCT				
					Drowned				
Site Area			0.079		0.079				
Basic Storag			37.29		37.29				
Basic Discha	irge		6.35		6.35				
Area of Site t	o Storage		0.073	92%	0.073	92%			
Percentage of	-		92.41		92.41				
-	a of contributing area		08.59		508.59				
Volume/PSD	Adjustment		71.95		71.95				
PSD for site			5.27		5.27				
Maximum He	ad to Orifice Centre		1.100		0.240				
Calculated O	rifice Diameter		.048		0.048				
Maximum dis	scharge		.269		2.463				
Head for high	early discharge		.000		0.140				
High Early Di	scharge		.024	95%	1.881	36%			
Mean Discha	rge		: 146		2.172				
Average Disc	harge per Hectare		70 188		29.619				
Final Site Sto	orage Ratio		521		978				
Site Storage	Volume		38 17		71.71				
Volume Provi	ded		7 31	203%	77.310	108%			
Checked By: Joe Bacha									
Date Checked: 07-Feb-19									
OSD Plan	Number:	101-108							


					Certification By Dr. Anthony Hasham (NPER):	Architect
					The	Baini Design
В	COUNCIL COMMENTS	08/02/2019	JMH	JAB	U. Miles	25-33 Old Northern F
А	ISSUE FOR DEVELOPMENT APPLICATION	12/07/2018	JMH	JAB	Ho hours	Baulkham Hills, NSW
Issue	Description	Date	Design	Checked	Mart 1	EMAIL : info@bainidesigr PHONE : +61 2 9639 167
0 1ci	n at full size 10cm			20cm		1 110 NE . 131 2 0000 101

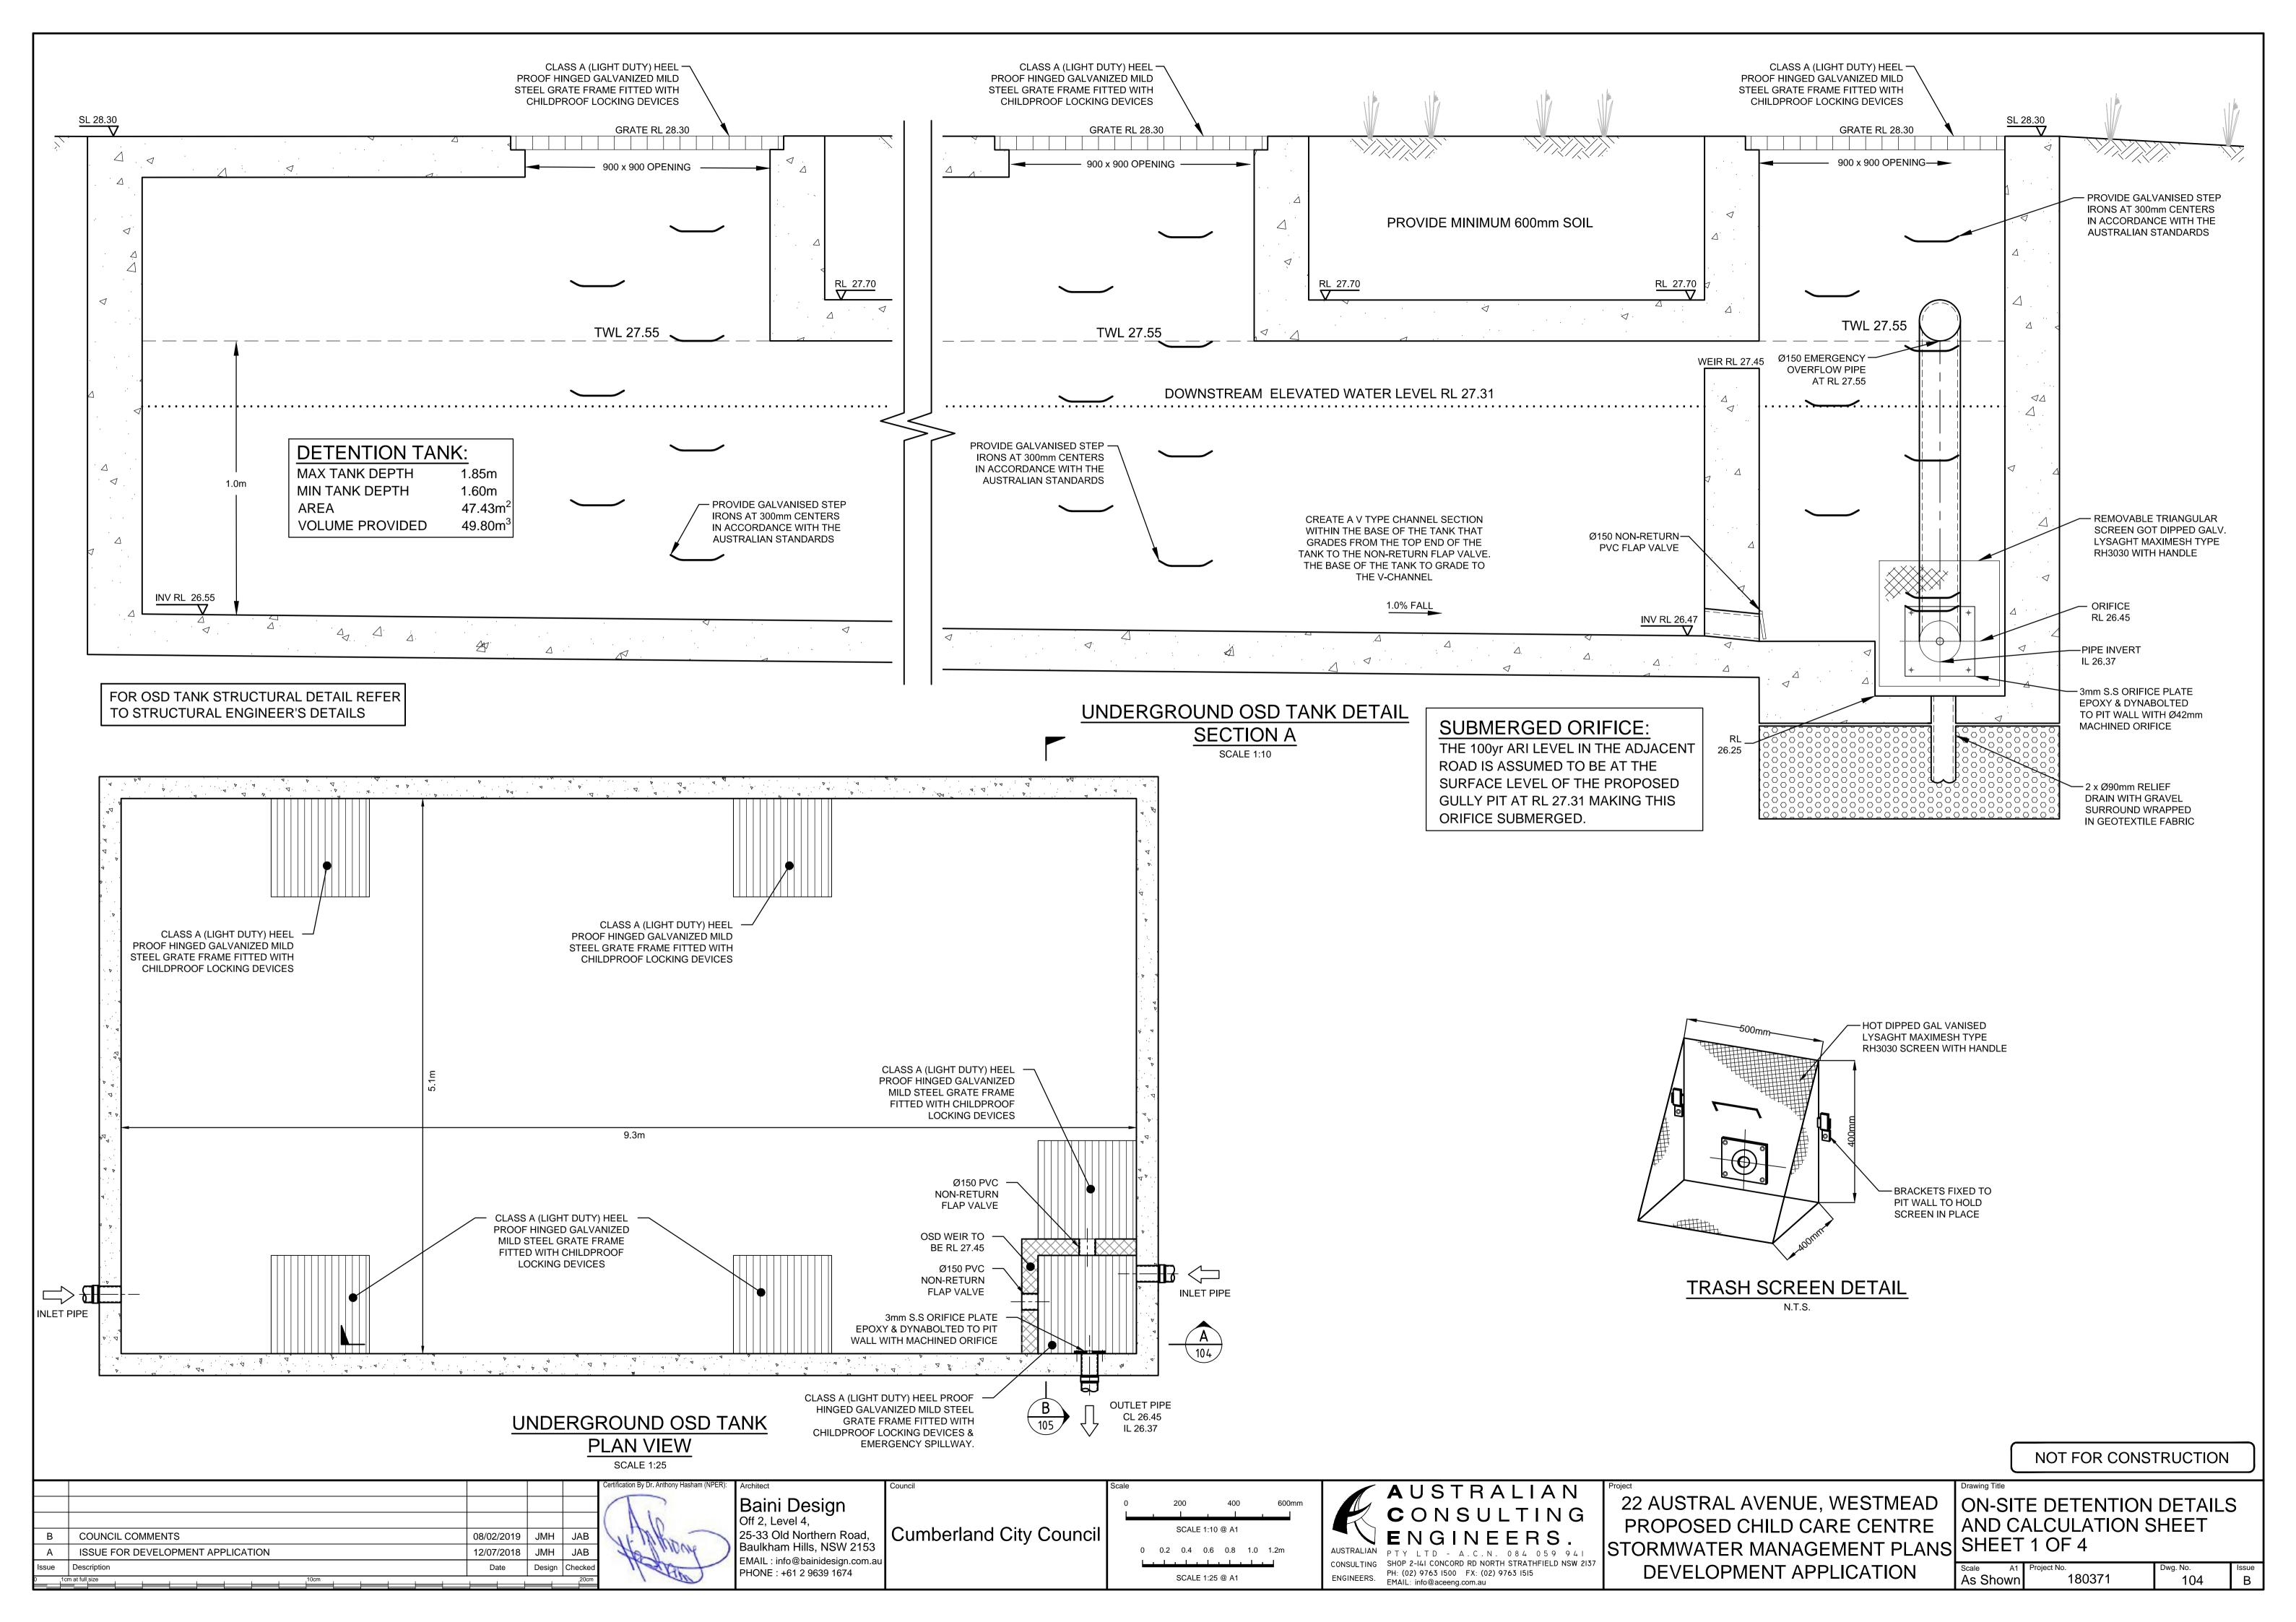DEPTH	AREA	CUMULATIVE
(mm)	(m²)	VOLUME (m ³)
-		
0	47.43	0
100	47.43	2.3715
100	-77.40	2.0710
200	47.43	7.1145
300	47.43	11.8575
400	47.43	16.6005
100		10.0000
500	47.43	21.3435
	17.10	
600	47.43	26.0865
700	47.43	30.8295
100		00.0200
800	47.43	35.5725
	17.10	10.01.55
900	47.43	40.3155
1000	47.43	45.0585
		+0.0000
1100	47.43	49.8015

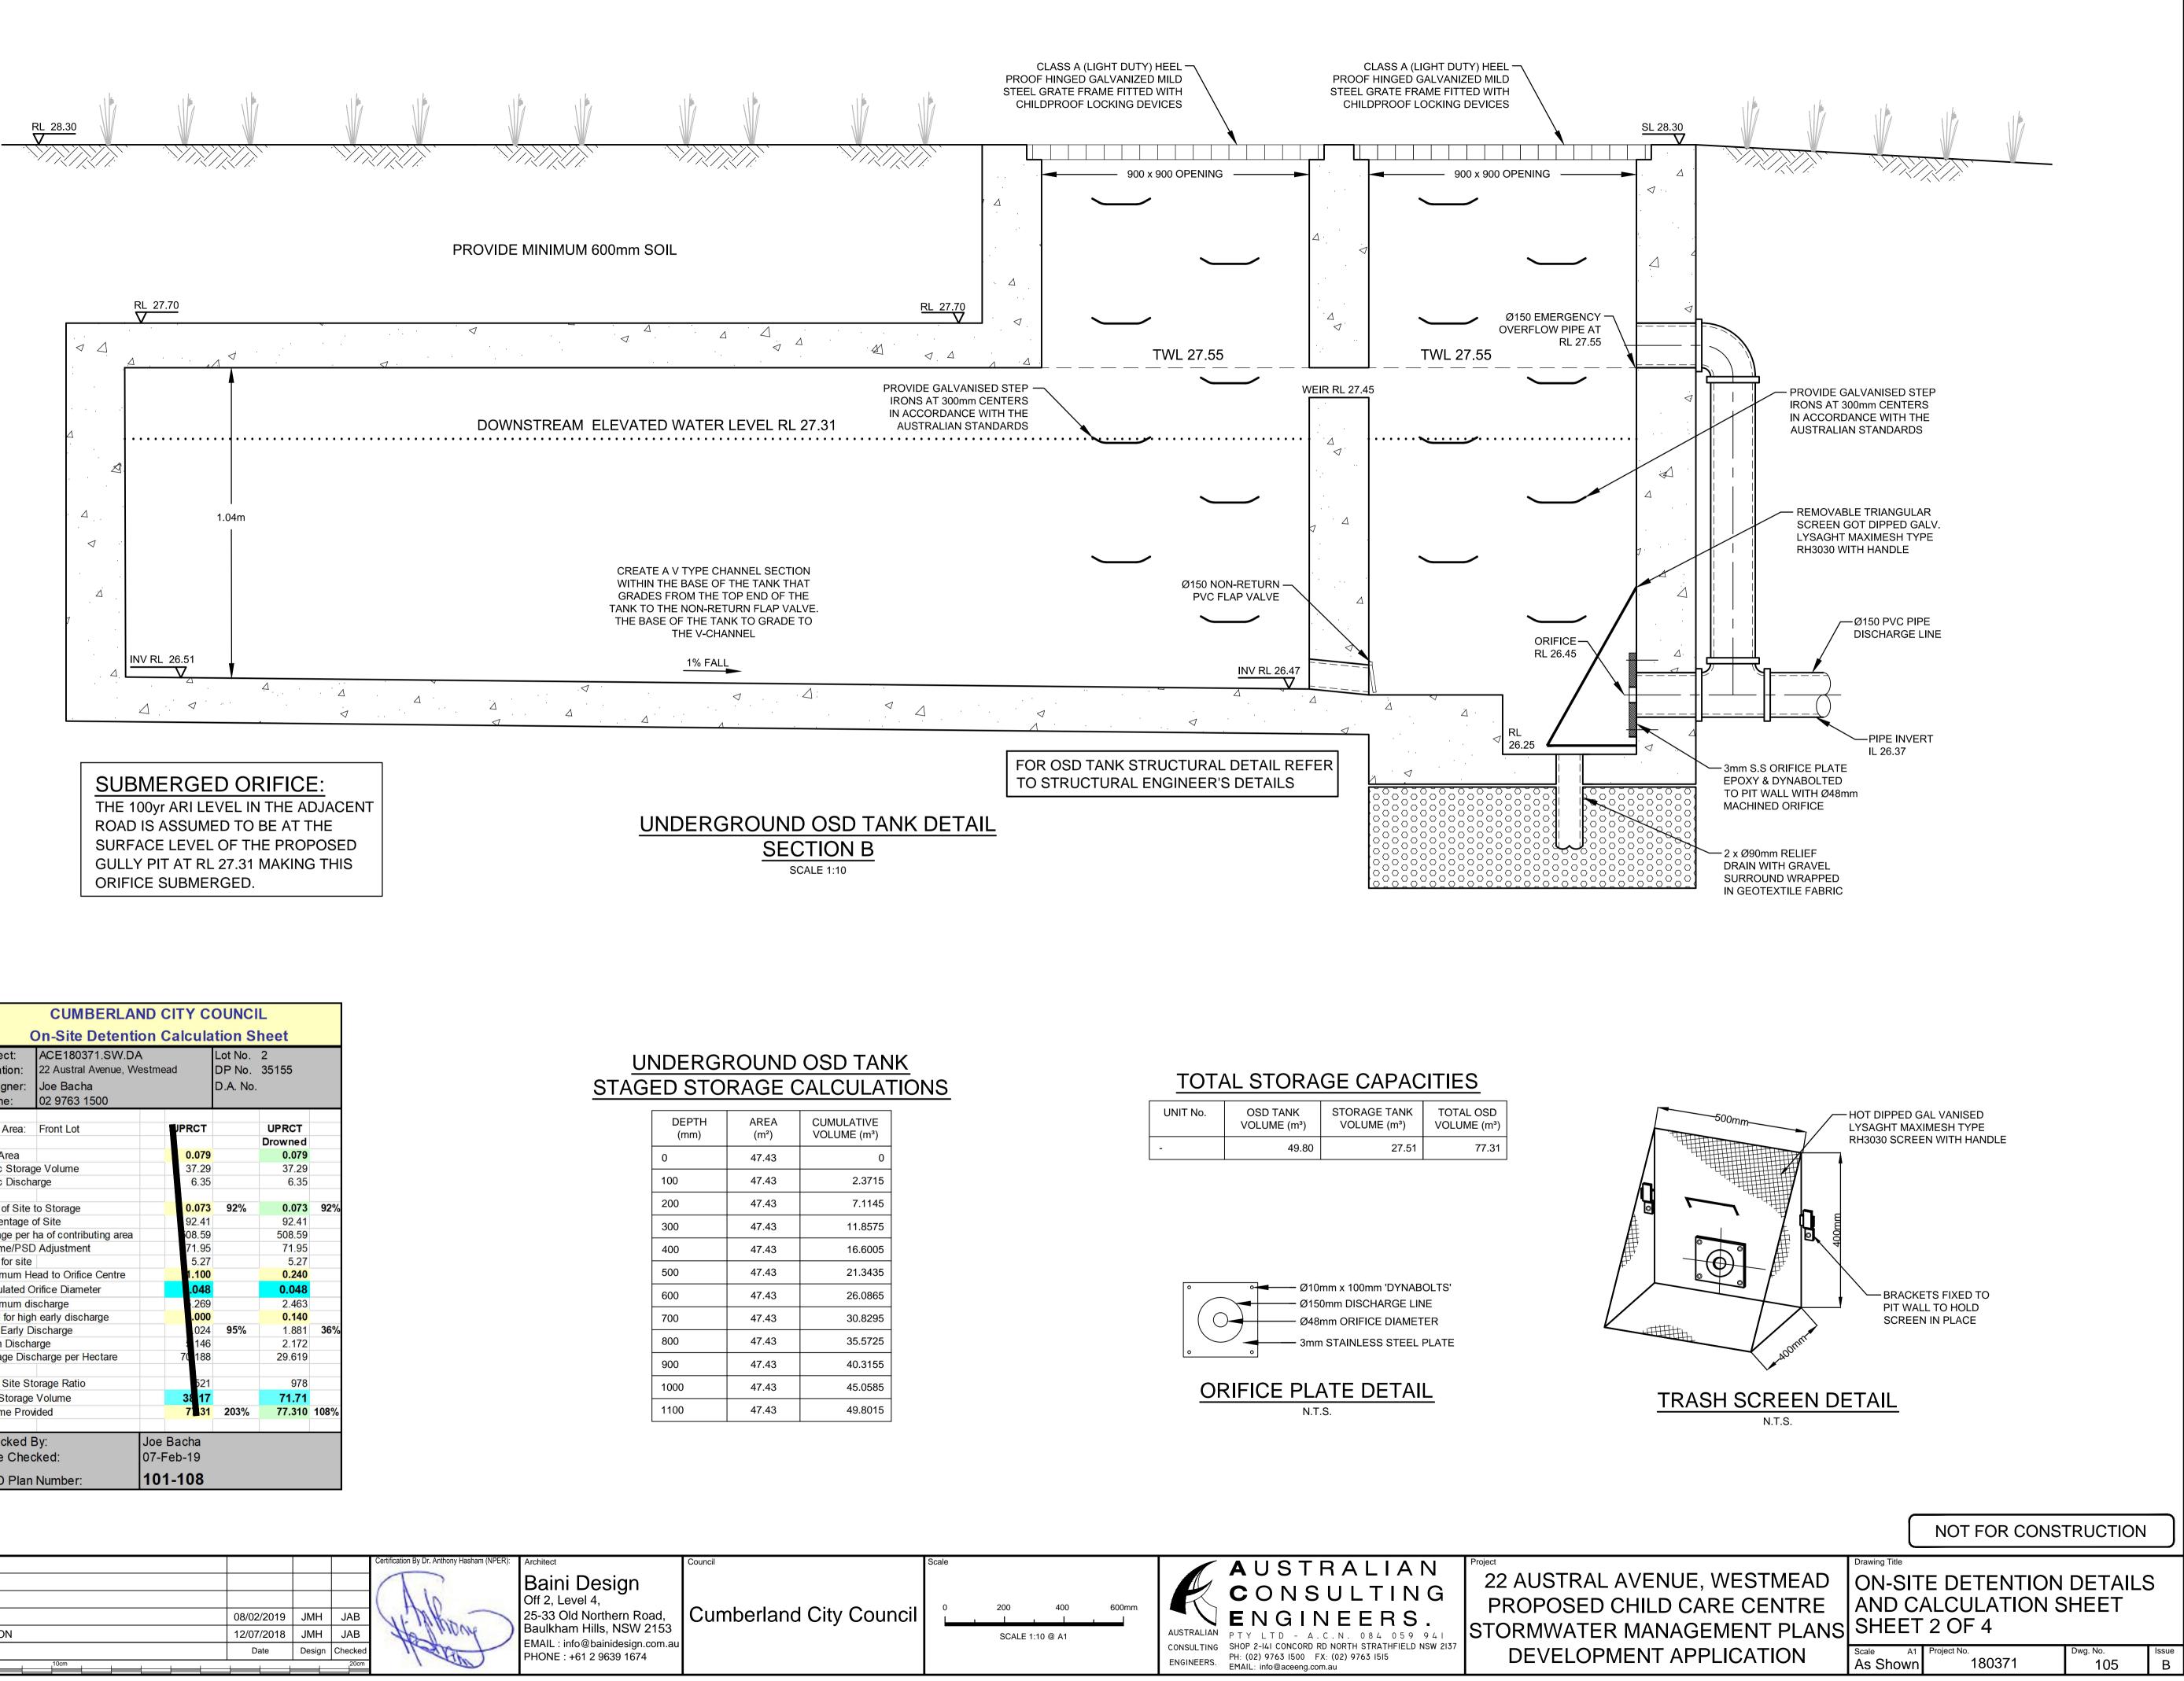UNIT No.	OSD TANK VOLUME (m³)	STORAGE TANK VOLUME (m³)	TOTAL OSD VOLUME (m ³)
-	49.80	27.51	77.31




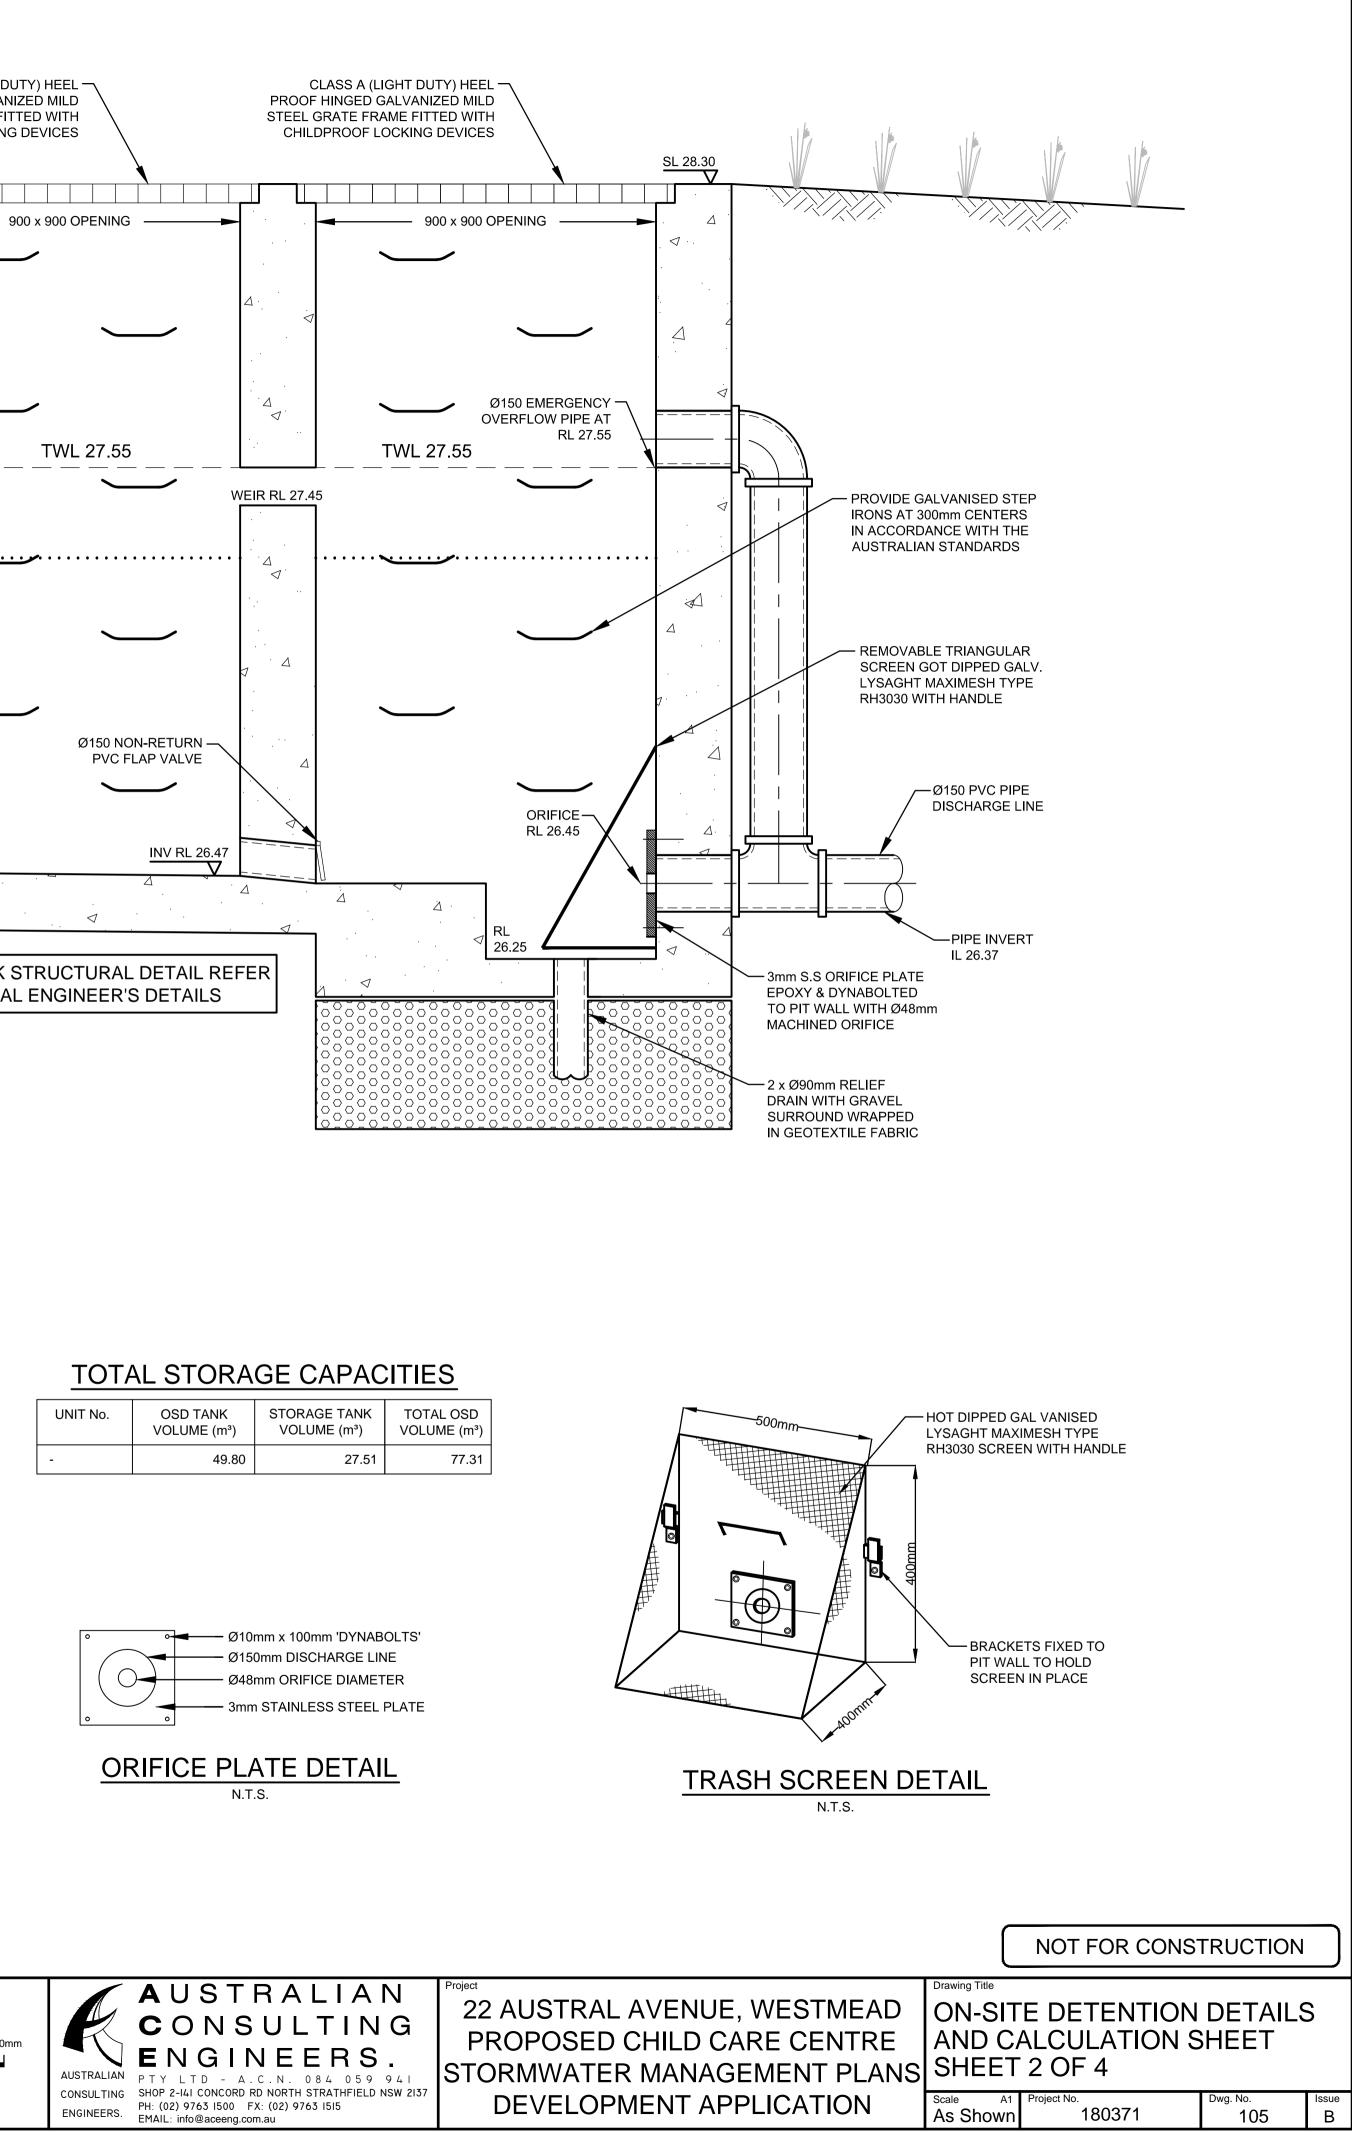

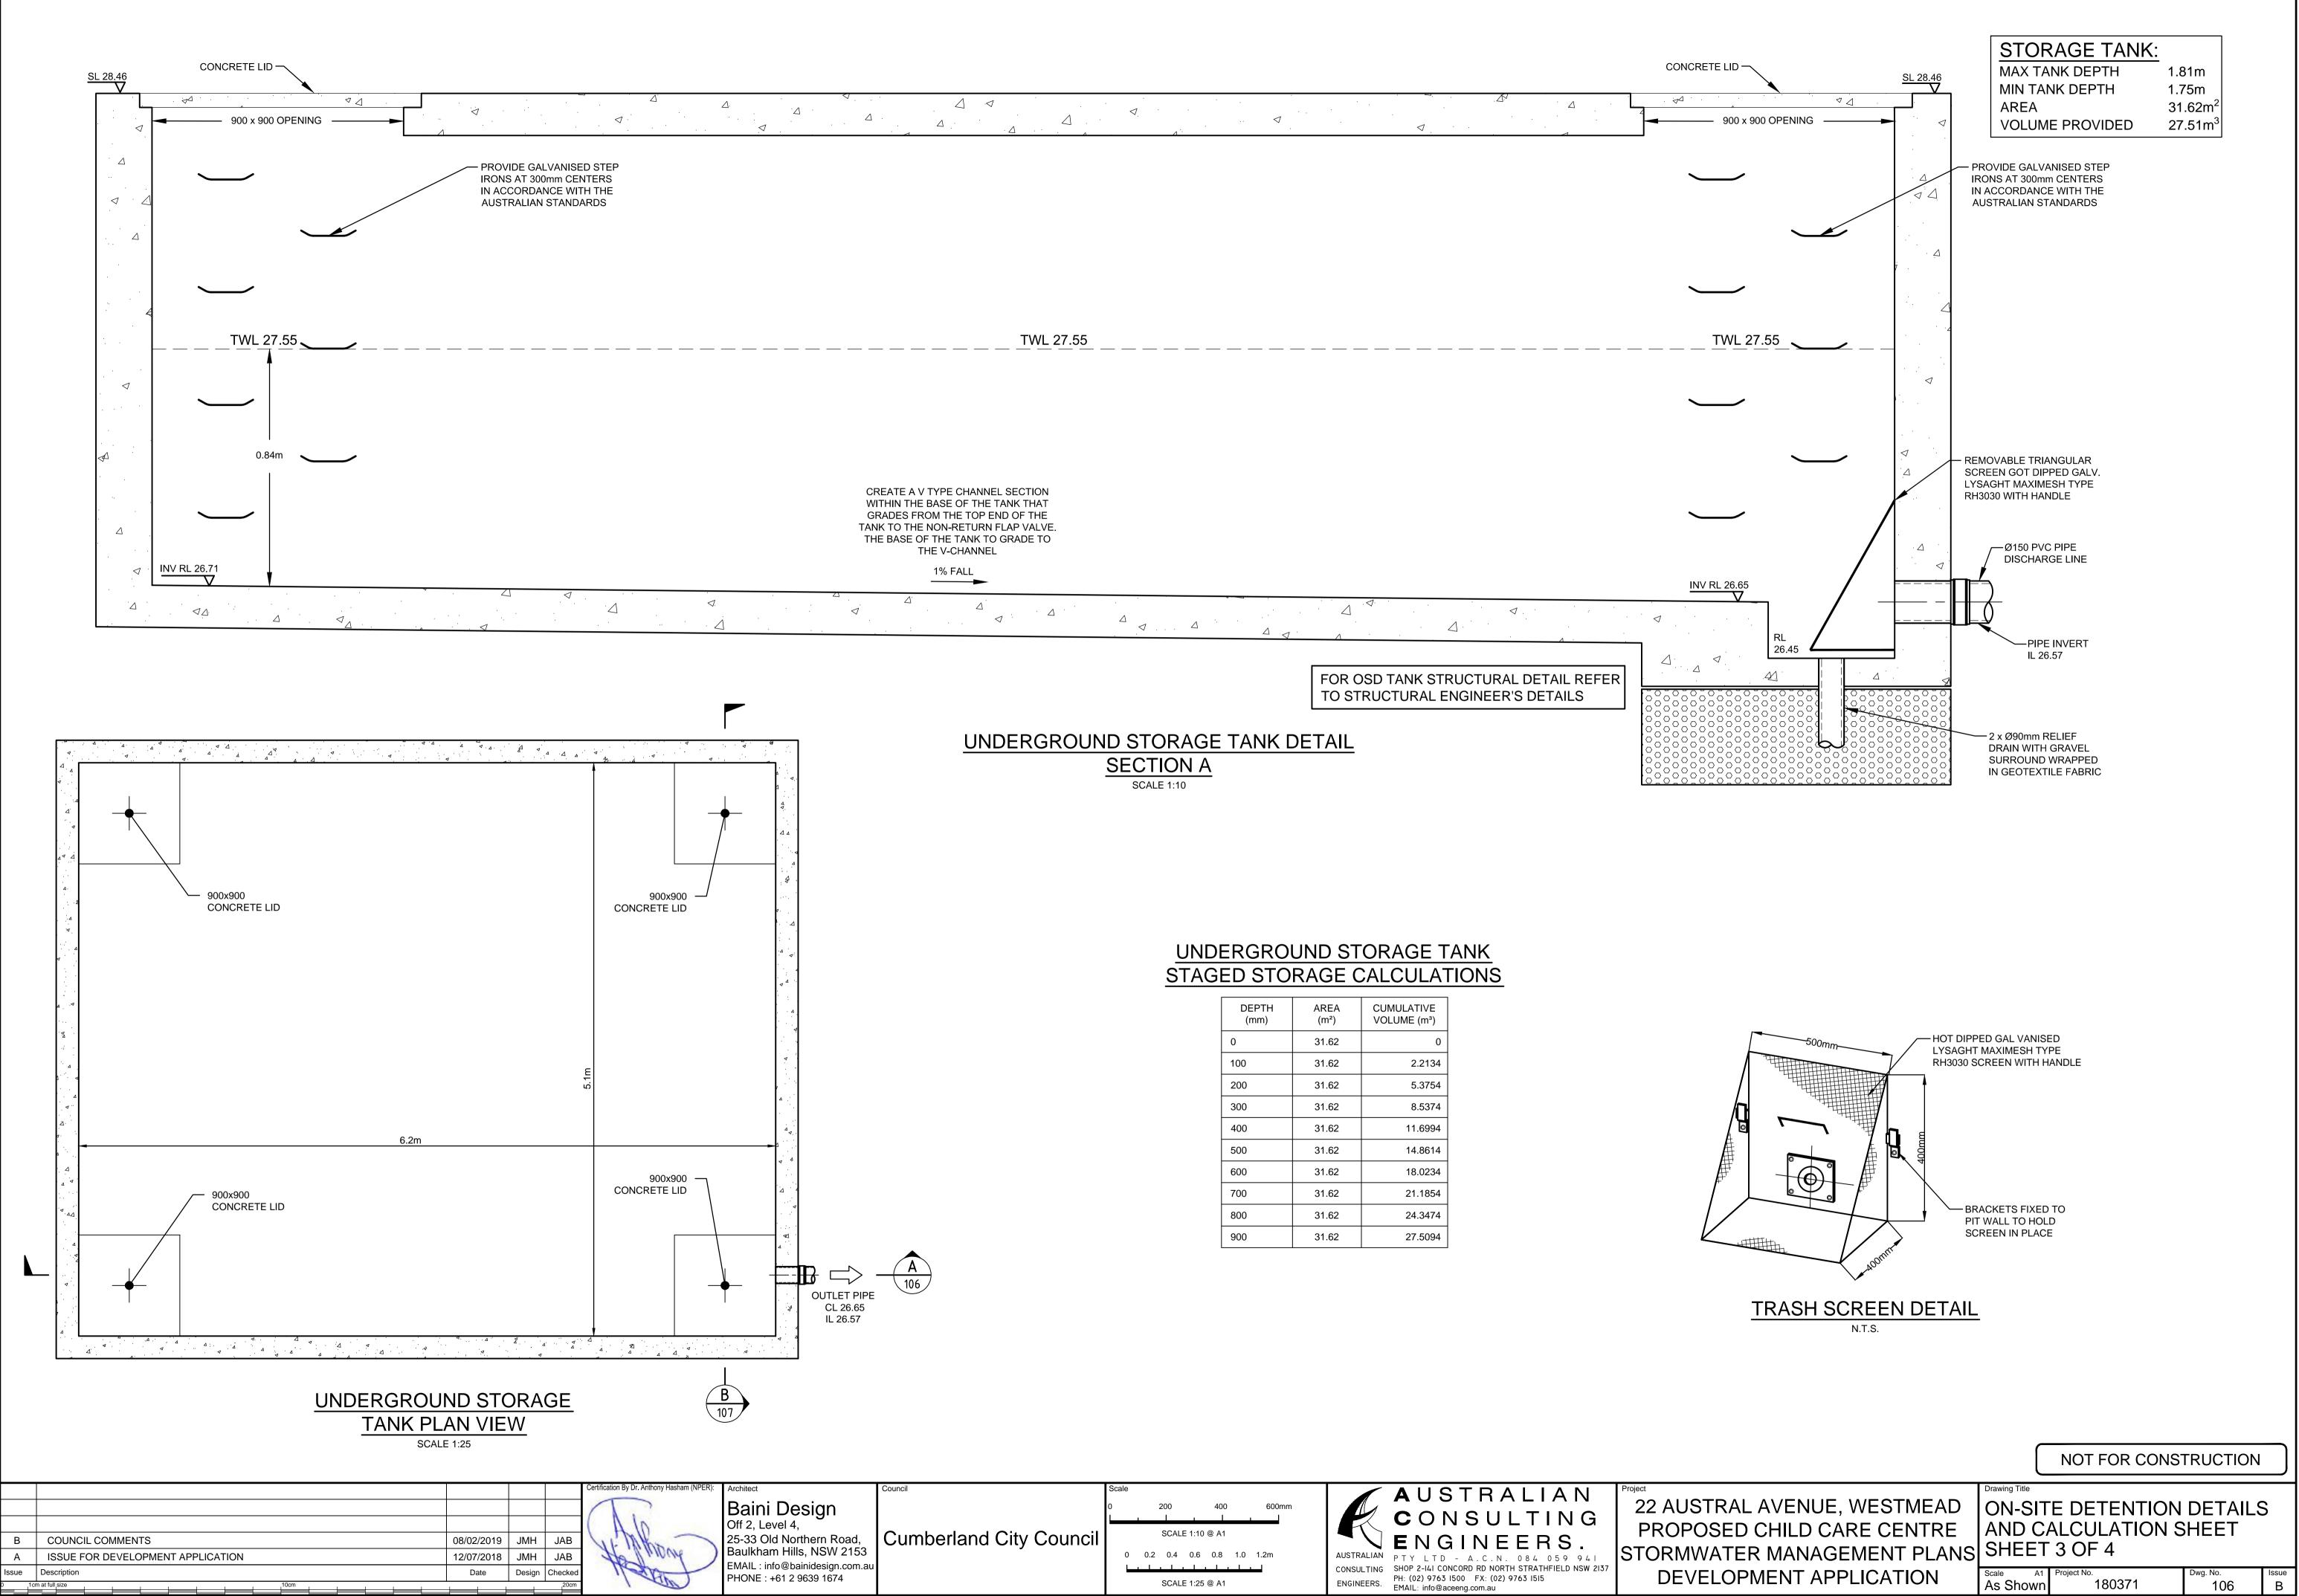


UNDERGROUND STORAGE TANK
STACED STOPACE CALCULATIONS

DEPTH (mm)	AREA (m²)	CUMULATIVE VOLUME (m ³)
0	31.62	0
100	31.62	2.2134
200	31.62	5.3754
300	31.62	8.5374
400	31.62	11.6994
500	31.62	14.8614
600	31.62	18.0234
700	31.62	21.1854
800	31.62	24.3474
900	31.62	27.5094

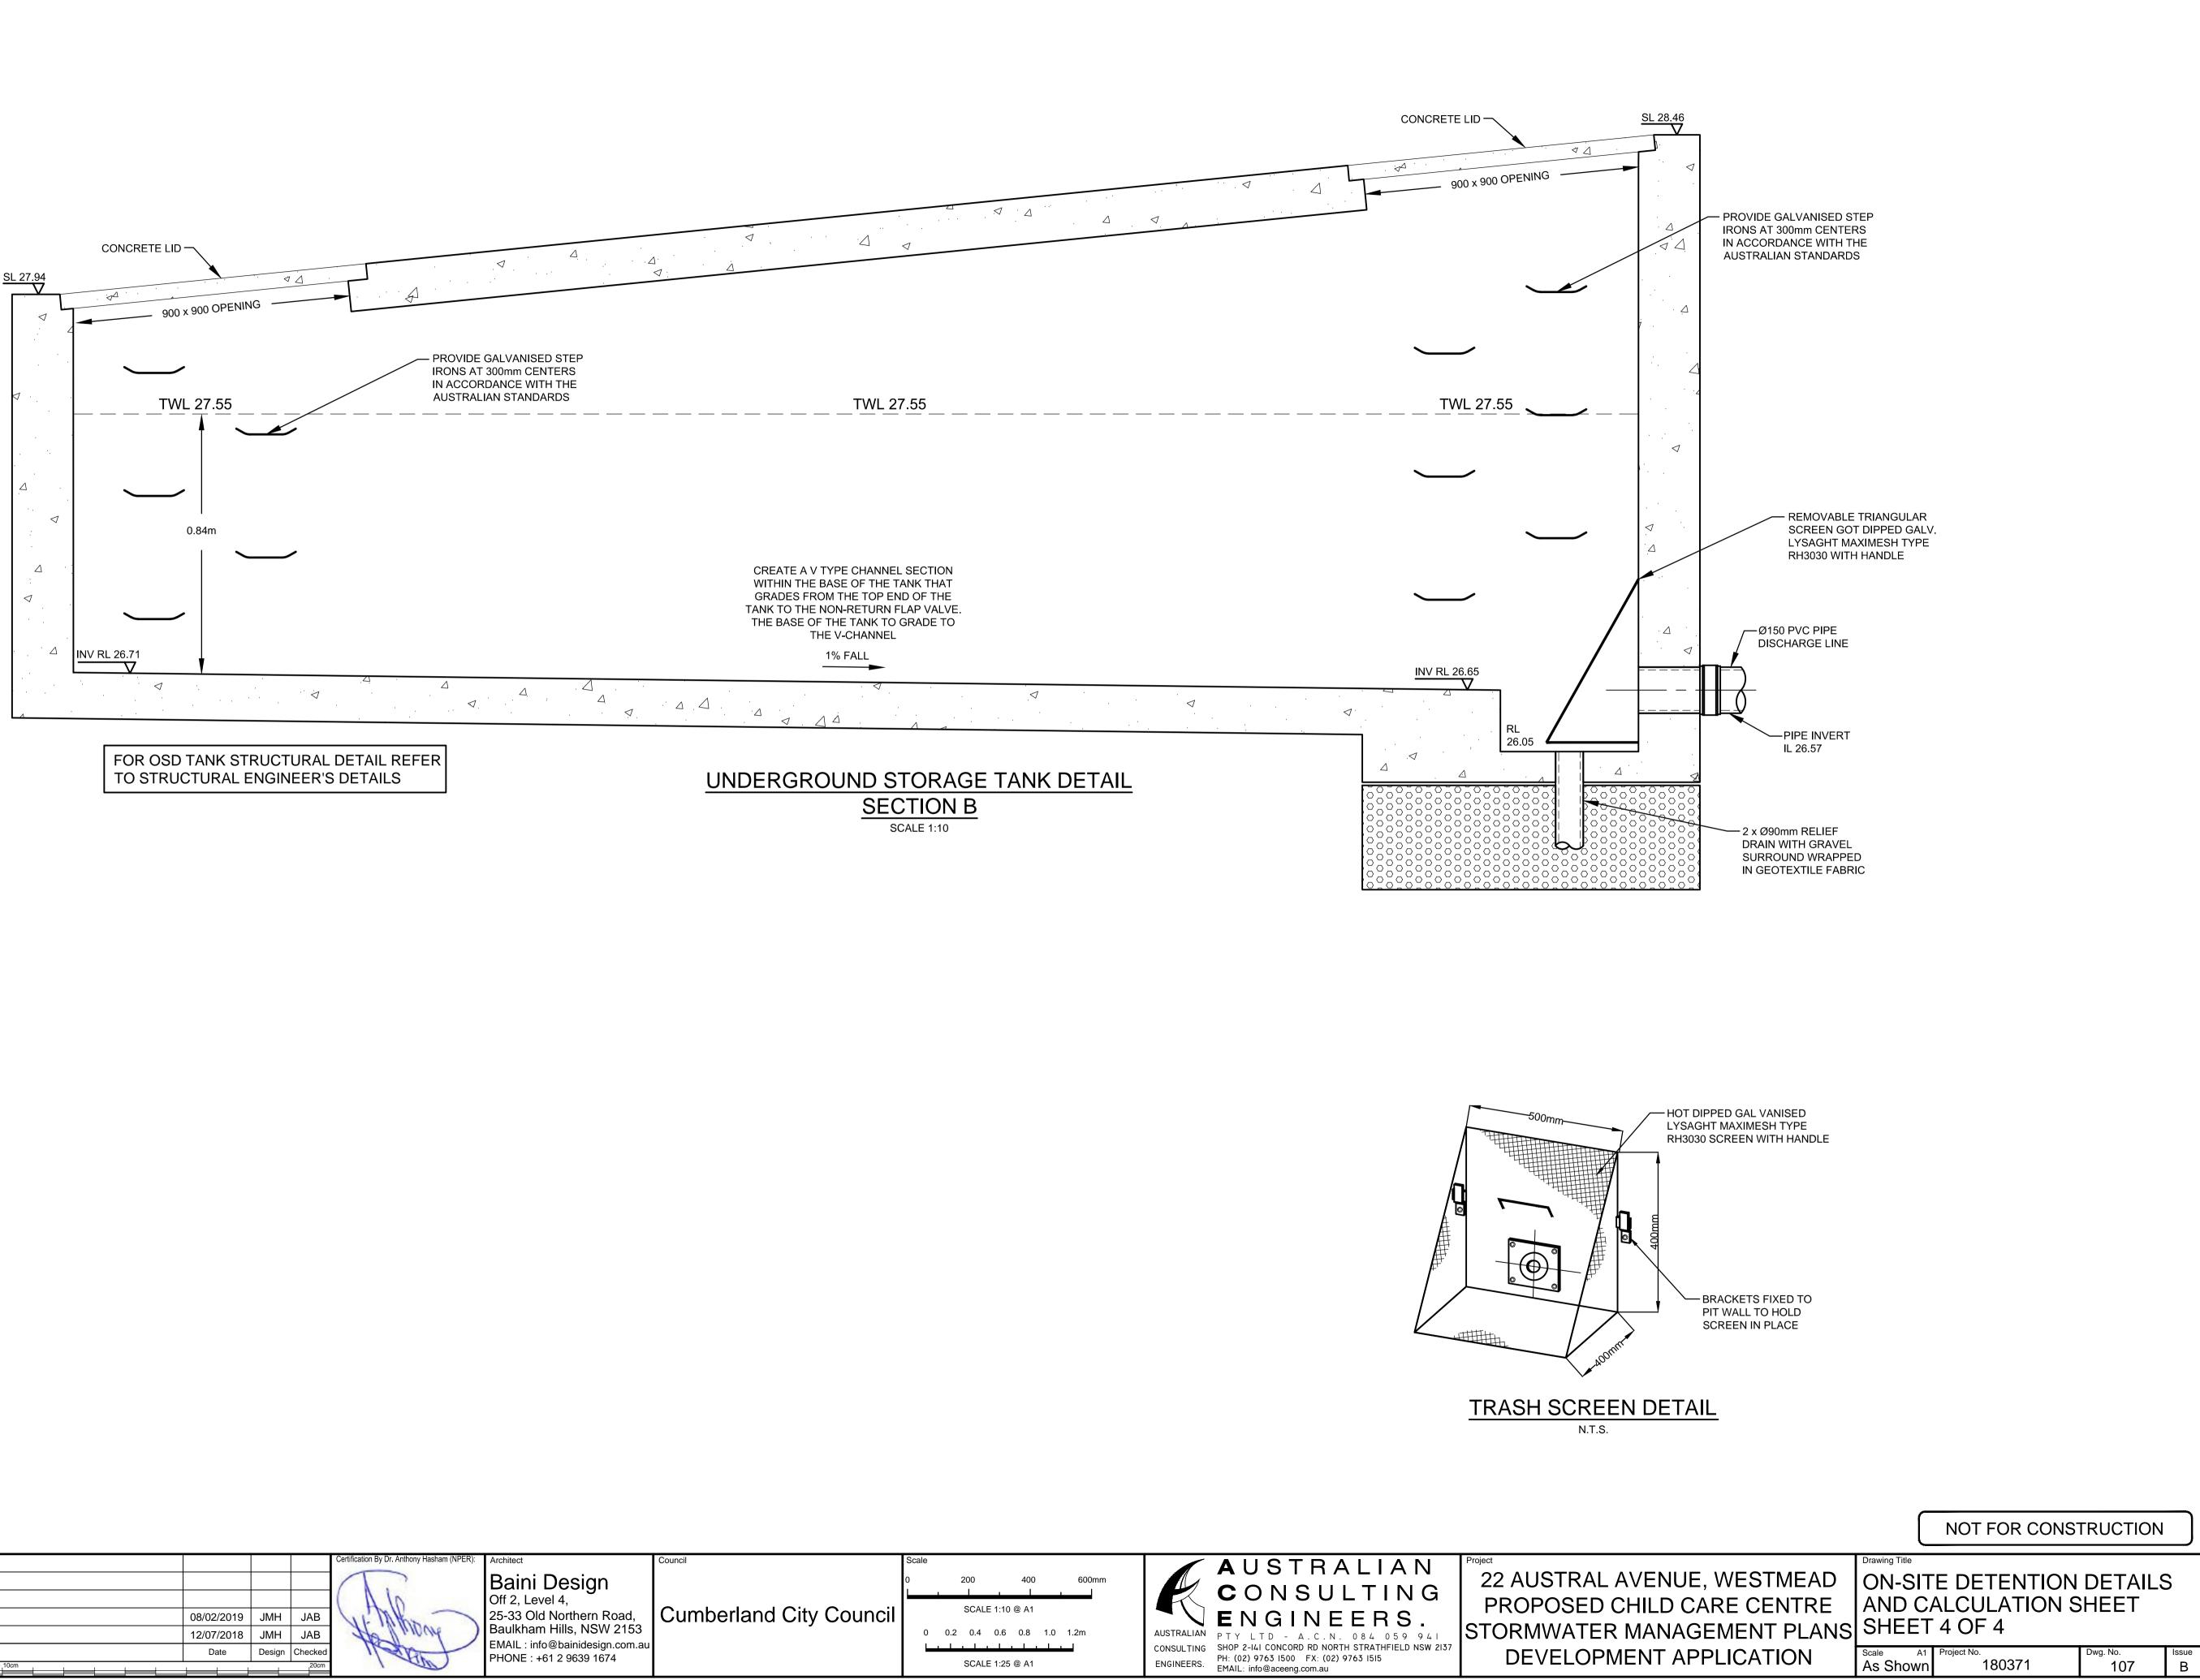


					Certification By Dr. Anthony Hasham (NPER):	Architect
					1	Baini Design
					() ()	Off 2, Level 4,
В	COUNCIL COMMENTS	08/02/2019	JMH	JAB	U. Alta	25-33 Old Northern R
А	ISSUE FOR DEVELOPMENT APPLICATION	12/07/2018	JMH	JAB	Ho I would	Baulkham Hills, NSW
Issue	Description	Date	Design	Checked	1 ABAT	EMAIL : info@bainidesign PHONE : +61 2 9639 167
0 1c	m at full size 10cm			20cm	1 00	

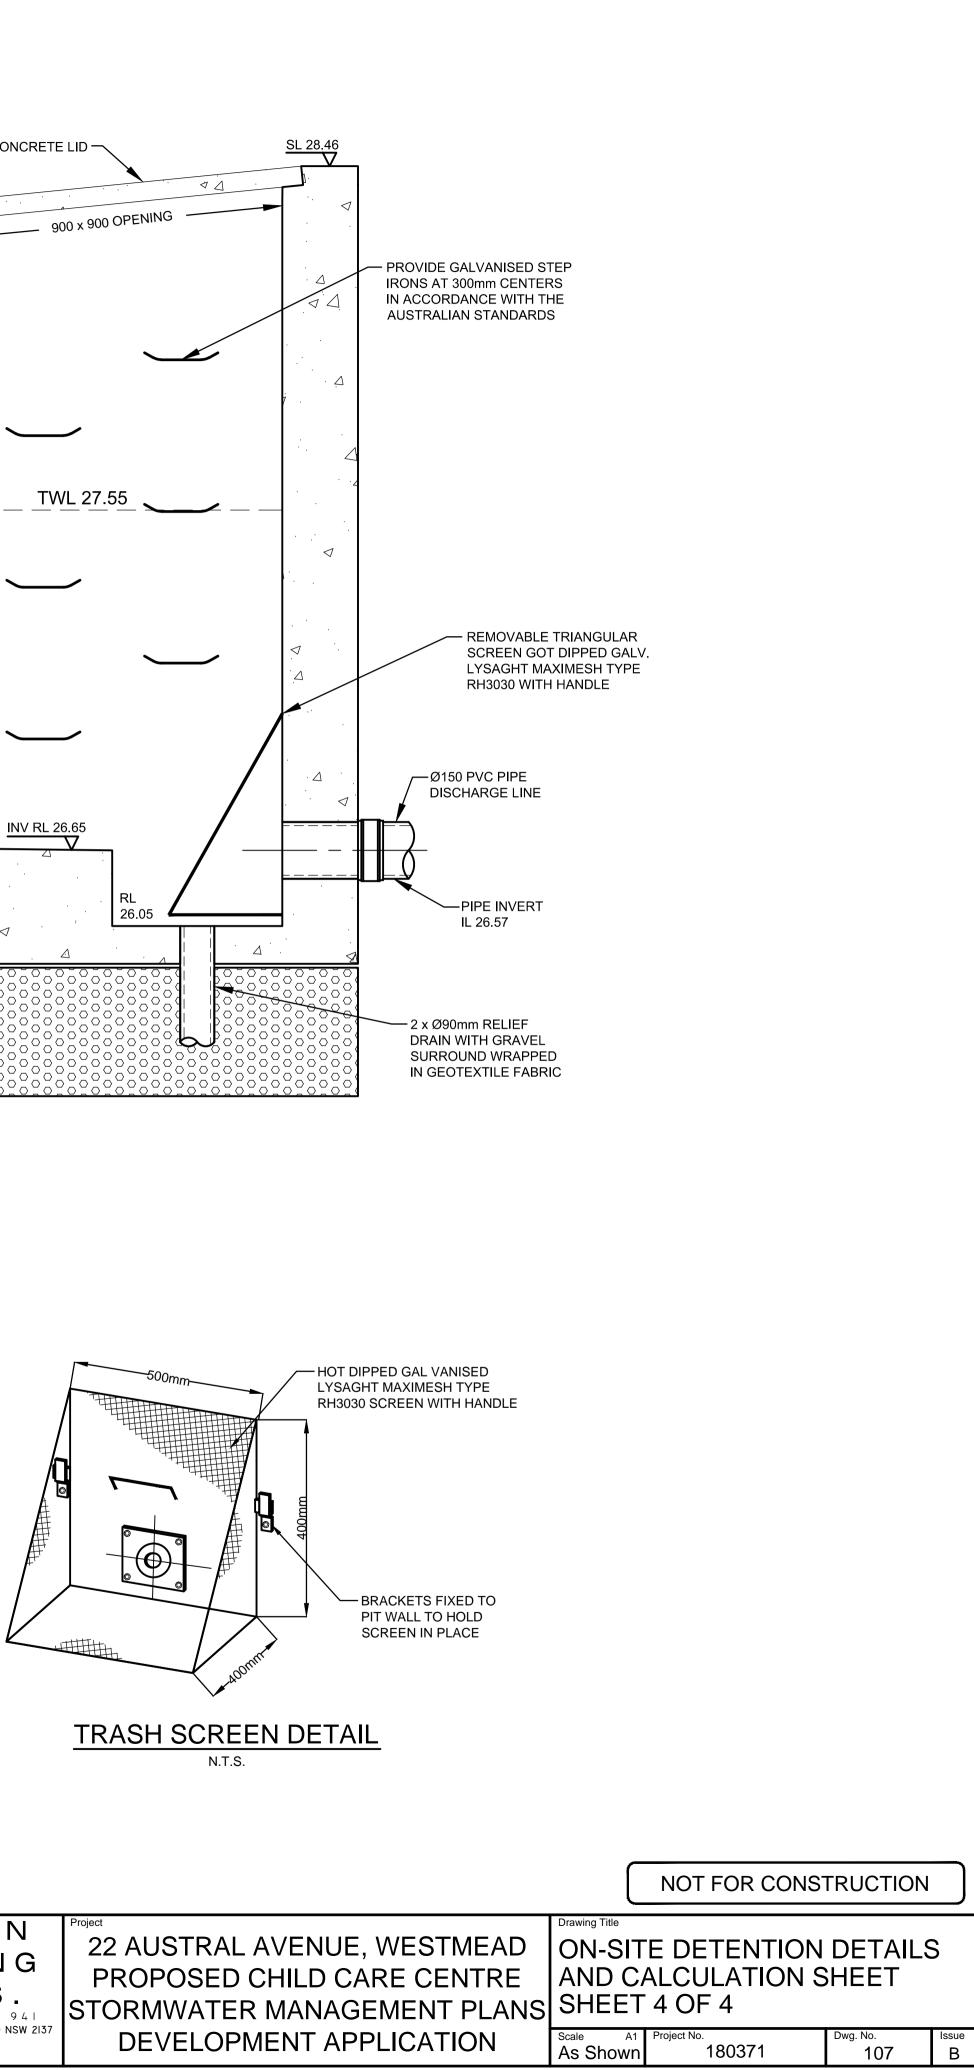





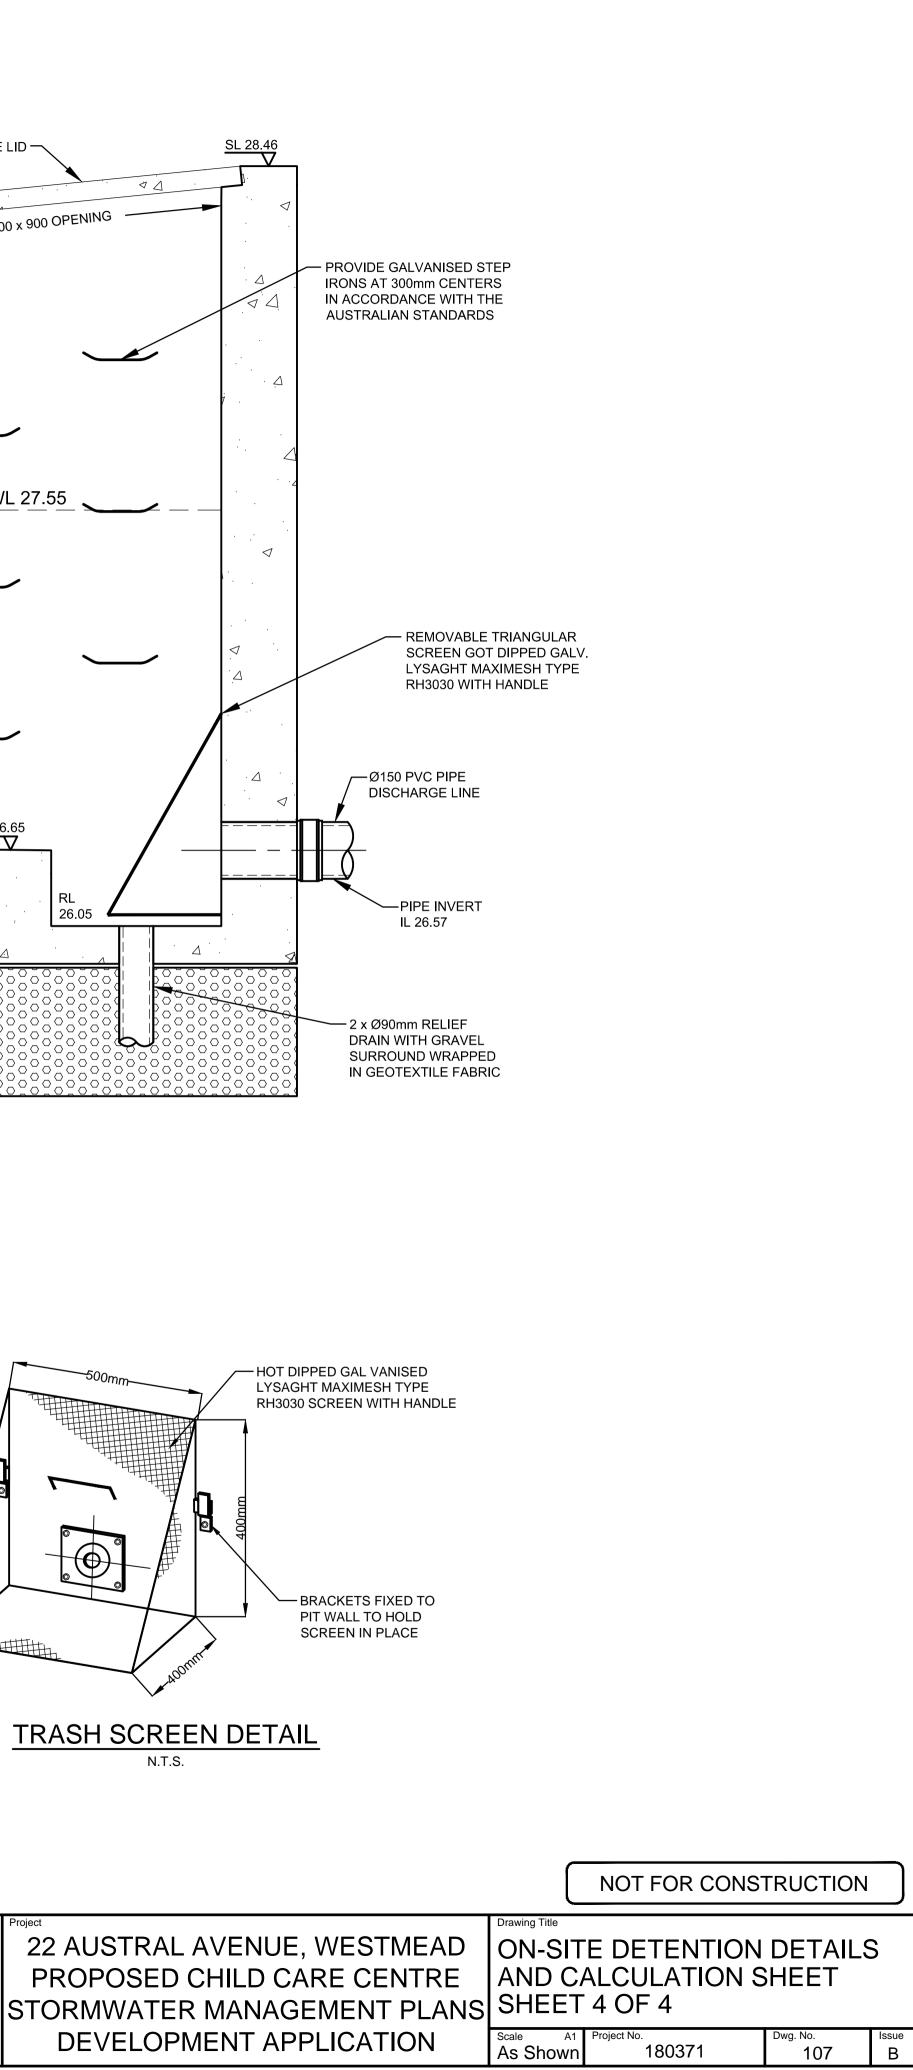

- COMMENCEMENT OF ANY CLEARING OR EARTHWORKS, THE CONTRACTOR AND SEDIMENT AND EROSION CONTROL MEASURES TO BE ADOPTED. THESE MEASURES SHALL BE IMPLEMENTED PRIOR TO ANY CLEARING OR EARTHWORKS AND MAINTAINED UNTIL THE WORKS ARE COMPLETED AND NO LONGER POSE AN EROSION HAZARD.
- 2. IMMEDIATELY FOLLOWING SETTING OUT OF THE WORKS, BUT PRIOR TO COMMENCEMENT OF ANY CLEARING OR EARTHWORKS, THE CONTRACTOR AND BE PRESERVED. NOTWITHSTANDING THE ABOVE, THE CONTRACTOR SHALL TAKE ALL GROUND COVER OUTSIDE THE MINIMUM AREAS REQUIRED TO COMPLETE THE WORKS AND SHALL BE RESPONSIBLE FOR RECTIFICATION, AT ITS OWN COST, OF ANY DISTURBANCE BEYOND THOSE AREAS.

- SILT AND TRAFFICKED DEBRIS FROM ENTERING THE STORMWATER SYSTEM.
- BOUNDARY STOCKPILES AND MAINTAINED THROUGH OUT CONSTRUCTION.
- THE SUPERINTENDENT.
- DIRECTED ON-SITE BY THE SUPERINTENDENT
- SITE BY THE SUPERINTENDENT.
- SUPERINTENDENT AND THE CONTRACTOR PRIOR TO ANY WORK COMMENCING.
- COMMENCING ON SITE. THE SUPERINTENDENT'S SURVEYOR SHALL PEG ALL PLACE BENCH MARKS. THE CONTRACTOR SHALL SET OUT THE WORKS FROM AND MAINTAIN THESE PEGS.
- CONTRACTORS WORKS etc.

